

HAZELTON DRIVE			
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L-102	SITE PLAN		
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A	ppendix - Hazelton Drive Rezoning Petition
Sheet Number	Sheet Title
RZ-1	TECHNICAL DATA SHEET
RZ-2	SCHEMATIC SITE PLAN
RZ-3	BUILDING ELEVATIONS

## NOTE:

**REVISIONS:** 


No. Date By


THE SITE PLAN SHOWN ON THE COVER IS FOR GENERAL REFERENCE. SEE SHEET L-101 FOR ADDITIONAL SITE DATA AND PLAN INFORMATION.

SCALE: 1"=20'

Description

COVER PAGE

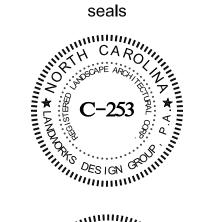

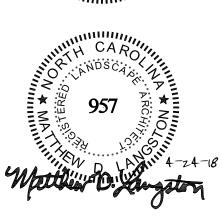

roject Manager:	MDL
rawn By:	SCJ

Checked By: MDL


Date: 4/24/18

Sheet Number:

Project Number:

L-001

SHEET#1 OF 10

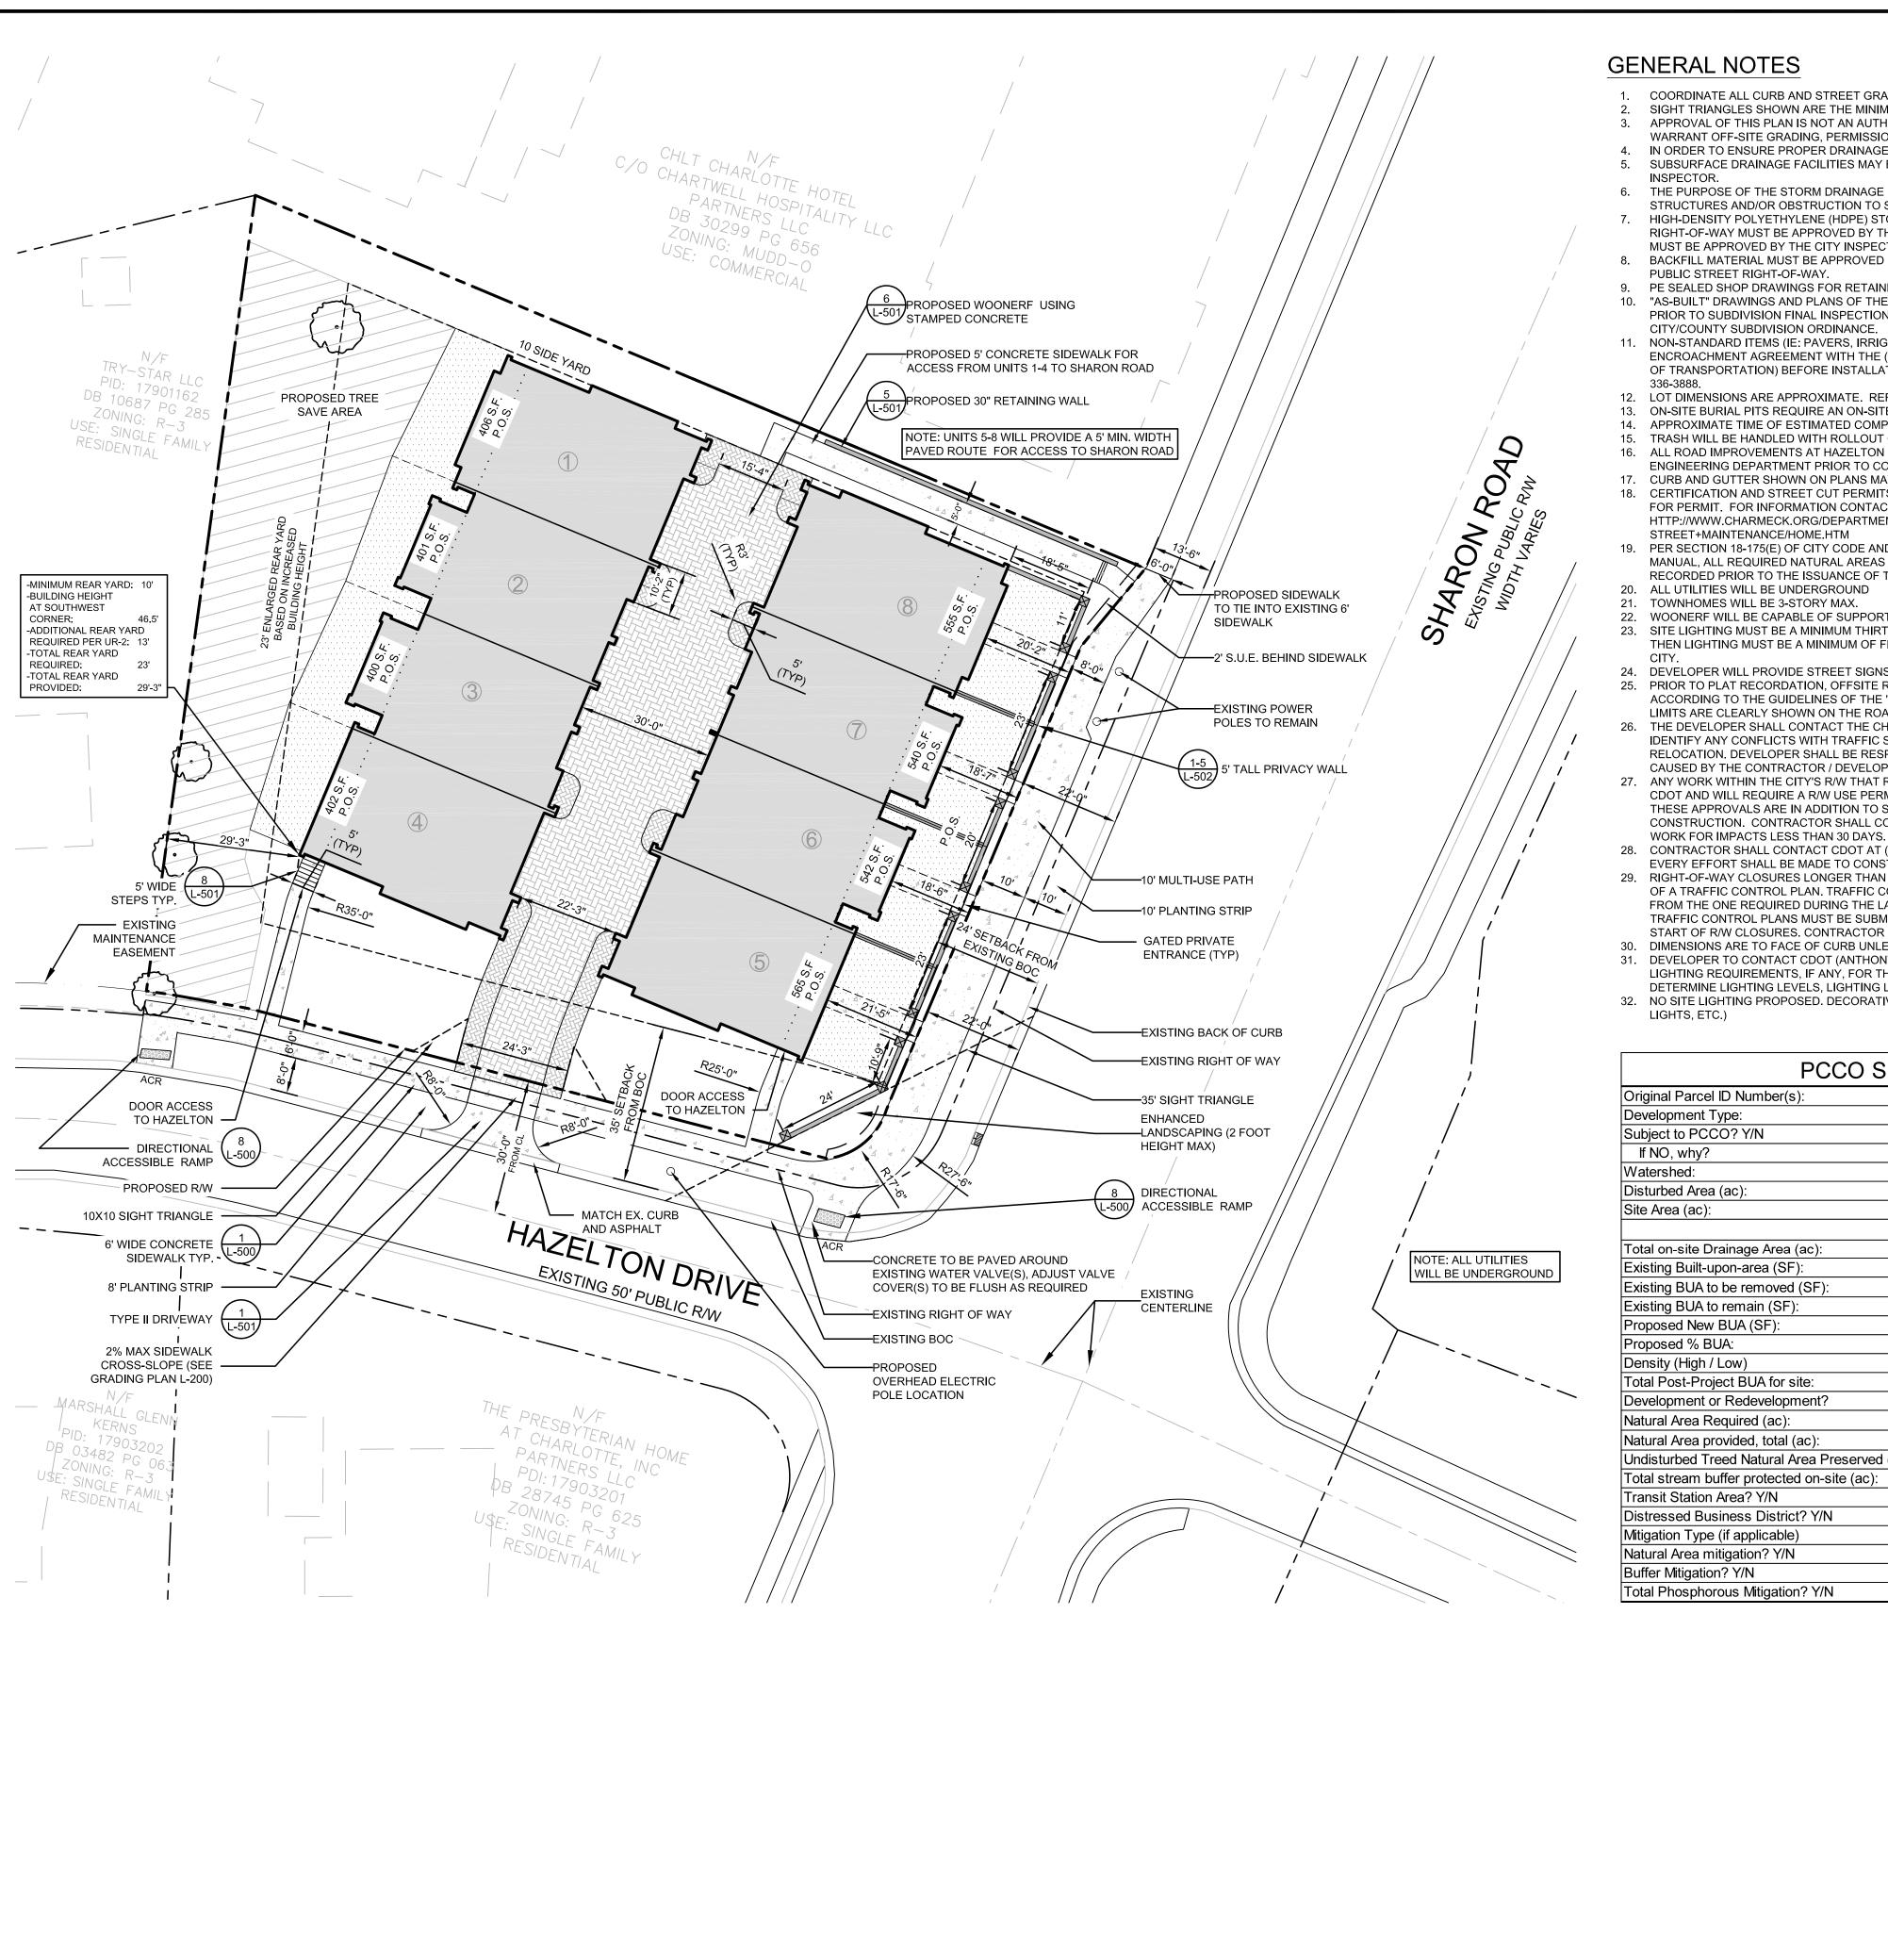

## **GENERAL NOTES**

- COORDINATE ALL CURB AND STREET GRADES IN INTERSECTION WITH INSPECTOR.
- SIGHT TRIANGLES SHOWN ARE THE MINIMUM REQUIRED.
- APPROVAL OF THIS PLAN IS NOT AN AUTHORIZATION TO GRADE ADJACENT PROPERTIES. WHEN FIELD CONDITIONS WARRANT OFF-SITE GRADING, PERMISSION MUST BE OBTAINED FROM THE AFFECTED PROPERTY OWNERS. IN ORDER TO ENSURE PROPER DRAINAGE, KEEP A MINIMUM OF 0.5% SLOPE ON THE CURB.
- SUBSURFACE DRAINAGE FACILITIES MAY BE REQUIRED IN THE STREET RIGHT-OF-WAY IF DEEMED NECESSARY BY THE
- THE PURPOSE OF THE STORM DRAINAGE EASEMENT (SDE) IS TO PROVIDE STORM WATER CONVEYANCE AND ANY STRUCTURES AND/OR OBSTRUCTION TO STORM WATER FLOW IS PROHIBITED.
- HIGH-DENSITY POLYETHYLENE (HDPE) STORM DRAINAGE PIPE INSTALLED WITHIN EXISTING OR PROPOSED PUBLIC STREET RIGHT-OF-WAY MUST BE APPROVED BY THE CITY'S INSPECTOR PRIOR TO ANY BACKFILL BEING PLACED. BACKFILL MATERIAL MUST BE APPROVED BY THE CITY INSPECTOR PRIOR TO PLACEMENT OF THE MATERIAL WITHIN THE PUBLIC RIGHT OF WAY. BACKFILL MATERIAL MUST BE APPROVED BY THE CITY INSPECTOR PRIOR TO PLACEMENT OF THE MATERIAL WITHIN THE PUBLIC STREET RIGHT-OF-WAY.
- 9. PE SEALED SHOP DRAWINGS FOR RETAINING WALL MUST BE SUBMITTED TO CITY ENGINEER PRIOR TO CONSTRUCTION. 10. "AS-BUILT" DRAWINGS AND PLANS OF THE STORM DRAINAGE SYSTEM, INCLUDING DESIGNED DITCHES, MUST BE SUBMITTED PRIOR TO SUBDIVISION FINAL INSPECTION TO THE CITY/COUNTY ENGINEERING DEPARTMENT IN ACCORDANCE WITH THE
- CITY/COUNTY SUBDIVISION ORDINANCE. 11. NON-STANDARD ITEMS (IE: PAVERS, IRRIGATION SYSTEMS, ETC.) IN THE RIGHT-OF-WAY REQUIRE A RIGHT-OF-WAY ENCROACHMENT AGREEMENT WITH THE (CHARLOTTE DEPARTMENT OF TRANSPORTATION/NORTH CAROLINA DEPARTMENT OF TRANSPORTATION) BEFORE INSTALLATION. FOR CITY OF CHARLOTTE MAINTAINED STREETS, CONTACT CDOT AT (704)
- 12. LOT DIMENSIONS ARE APPROXIMATE. REFERENCE RECORD PLAT FOR EXACT DIMENSIONS.
- 13. ON-SITE BURIAL PITS REQUIRE AN ON-SITE DEMOLITION LANDFILL PERMIT FROM THE ZONING ADMINISTRATOR 14. APPROXIMATE TIME OF ESTIMATED COMPLETION OF INFRASTRUCTURE: 9 MONTHS
- 15. TRASH WILL BE HANDLED WITH ROLLOUT CONTAINERS, TO BE SET IN THE PLANTING STRIP IN PUBLIC R.O.W. FOR DISPOSAL. 16. ALL ROAD IMPROVEMENTS AT HAZELTON DRIVE & SHARON ROAD ARE TO BE COORDINATED WITH CITY OF CHARLOTTE
- ENGINEERING DEPARTMENT PRIOR TO CONSTRUCTION. 17. CURB AND GUTTER SHOWN ON PLANS MAY BE ADJUSTED BASED UPON FIELD CONDITIONS.
- 18. CERTIFICATION AND STREET CUT PERMITS ARE REQUIRED FOR UTILITY CUTS ON CITY STREETS. ALLOW 7 DAYS PROCESSING FOR PERMIT. FOR INFORMATION CONTACT CHARLOTTE DEPARTMENT OF TRANSPORTATION (704-336-4025) OR VISIT HTTP://WWW.CHARMECK.ORG/DEPARTMENTS/TRANSPORTATION/ STREET+MAINTENANCE/HOME.HTM
- 19. PER SECTION 18-175(E) OF CITY CODE AND SECTION 10.0 OF THE CITY'S POST CONSTRUCTION CONTROLS ADMINISTRATIVE MANUAL, ALL REQUIRED NATURAL AREAS AND/OR POST CONSTRUCTION CONTROLS EASEMENTS (PCCES) MUST BE RECORDED PRIOR TO THE ISSUANCE OF THE CERTIFICATE OF OCCUPANCY.
- 20. ALL UTILITIES WILL BE UNDERGROUND 21. TOWNHOMES WILL BE 3-STORY MAX.
- 22. WOONERF WILL BE CAPABLE OF SUPPORTING 80,000 POUNDS
- 23. SITE LIGHTING MUST BE A MINIMUM THIRTY (30) FEET AWAY FROM A TREE. IF PEDESTRIAN SCALE LIGHTING IS BEING USED, THEN LIGHTING MUST BE A MINIMUM OF FIFTEEN (15) FEET AWAY FROM A TREE, UNLESS APPROVED OTHERWISE BY THE
- 24. DEVELOPER WILL PROVIDE STREET SIGNS PER CLDSM #50.05 (9" SIGNS ONLY).
- 25. PRIOR TO PLAT RECORDATION, OFFSITE R/W AND / OR CONSTRUCTION EASEMENTS ARE REQUIRED TO BE OBTAINED ACCORDING TO THE GUIDELINES OF THE "OFFSITE R/W ACQUISITION PROCESS". THESE NEEDED R/W AND CONSTRUCTION LIMITS ARE CLEARLY SHOWN ON THE ROADWAY IMPROVEMENT PLAN.
- 26. THE DEVELOPER SHALL CONTACT THE CHARLOTTE DEPARTMENT OF TRANSPORTATION (GUS JORDI, 704-336-7086) TO IDENTIFY ANY CONFLICTS WITH TRAFFIC SIGNALIZATION EQUIPMENT. 60 - 90 DAYS WILL BE REQUIRED TO COORDINATE RELOCATION. DEVELOPER SHALL BE RESPONSIBLE FOR ALL RELATED RELOCATION COST AND / OR ANY REPAIR COST
- CAUSED BY THE CONTRACTOR / DEVELOPER. 27. ANY WORK WITHIN THE CITY'S R/W THAT REQUIRES CLOSURE OF A SIDEWALK OR TRAVEL LANE MUST BE APPROVED BY CDOT AND WILL REQUIRE A R/W USE PERMIT OR R/W LEASE DEPENDING UPON THE PROPOSED DURATION OF CLOSURE. THESE APPROVALS ARE IN ADDITION TO SITE APPROVALS AND SHOULD BE COORDINATED WITH CDOT PRIOR TO CONSTRUCTION. CONTRACTOR SHALL CONTACT CDOT AT (704) 432-1562 AT LEAST 5 BUSINESS DAYS PRIOR TO BEGINNING
- 28. CONTRACTOR SHALL CONTACT CDOT AT (704) 336-8348 AS SOON AS POSSIBLE FOR IMPACTS GREATER THAN 30 DAYS. EVERY EFFORT SHALL BE MADE TO CONSTRUCT IMPROVEMENTS WITH MINIMAL IMPACT TO DRIVERS AND PEDESTRIANS.
- RIGHT-OF-WAY CLOSURES LONGER THAN 30 DAYS REQUIRE A R/W LEASE AGREEMENT WHICH WILL INCLUDE THE SUBMITTAL OF A TRAFFIC CONTROL PLAN. TRAFFIC CONTROL PLANS REQUIRED THROUGH A LEASE AGREEMENT MAY BE DIFFERENT FROM THE ONE REQUIRED DURING THE LAND DEVELOPMENT PLAN REVIEW AND ARE SUBJECT TO REVISIONS. THE REVISED TRAFFIC CONTROL PLANS MUST BE SUBMITTED AS PART OF THE LEASE AGREEMENT PROCESS FOR APPROVAL PRIOR TO
- START OF R/W CLOSURES. CONTRACTOR SHALL CONTACT CDOT AT (704) 336-2562. 30. DIMENSIONS ARE TO FACE OF CURB UNLESS NOTED OTHERWISE.

PCCO SUMMARY

- 31. DEVELOPER TO CONTACT CDOT (ANTHONY MENDEZ: 704-336-4971) DURING SITE PLAN PREPARATION TO DISCUSS STREET LIGHTING REQUIREMENTS, IF ANY, FOR THIS PROJECT. COORDINATE WITH DUKE ENERGY AND CDOT AS NECESSARY TO DETERMINE LIGHTING LEVELS, LIGHTING LAYOUT AND REQUIREMENTS FOR INSTALLATION.
- 32. NO SITE LIGHTING PROPOSED. DECORATIVE, ARCHITECTURAL LIGHTING ONLY ON BUILDING (SCONCES ON WALL, PORCH LIGHTS, ETC.)

Original Parcel ID Number(s):	17901164, 17901163	
Development Type:	Multi-Family	
Subject to PCCO? Y/N	N	
If NO, why?	Below BUA/Disturbance Thresholds	
Watershed:	Central Catawba	
Disturbed Area (ac):	0.67	
Site Area (ac):	0.725	
	DA#1	
Total on-site Drainage Area (ac):	0.18	
Existing Built-upon-area (SF):	6610	
Existing BUA to be removed (SF):	6610	
Existing BUA to remain (SF):	0	
Proposed New BUA (SF):	19,861	
Proposed % BUA:	63%	
Density (High / Low)	HIGH	
Total Post-Project BUA for site:		
Development or Redevelopment?	Development	
Natural Area Required (ac):	0.11	
Natural Area provided, total (ac):	0.11	
Undisturbed Treed Natural Area Preserved (ac):		
Total stream buffer protected on-site (ac):	0	
Transit Station Area? Y/N	N	
Distressed Business District? Y/N	N	
Mitigation Type (if applicable)	N/A	
Natural Area mitigation? Y/N	N	
Buffer Mitigation? Y/N	N	
Total Phosphorous Mitigation? Y/N	N	

## **DEVELOPMENT DATA:**

TAX PARCEL ID: **EXISTING SITE AREA:** EXISTING ZONING: **ZONING PETITION:** JURISDICTION: **EXISTING USE:** PROPOSED USE:

2017-131 City of Charlotte Residential Single-Family attached Townhomes (For Sale)

11.11 UNITS / AC

±0.725 ACRES

UR-2(CD)

8 Units

47'

17901164, 17901163

UNITS ALLOWED: **UNITS PROPOSED: DENSITY PROPOSED:** 

**BUILDING FRONT YARD:** BUILDING SIDE YARD: **BUILDING REAR YARD:** 

SETBACKS:

PER PLAN

Up to 8 Townhome Units

35' FROM EXISTING BACK OF **CURB ON HAZELTON DRIVE** 24' FROM EXISTING BACK OF CURB ON SHARON ROAD

400' SF MIN PER UNIT (THIS PRIVATE OPEN SPACE:

MAY INCLUDE PORTIONS OF TREE SAVE)

MAX. BUILDING HEIGHT: PROPOSED BUILDING HEIGHT:

47' MAX PER TABLE 9.406(2)(A) OF THE ZONING ORDINANCE, ONE ADDITIONAL FOOT OF HEIGHT IS ALLOWED FOR EVERY ADDITIONAL TWO FEET IN DISTANCE THE PORTION OF THE BUILDING IS FROM THE REQUIRED SETBACK, SIDE, AND REAR YARD LINES LOCATED ALONG ALL BOUNDARY(S) ADJACENT TO A SINGLE FAMILY ZONING DISTRICT (To accommodate

PARKING REQUIRED: PARKING PROVIDED:

2 car attached garage at each unit Total= 16 spaces in garages

1.5 Spaces Per Unit

15% = 4,738 SF

foundation wall height at

southwest corner (Unit 4))

MAX. FLOOR RATIO AREA: PROP. FLOOR AREA RATIO:

COMPLETE CONSTRUCTION:

TREE SAVE REQUIRED:

1.0 1.0 MAX

WASTE MANAGEMENT: ROLLOUT CONTAINER TO CURBSIDE OF HAZELTON

DRIVE MIN. 10'

PROPOSED WALL

PROPOSED PERMEABLE

PROPOSED TOWNHOME

PROPOSED TREE SAVE AREA

EXISTING TREE TO REMAIN

Description

SCALE: 1"=20'

MODULAR PAVERS

PROPOSED BRICK PAVED WOONERF

PROPOSED PRIVATE OPEN SPACE


PROPOSED CONCRETE SIDEWALK

**BUILDING SEPARATION:** PROJECT TIMELINE: START: Q1 2018

FINISH: Q2 2019 (SITEWORK)

SITE PLAN

C-253

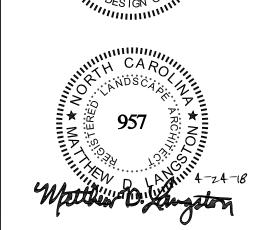

Project Manager

MDL

4/24/18

Drawn By:

Checked By:

Project Number:

Date:

Sheet Number:

L-102

SHEET#3 OF 10

**WARNING!** 

CALL NC ONE CAL

LEGEND

PROPOSED RIGHT OF WAY

— – – EXISTING RIGHT-OF-WAY

EXISTING CUR AND GUTTER

PROPOSED POWER POLE

EXISTING ALUMINUM FENCE

ACCESSIBLE CURB RAMP

SIDEWALK UTILITY EASEMENT

**REVISIONS:** 

No. Date By

----- 2' SIDEWALK UTILITY EASEMENT

RELOCATION

---- PROPOSED SETBACK

— — — ROAD CENTERLINE

\_\_x\_\_\_x\_\_\_x\_\_\_x\_\_\_

ACR

S.U.E.

· · · · · · · · · EDGE OF INNER BUILDING

This Plan Is A

**Preliminary Design** NOT Released For

Construction.