

PRELIMINARY PLANNED
MULTI-FAMILY SUBDIVISION
APPROVAL
CHARLOTTE-MECKLENBURG PLANNING DEPARTMENT
By Brent Wilkinson 2/15/18

## FAISON AVE. HOMES

## CHARLOTTE, NORTH CAROLINA

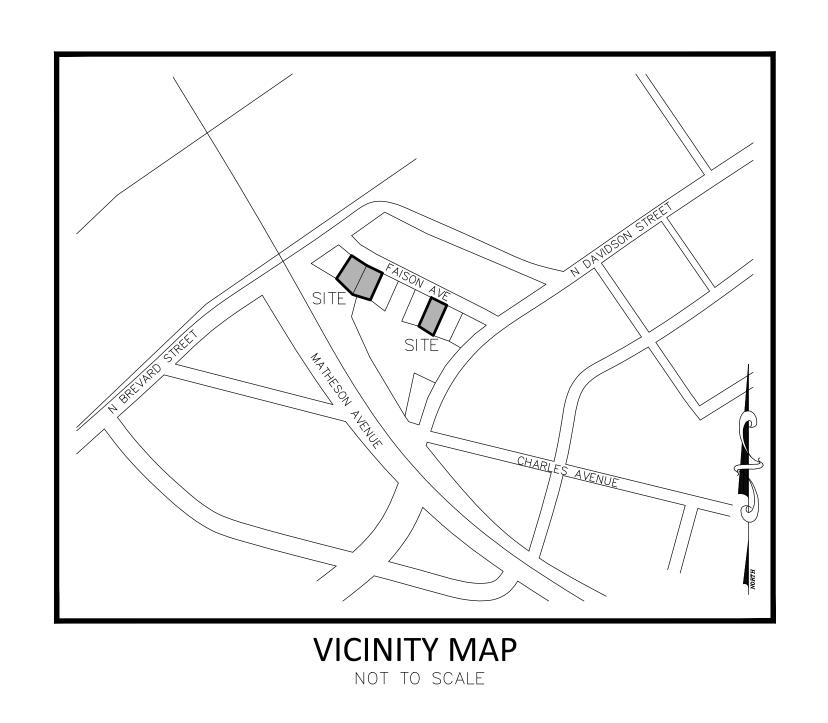

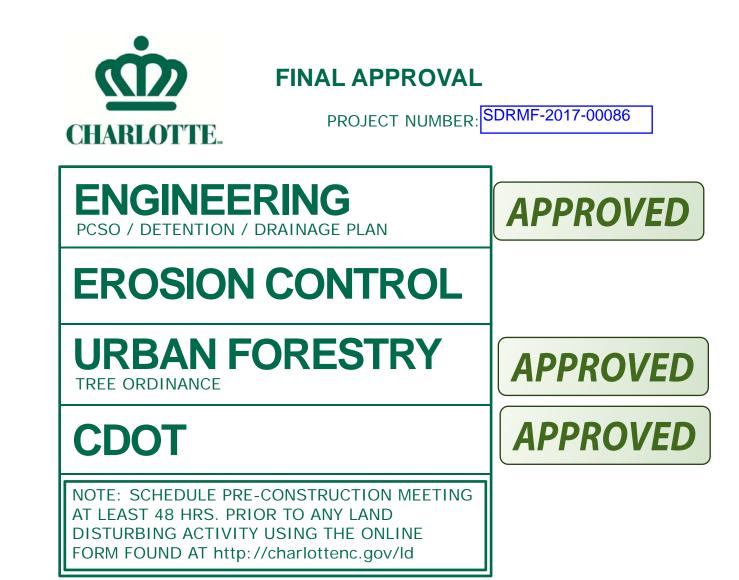



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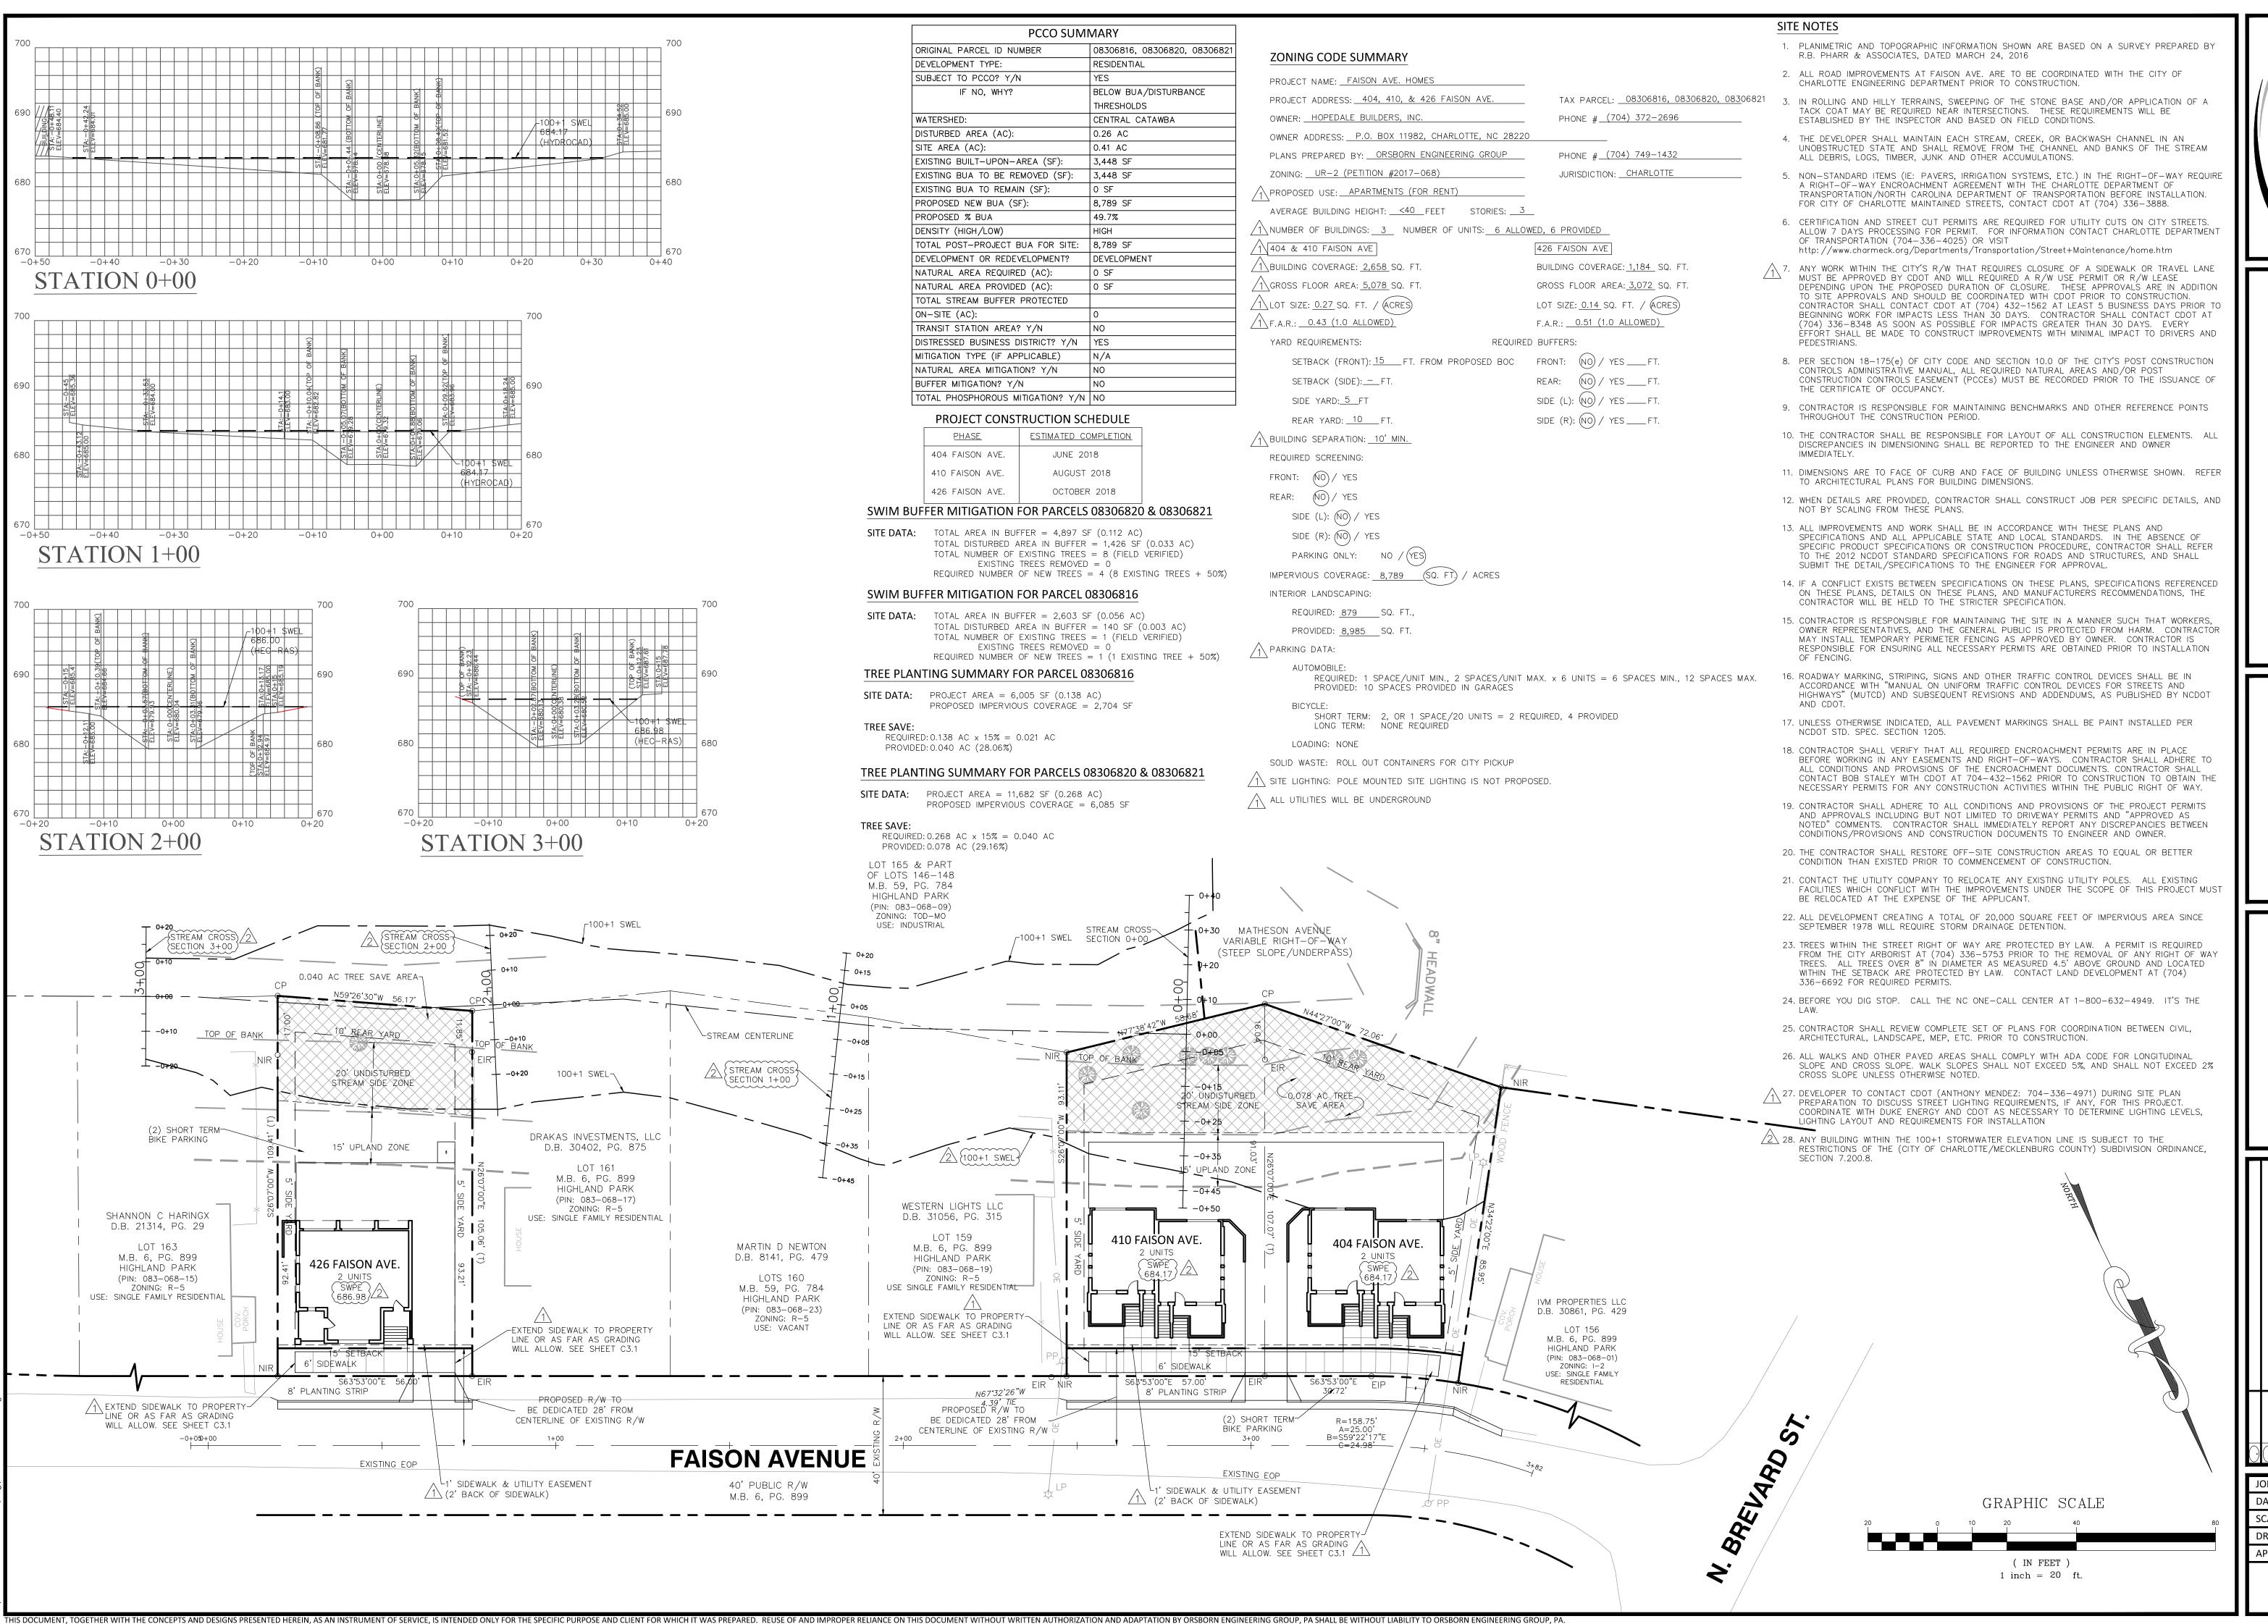
LANDSCAPE PLAN


C4.1

L4.1

ABBRE\	/IATIONS
AC AC/FT	ACRES ACRE FOOT/FEET ALTERNATE
APPROX	APROXIMATE
AVE AVG	ASPHALT AVENUE AVERAGE
BFP	BACKFLOW PREVENTER
BL BLDG BLVD	BASELINE BUILDING BOULEVARD
BM BO	BENCHMARK BLOWOFF
BOC BOT	BACK OF CURB BOTTOM
CATV CB	CABLE TELEVISION CATCH BASIN
CDOT CF	CHARLOTTE DEPARTMENT OF TRANSPORTATION CUBIC FEET
C&G CJ CLDSM	CURB AND GUTTER CONSTRUCTION JOINT CHARLOTTE LAND DEVELOPMENT
CMP	STANDARDS MANUAL CORRUGATED METAL PIPE
COL	CLEANOUT COLUMN CONCRETE
COL CONC CONST CY	CONSTRUCT(ION) CUBIC YARD
DBL	DOUBLE
DEPT DET DI	DEPARTMENT DETAIL DROP INLET
DIM DIP	DIMENSION DUCTILE IRON PIPE
DWG E	DRAWING EAST
ELEC ELEV	ELECTRIC ELEVATION
EOP EQUIP EW	EDGE OF PAVEMENT EQUIPMENT EACH WAY
EXIST EJ	EXISTING EXPANSION JOINT
FG FH	FINISHED GRADE
FH FM FT	FIRE HYDRANT FORCE MAIN FOOT/FEET
GALV	GALVANIZED
GV HDPE	GATE VALVE HIGH DENSITY POLYETHYLENE
HW HWY	HEADWALL HIGHWAY
HORIZ	HORIZONTAL INSIDE DIAMETER
IN INV	INSIDE DIAMETER INCHES INVERT
JB	JUNCTION BOX
JCT L	JUNCTION LENGTH
LB LF	POUND LINEAR FOOT/FEET
LP LT	LIGHT POLE LEFT
MATL MAX	MATERIAL MAXIMUM
MECH MFR	MECHANICAL MANUFACTURER
MH MIN MISC	MANHOLE MINIMUM MISCELLANEOUS
MJ MPH	MECHANICAL JOINT MILES PER HOUR
N NIC	NORTH NOT IN CONTRACT
NO OR # NOM	NUMBER NOMINAL
NTS OC	NOT TO SCALE  ON CENTER
OCS OD	OUTLET CONTROL STRUCTURE OUTSIDE DIAMETER
OEG OVHD	ORSBORN ENGINEERING GROUP OVERHEAD
PED PI	PEDESTAL POINT OF INTERSECTION
P/L POB PP	PROPERTY LINE POINT OF BEGINNING POWER POLE
PROJ PROP	POWER POLE PROJECT PROPOSED
PVC PVMT	POLYVINYL CLORIDE PAVEMENT
R RCP	RADIUS REINFORCED CONCRETE PIPE
RD REQD	ROAD REQUIRED
REV RJP RR	REVISION RESTRAINED JOINT PIPE RAILROAD
RT R/W	RAILROAD RIGHT RIGHT—OF—WAY
S SAN	SOUTH
SCH SECT	SANITARY SEWER SCHEDULE SECTION
SPEC STD	SPECIFICATION STANDARD
STS TC	STORM SEWER TIME OF CONCENTRATION
TCE TDH	TEMPORARY CONSTRUCTION EASEMENT TOTAL DYNAMIC HEAD
TEMP TOB TOC	TEMPORARY TOP OF BANK TOP OF CURB
TYP	TYPICAL
UD UG	UNDERDRAIN UNDERGROUND
VERT	VERTICAL
YR & AND	YEAR  © AT Δ DELTA
u AND	@ AT Δ DELTA
	ALTERIARIES ALTERNATIONS
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February 08, 2018 - 8:33am By: boden P:\17040 Faison Street Homes\Dwg\17040 C0.0 COVER.c



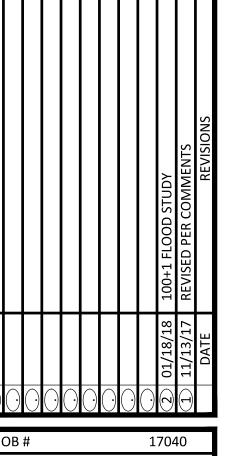

C2.0				
APPROVED BY:	JCO			
DRAWN BY:	JAW			
SCALE:	1" = 20'			
DATE:	09/15/17			
OB #	17040			

ORSBORN ENGINEERING GROUGE EAST MOREHEAD STREET, SUITE 10 CHARLOTTE, NC 28202

OVERALL SITE PLAN
FOR
AISON AVE. HOMES
ARLOTTE, NORTH CAROLINA

HOPEDALE BUILDE P.O. BOX 11982 CHARLOTTE, NC 28220

