

CHARLOTTE HISTORIC DISTRICT COMMISSION

CERTIFICATE OF APPROPRIATENESS

CERTIFICATE NUMBER: HDCRMI-2019-00160

DATE: 19 July 2019

ADDRESS OF PROPERTY: 708 East Tremont Avenue

TAX PARCEL NUMBER: 12109212

HISTORIC DISTRICT: Dilworth

OWNER: Nate Sittema

APPLICANT: Mike Doyne, Chris Luke

DETAILS OF APPROVED PROJECT: Rear Addition. The project is a rear addition that does not raise the original main ridge on the house. The addition ridge is approximately 11" taller than the main ridge and bumps out slightly on the right side. Materials include brick foundation, wood shake siding, wood trim/brackets, and wood windows with Simulated True Divided Lights (STDL) in a 1/1 pattern to match existing. Windows to be re-used, restored, and replaced are noted on the plans. The proposal also includes the reconstruction of the front left corner of the house which is failing, all new materials (siding, windows, trim, etc.) will match existing. Post-construction the rear yard will be 41% impervious. See attached plans and tree protection plans.

The project was approved by the HDC May 8, 2019.

Contact staff prior to making any changes to this approval. Any deviation from the work/materials approved in this COA may result in 1.) a Notice of Violation and Stop Work Order, and 2.) required removal or replacement to bring the work into compliance with this COA and the Charlotte Historic District Design Guidelines.

- > This Certificate of Appropriateness (COA) indicates that this project proposal has been determined to comply with the standards and policies of the Charlotte Historic District Commission.
- > Display the blue COA placard in a visible location along with any required permits.
- No other approvals are to be inferred.
- > No demolition other than that specifically indicated on any attached plans is authorized under this approval.
- > All work must be completed in accordance with all other applicable state and local codes.
- > Any changes from or additions or deletions to the plans referenced herein will void this Certificate, and a new application must be filed with the Historic District Commission.

This Certificate is valid for a period of twelve (12) months from the date of issuance. Failure to obtain a building permit in that time will be considered as a failure to comply with the Certificate and the Certificate will become invalid. If a building permit is not required, then the approved work must be completed within twelve (12) months of the date of issuance of this Certificate. In either situation, the Certificate can be renewed for an additional twelve (12) months by Historic District Commission staff by written request within the first twelve (12) months from the date of issuance.

James Haden, Chairman

Staff

Staff

CHARLOTTE-MECKLENBURG PLANNING DEPARTMENT

600 East Fourth Street Charlotte, NC 28202-2853 PH: (704)-336-2205

www.charlotteplanning.org

FAX: (704)-336-5123

(20.30°) (29.25')N34°20'42"W-49.55 neighbor's wooden privacy fence WILLOW OAK 1 DIG 12' TO 18' TRENCH ALONG DUTSIDE OF BARRIER. TO BE BACKFILLER AFTER PRUNING EXPOSED ROOTS CHIPS VITHIN BARRIER FENCE 35' rearyard (R-5) 6⁹⁹ 49.94, -USE ROUND PIER FOOTINGS TO SUPPORT STAIR AND AVOID DAMAGE TO TREE ROOTS -INSTALL 2' LAYER OF VOID CHIPS WITHIN BARRIER FENCE 5,39 田。 Q 701.31' FFE= 701.28' 🚊 50 O EXISTING STRUCTURE 1-story frame (w/ basement) 3.2 Top of Roof Ridge @ 726**'**± #708 E. Tremont Ave 32.4' x 709.09' x709.01' 20, + 707.65 (R-5) S34°00°01"E 8+ 50.00 + 708,54 + 707.49 ⊞ stray IRF 2,28' S62'40'03"E 708.20 + 707.67 T.B.M.-IRE Elev=708.67

TREE PROTECTION REQUIREMENTS

- PRIOR TO CONSTRUCTION, USE AN 'AIR NIFE' (COMPRESSED AIR
 TOOL) TO GREATE A TREICH (12-00 EEP) SANNING WITHIN THE
 OUTERMOST PERINETERS OF THE TREE PROTECTION EENOING
 (POUSE-SIED), PRIOR BAY EXPOSED PROOTS WITHIN THE TRENCH AND
 BACKFLL IMMEDIATELY TO AVOID ROOT SYSTEM DEHYDRATION.
 PRIOR TO CONSTRUCTION, INSTALL A 24-LAYER OF WOOD CHIPS
 WITHIN THE TRESS PROTECTIVE BARRIER PRIOR TO BUFFER THE SOIL. AND CRITICAL ROOT ZONE FROM STRESS DURING CONSTRU

WILLOW OAK 2

N SPRING 2019, MONITOR AND TREAT THE LOWER 6 OF MAIN STEMAND ROOT COLLAR FOR ACTIVE AMBROSIA BEETLE POPULATIONS THIS DESTRUCTIVE, WOOD-DORNING PEST IS ATTRACTED TO TREES UNDER STRESS, AND HAS MULTIPLE GENERATIONSLIFE CYCLES IN A SINGLE GROWNING SEASON PREVENTIATIVE TREATMENT PROGRAMS ARE

- GROWING SEASOL PREVENTATIVE TREATMENT PROGRAMS ARE RECOMMENDED TO BEGIN IN PERAL'S PRING (APRIL'POSTYTHIA BLOOM), AND CONTINUED AT 69-50 DAY INTERVALS THROUGH NOVEMBER.

 IN SPRING 2019, ADMINISTER AN AUTHARL LICUID-IN-VECTED SOIL.
 CONDITIONER (ARROPRELS) DIRECTLY TO THE ROOT ZONE TO SUPPORT CONDITIONER (ARROPRELS) DIRECTLY TO THE ROOT ZONE TO SUPPORT COSTINUES. THIS (CONHEIT ROOTH) MATERIAL PRINCIPLE AND THE AREA TO SUPPORT THE COSTINUES AND THE SERVICE OF THE AREA TO SUPPORT THE COSTINUES AND THE SERVICE AND THE SUPPORT THE COSTINUES AND THE SERVICES AND T
- PROTECT THE ORT TICK, ROOT ZONE PROVING ROOT DISTIPLIANCE.

 QUIPACTION, THE FENCING IS RECOMMENDED TO PROTECT THE
 CALCULATED (MINIMAM) I? RADIUS FROM THE ROOT COULAR

 PRIOR TO CONSTRUCTION, INSTALL A 2+1 LYPER OF WOOD LIPS WITH
 THE TREES PROTECTIVE BARRIER FENCE TO BUFFER THE SOIL AND CR
 ROOT ZONE FROM STRESS DURING CONSTRUCTION.
- IN FALL 2019, ADMINISTER A NATURAL, LIQUID-INJECTED SOIL CONDITIONER ('ARBORPLEX') DIRECTLY TO THE CALCULATED 12 CRITICAL ROOT ZONE TO SUPPORT FEEDER ROOT PRODUCTION.


HDC SUBMITTAL NUMBER: HDCRMI-2019-00160



2018 ENERGY CODE SUMMARY:

U-0.35 INSULATED. NONMETAL EDGE

SYMBOL LEGEND SHEET NUMBER XXX ELEVATION TAGS ELEVATION TAG DETAIL NUMBER ON SHEET SIM. - INDICATES SECTION IS SIMILAR \bigcirc $\langle x \rangle$ KEYED DEMOLITION NOTE (X - X) CEILING HEIGHT TAG

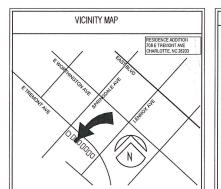

DRAWING INDEX

FD IN+EGRO





Number Date

SITTEMA RESIDENCE 708 EAST TREMONT AVE CHARLOTTE, NC 28203

COVERSHEET, SITE PLAN, SHEET INDEX

> SET ISSUE DATE JUNE 9, 2019

2. ALL CONSTRUCTION SHALL COMELY WITH THE 2018 NORTH CAROLINA RESOLETIAL BUILDING CODE. CONTRACTOR SHALL SUBMIT FOR AND GRISNIN THE REQUIRED BUILDING FERRALT. CONTRACTOR SHALL SUBMIT FOR AND GRISNIN THE REQUIRED BUILDING STRONG AND GRISNING AND WORKNING WITH CONTRACTOR SHALL BE RESPONSIBLE FOR COORDINATING INJECTION AND OWNERING WITH THE AND EXCENTING THE CONTRACTOR SHALL SHALL CONTRACTOR OF GOOD AND CONTRACTOR OF CONTRACT

3. CONTRACTOR SHALL FOLLOW THE APPROVED HDC REQUIREMENTS AND DESIGN AND USE ONLY HOC APPROVED IMATERIALS. CONTRACTOR IS REQUIRED TO MEET OR EXCEED THESE REQUIREMENTS. ANY IMATERIALS OR PRODUCTS THE CONTRACTOR WISHEST OUSE THATTS NOT AN APPROVED IMATERIAL SHALL BE THE RESPONSIBILITY OF THE CONTRACTOR TO SEEK HOC APPROVIAL.

SITE PLAN 01

THES PROJECT IS AN EXEMINE PRESS JUDICE HAVE SHAPED IS BEIN REDUCATED AND SECOND A CORD ADOBED CONTRIVENDES MAN LOURISHIN MORE OFFICE REPORT AND HAVE ADOBED CONTRIVENDES OFFICE REPORT OF THE REPORT OF THE FROME OFFICE ADDRESS OF OTHER PROPERTY OF THE FOUND THAT ADDRESS OFFI OTHER ORANIO ESSUES OF THE FORMOUS SEES OFFI OTHER ORANIO ESSUES OTHER ORANIO ESSUES OFFI OTHER ORANIO ESSUES OTHER ORANIO ESSUES OFFI OTHER OTHER OTHER ORANIO ESSUES OFFI OTHER OT

2. ACCURACY OF DIMEISIONS, ROOF SLOPES, SITE GRADES ETC OBTAINED AT THE SITE ARE THE RESPONSIBILITIES OF THE CONTRACTOR. THERE WILL BE NO COMPRISATION FOR RESOLUTION DIFFERENCES SERVICES HOWNING OMERSIONS AND ACTUAL CONDITIONS OF FOR THE CONTRACTORS FALLINE TO COORDINATE THE TWO. ANY DISCREPANCIES AND REQUIRED MODIFICATIONS SHALL BE REQUEST TO THE ATTENTION OF THE ACROTHECT MADAWATELY. PRIOR TO PROCEEDING, THE CUSTING SITE DIMEISIONS SHALL BE VIEWFIED ACAUST THE CONTRACTOR SHALL WORK FOR PROVIDED PROJECT AND THE CONTRACTOR SHALL WORK FOR CHARGE STATE AND THE CONTRACTOR CHARGE STATE AND THE CONTRACTOR COMMENTS THE PROVIDED PROJECT OF CONTRACTOR COMMENTS OF THE CONTRACTOR COMMENTS.

4. THE CONTRACTOR SHALL COORDINATE WITH THE SUBS ALL SITE ACCESS, MATERIAL DELIVERY, STAGING AREA, AND TRASH COLLECTION REQUIRED BY ITS FORCES ON THE SITE THROUGHOUT THE PROJECT. THE SETE SI ON A RESCRIPTIAL STREET FATH IS SUBJECT TO REGULAR TRAFFICFLOW. DELIVERIES MUST BE STAGED TO PREVENT ANY ELOCKAGE OF 5. DELIVERY OF CONCRETE: CONTRACTOR OR SUB SHALL PLAN ON PUMPING CONCRETE: STREET TO SITE. CONCRETE SUPPLIER SHALL PUMP WASTE ELSEWHERE - NO PLACE TO CURREN USER.

THE DIVISION OF THE SPECIFICATION OUTLINE OR DRAWINGS SHALL NOT CONTROL THE CONTRACTOR IN ASSIGNING AND DIVIDING THE WORK. SUCH ASSIGNMENTS ARE SOLELY A THE DISCRETION OF THE RESPONSIBILITY OF THE CONTRACTOR.

4. LIGHTING FIXTURES, ELECTRICAL DEVICES AND CABLE LOCATIONS ARE SHOWN FOR THE USE OF THE CONTRACTOR IN PROVIDING THESE TENS TO THE OWNER IN THE LOCATIONS SHOWN ALL WORK SHALL COMPLY WITH THE RELECTANT PARTS OF THE MATIONAL ECTRICAL COOP APPLICABLE TO THIS PROJECT ALL COMPONENTS, ELECTRICASCELECTRONICS, FIXTURES ETC SHALL HAVE UL. LABES IN COMPANIONE WITH THE LAW.

3. WELDING, SOLDERING, USE OF VOC CONTAINING SOLVENTS, ETC. SHALL ONLY BE DONE IN A WELL VEHTLATED AREA, PROTECT ALL ADJACENT AREAS FROM SPARKS AND EMBERS WHEN WELDING AND GRINDING.

7. OWNER HAS THE RIGHT TO ACCESS THE SITE AT ANY TIME.

8 CONTRACTOR SHALL PROTECT THE EXISTING HOUSE FROM WEATHER THROUGHOUT THE DURATION OF THE PROJECT. THE STRUCTURE SHALL BE TARPED WHILE ROOF IS REMOVED UNITLE STRUCTURE IS DRIED IN AND THERE IS NO MORE THREAT OF RAIN OR ANY SORT OF MOSTURE ENTERING THE EXISTING STRUCTURE.

9. TEMPORARY SHORING IS REQUIRED ON THIS PROJECT. F&DINITEGRA AND SEED PLLI

SITE: 1. AIM PENSTRIG LANDSCAPING, PAVEMENT AND PLANTINGS THAT MAY NEED TO BE REMOVED NEEDS TO BE COORDINATED WITH THE OWNER, PROTECT TREES (AND SHRUBS IF POSSIBLE) AS DESCRIBED ON THE TREE PROTECTION PLAN APPROVED BY HDC.

- THE AREA OF THE SITE THAT IS DAMAGED BY CONSTRUCTION MUST BE RESULT AND REPLANTED. WHERE SOL IS OF URRIED BY CONSTRUCTION WENGES REMOVE CLAY AND UNACCEPTABLE SOLS AND IMPORT 8 INCRES OF TOPOGLA AND PLACE COMPACT SOLS TO AN APPROPRIATE DEGREE AND RESOLTHE FRONT LAWN AREA WITH FESCUE. MULCH PLANT BEDS.
- CONFIRM 2,000 LB SOIL BEARING CAPACITY, OR AS REQUIRED BY STRUCTURAL DWGS.

CONCRETE: 1. ALL CONCRETE SHALL BE MINIMUM 3000 PSI NORMAL WEIGHT CONCRETE ALL EXTERIOR FLAT CONCRETE WORK SHALL BE AIR ENTRAINED.

MASONRY VEHEER: 1. THE EXTERIOR MASONRY WILL BE RUNNING BOND MASONRY APPEARANCE AND BOND TO MATCH EXISTING AS QLOSELY AS POSSIBLE. BRICK SHALL SHALL COMPLY WITH ASTM C216.

- QLEAL ALL MASOINTY WITH BRICK MANUFACTURED RECOMMENDED CLEANING AGENT. DO NOT PRESSURE WASH THE EPPOSED MASOINTY UNLESS THE PIS IS LOW ENDUGHT TO NOT DAMAGE OR REBUVE THE RRED UNTER LAYER OF THE BRICK'S BODY CLEANING SHALL BE DONE ONLY BY TRAINED AND QUALIFED INTOXIDALS WITH APPROPRIATE CHEMICALS.
- COMPLETELY PROTECT (WITH PLASTIC SHEATHING) THE SURROUNDING WINDOWS, SIDING, GUTTERS, AND FLASHING AND DOWNSPOUTS PRIOR TO CLEANING PROCESS; WASH OFF ANY OVERSPRAY IMMEDIATELY.

- WOOD PRODUCTS.

 1. PROVISE WOOD STUDS OF GRADE AND AT FREQUENCY REQUIRED ON THE STRUCTURAL DRAWINGS. ASSUME BINICIPES ON CENTRET THROUGHOUT THE PROJECT, AS WALL STUDS ARE INSTALLED, THEY WILL BE REVIEWED FOR TRUENESS, A
- 3. ALL LUMBER IN CONTACT WITH MASONRY OR POURED IN PLACE CONCRETE SHALL BE PRESSURE-TREATED.

- ISISTENT WITH HOUSES IN DILWORTH.

 PROVIDE WALLBASE MOUNTED DOOR STOPS/BUMPERS.

 SEE HARDWARE NOTES FOR MORE INFORMATION.

 SEE DRAWINGS FOR DOOR BLEVATIONS AND DESCRIPTION.

- ROOF SHINGLES SHALL BE ARCHITECTURAL ASPHALT SHINGLES. THEY SHALL BE INSTALLED IN AN APPROPRIATE AND WORKMANLINE MANIER WHICH WILL BE WARRANTED (30 YEAR PRO-PARTED WARRANTY) BY THE MANUFACTURE. (10 ROOF MATRICAL SUAY BE STAN ELD) PROPOSED BLATERIAL COLOR SHALL BE SUBATITED BY THE CONTRACTOR AND APPROVED BY THE OWNER AND THE ARCHITECT. APPLY OVER 30.B ASPHALT ROLL GOODS.
- LOWER, PERIMETER EDGE OF ENTIRE ROOF SHALL CONSIST OF A STARTER COURSE OF SHINGLES OVERLAIN WITH THE FIRMA. SHIRGLES. ALL MATERIALS SHALL BE ATTACHED WITH HOT DIPPED GALVANIZED ROOFING NAILS AS REQUIRED BY COOR ANDOR SHINGLE MINUFACTURER, WINCHEVER IS NOWED STRINGENT.
- PROVIDE A DRIP EDGE ALONG ANY GABLES OR EDGES WHERE THERE IS NO GUTTER. PROVIDE A SEAL SEAL AND GROW AND ILE BARRIER WITH A SEA F-AH-PRING BACKING WHERE WIDCATED ON THE ROOF PAIN ROOFING FET SHALLE ET WAS LAYERS OF 15.8 FET ON ONE LAYER OF 9.1 BET LAYER OF 15.0 FET ALONG THE ROOF PAIN ROOFING FET SHALLE ET WAS LAYER OF 15.5 FET AND REVEAULT OF 15.0 FET ALONG THE GABLE WHERE THE RAKE IS EXPOSED ALONG THE GABLE DISS OF THE HOUSE THE PROVIDE ALONG THE GABLE.
- SEALANTS, FROVIDE AND INSTALL AN EXTERIOR GRADE PAINTABLE URETHANE SEALANT AT THE JUNCTURE OF VERTICAL, WOOD TRIM AND HORIZONTAL SOING AND TRIM, PROVIDE AND INSTALL PAINTABLE SULCOME SEALANT AT THE JUNCTURE OF MASORING HAD WOOD TRIM, PROVIDE CLOSED COLL BLOCKER DOSS WHERE CONDITIONS (YOUGS) MERIT, TOOL, JOINTS TO A CONCAVE FINISH, REMOVE ANY OVERAGE ON ADJACENT SURFACES.
- PROVIDE SHINGLE ROOF ON LOW SLOPE ROOFS. COVER ENTIRE LOW SLOPE ROOF SHEATHING AND VALLEYS WITH SELF-ADHESIVE SHOW AND ICE SHIELD. INSTALL PER MANUFACTURERS INSTALLATION INSTRUCTIONS.

SPECIFICATIONS

- WEATHERAIR BARRIER

 1. TYPEK AM BARRIER "HOME WRAP" ROLL MATERIAL IS ACCEPTABLE. (CONTRACTOR MAY USE TYPEK FLUD
 APPLIED AIR MARRIER AT THEIR OPTION) WHICHEVER PRODUCT IS APPLIED IT MUST:

 a. BE INSTALLED IN FLUL COMPLIANCE WITH THE MANUFACTURERS INSTALLATION DETAILS AND
 INSTRUCTIONS.
- b. PROVIDE A CONTINUOUS, UNINTERRUPTED AIR BARRIER.

- b. PROVOE A COMINIOUS, UNIVERRIPPTED AND REARRIER.
 c. NOTHWIS COST, TEARS ON VERTICAL, JOHIST THAT HAVE NOT BEEN FALLY TAPED AND SEALED.
 d. OVERLAP AD ACCENT TYMES, WINDOW FRANKS, FLASHING ETCA JOHT SHALL, BE CONSTRUCTED SO. AS
 TO POSITIVELY SHED WATER. EACH PAUL OF PREVAIL OFFERAT HIS CHOKEN BAND.
 e. UTILZE THE MANUFACTURER (DUPONT) PAPROVED FLALY MONERED R. EXYMAP AND STRAIGHTEASH
 TO PROPERLY AND TICHAT'S SEAL THE ARR ARRIER RADIONID EACH WALL OPENING ETC INSTALL PER
 MANUFACTURERS REQUIREMENTS.
 THE OVERLAPPING BLATIONSHIP OF THE ARR BARRIER TO FLASHING ETC MUST BE SUCH THAT IT PROCES
 WATER TO THE OUTSIDE OF THE BINLDING ENVELOPE AT ALL TERMINATION POINTS OR EDGES, ("SHINGLE THE
 APPLICATION").

FLASHING 1. PAINTED FLASHING WILL BE REQUIRED AT ALL WINDOW, DOOR AND OTHER OPENING HEADS AND SILLS.

- THE INSTITUTE HEREOWICH A FLAT WAY, DOWN HOUSE HEREO WITH HEREO AND STATE OF PRODUCT SHEEL EZ OR PREFINISHED AUDMINION, 10.10.

 B. HASHRIO SHALL BE FARRICATED SO THAT THE DOYGOED EDGE IS HERMOD AND PROJECTS 30° BEFORD THE SUPPORT HEREO AND PROJECTS THAT THE TOP OF THE EXPONENT HEREOF AND PROJECTS THE TOP OF THE DOYGOED WOOD WITH A HEAVED EDGE.

 C. FLASHRIO SHALL BE ANGIVERED WITH COMPATIBLE FASTERIERS.

- WINDOWS

 1. NEW DOUBLE-HUNG WINDOWS SHALL BE SIEBRA PACEFIC CUSTOM PAINT WOOD DOUBLE HUNG WINDOWS SHALL BE SIEBRA PACEFIC CUSTOM PAINT WOOD DOUBLE HUNG WINDOWS AND ACKESSERT WHERE BOOLCHED, CASSLITES IN THE NEW WINDOWS AND DOORS SHALL BE USUAL THIN DOUBLE ALZADS WINTHOW CONTROL WINDOWS SHAD SHAD SHAD WINDOWS AND PROVIDED SHAD SHAD WINDOWS SHAD SHAD SHAD WINDOWS SHAD WIND
- MATCH.
 INTERIOR OF THE WINDOW ASSEMBLY SHALL BE PRIMED WOOD.
 PROVIDE AND INSTALL WINDOW TRIM TO MATCH EXISTING.
 WINDOW SHALL BE FULLY OPERABLE.
- 5. 'NAILING FLANGE' WINDOWS ARE NOT ALLOWED.

- GENERAL FRAMMIC


 1. REFER TO FRAMMIC DISTS ELSEWHEREIN THESE DOCUMENTS. THE FRAMMIC DESIGN NOTES ARE THE MINIMADAS. ACTUAL DESIGN OF THE FRAMED STRUCTURE IS TO BE PROVIDED BY THE CONTRACTOR AND THE DESIGN SHALL COMEY WITH THE ZOB IS OR RESIDENTIAL BUILDING CODE. CONTRACTOR SHALL PROVIDE STRUCTURAL BRIGHERMIC FRAMED BY OWN, OTHER ELSCEDIBLING BUILDING STANDARDS.

 2. THE CETERIOR WALL STIDS SHALL BE ZAX HIMMAND MUST SIGNIS AT TOT MORE THAN THE MINISTER SHALL BOTH SHALL BE ADMINISTRATED OF THE MINISTER SHALL BE STANDED OF THE OPENING.

 3. AT THE LARGE, MALTIPLE WINDOW ASSISTANT SHALL STUDS ON INTITIES DESCRIPTION THE OPENING.
 WITH SIGNIE AND ACT SIDDS, SEE STRUCTURAL).

- WITH SINGLE JACK STUDS, (SEE STRUCTURAL)

 4. ALL SLE PATES (ANTHMISH ICH CONTEAT WITH MASORITY OR CONCRETE) SINGLE BE PRESSURE THE OF SIME THE MASORITY OR CONCRETE SINGLE BE PRESSURE THAN SINGLE AND CONCRETE FOUR DATA WITH SINGLE STRUCTURE STRUCTURE SINGLE STRUCTURE STRUCTURE SINGLE STRUCTURE STRUCTURE SINGLE STRUCTURE SINGLE STRUCTURE SINGLE STRUCTURE STRUCTURE STRUCTURE SINGLE STRUCTURE STRUCTURE SINGLE STRUCTURE STRUCTU
- 5. PROVIDE HURRICANE STRAPPING AT ROOF JOISTS AND AT FLOOR FRAMING PER CODE

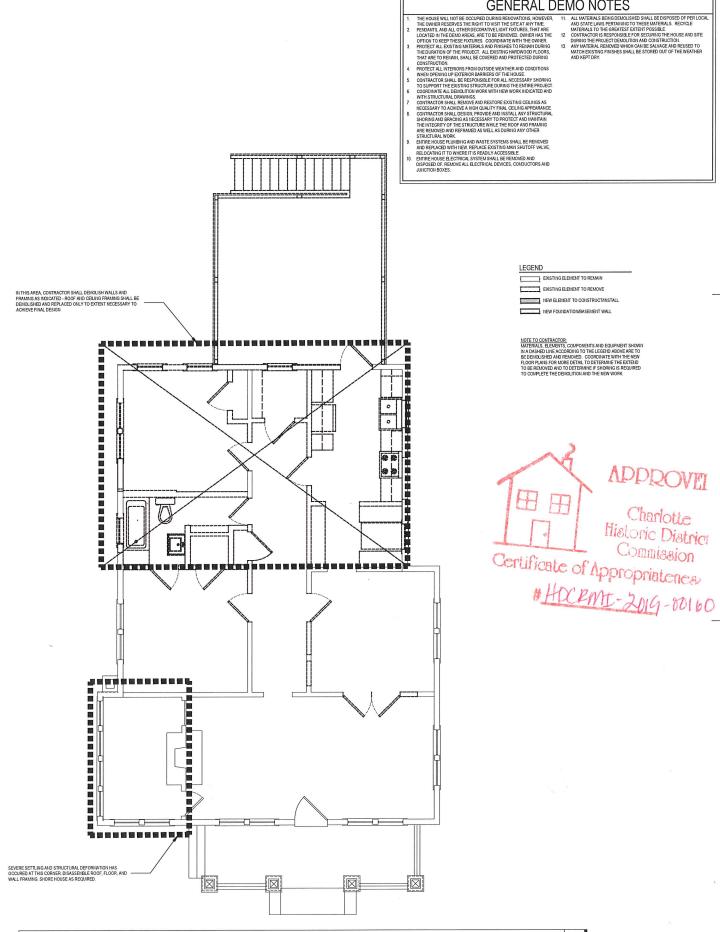

FD IN+EGRA

GENERAL DEMO NOTES

an Integra Architecture, PLLC DBA 118 East Kingston Avenue, Ste. 20 Charlotte, NC 28203 704,372,0001 www.fdintegra.com

THE DRAWINGS & WRITTEN MATERIAL HEREIN CONSTITUTE ORIGINAL WORK OF THE ARCHITECT, & AS INTELLECTULA. PROPERTY & INSTRUMENTS OF SERVICE, ARE SUBJECT TO COPYRIGHT & MAY NOT BE WOODLED, PURISHED DISTRUMENCE DISTRUMENCE DEPROPHEDIOR OR USED IN ANY WAY WITHOUT EXPRESS WRITTEN CONSENT OF THE ARCHITECT OF DEPARTMENT OF THE ARCHITECT OF DEPARTMENT OF THE ARCHITECT.





Number Date

SITTEMA RESIDENCE 708 EAST TREMONT AVE CHARLOTTE, NC 28203

Project No.:

MAIN FLOOR **DEMOLITION PLAN**

> SET ISSUE DATE JUNE 9, 2019


AD1.0

MAIN FLOOR DEMOLITION | O1

ELEVATION 02

K 7 LX 1

SCALE: 3/16" = 1'-0"

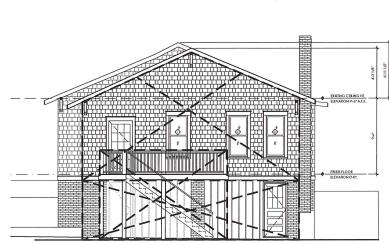

ELEVATION 01

FD IN+EGRA






SITTEMA RESIDENCE 708 EAST TREMONT AVE CHARLOTTE, NC 28203

Project No.:
Drawing Title:
DEMOLITION
ELEVATIONS

SET ISSUE DATE JUNE 9, 2019

AD2.0

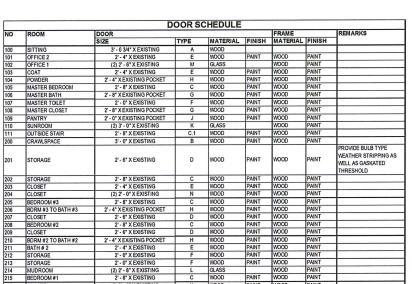

NOTES:

- OUTLETS TO BE COORDINATED WITH FURNITURE
 LAYOUT AND PER CODE. COORDINATE WITH
 OWNER AT TIME OF ROLICELIN
- OWNER AT TIME OF ROUGH-IN.

 PER HDC, ALL WINDOW ASSEMBLIES MUST MATCH EXISTING.


in+EGRO
an Inlegra Architecture, PLLC DBA

an Integra Architecture, PLLC 118 East Kingston Avenue, S Charlotte, NC 2 704.372

THE DRAWINGS & WRITTEN MATERIAL HERRIN CONSTITUTE ORIGINAL WORK OF THE ARCHITECT. & AS INTELLECTUAL PROPERTY & INSTRUMENTS OF SERVICE, ARE SUBJECT TO COPYRIGHT AWAY NOT BE MODIFIED, PUBLISHED DISTRIBUTED, REPRODUCED OR USED IN AIN TWAY WITHOUT EXPRESS WRITTEN CONSENT OF THE ARCHITECT





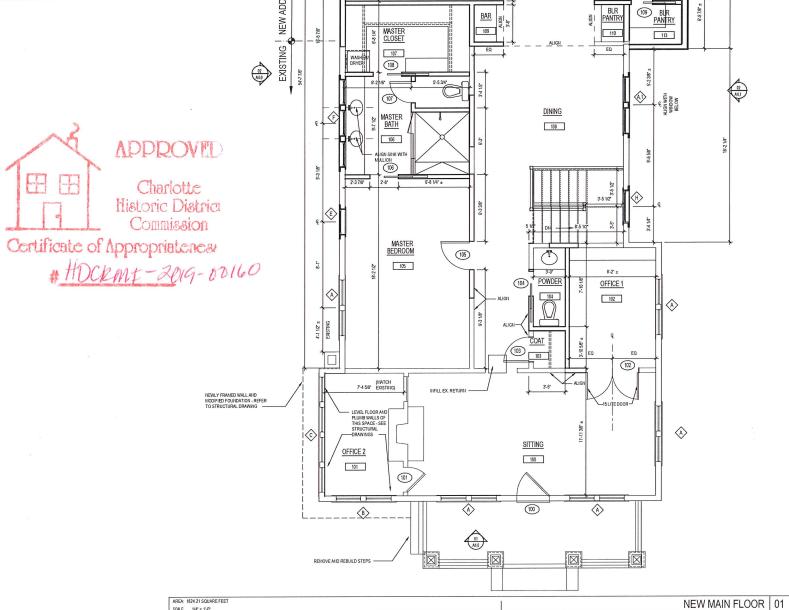

FAMILY 111

32'-8 7/8'

SCREEN PORCH

113

KITCHEN 112 03 A4.1

Revisions:
Number Date Description

Project Title:

SITTEMA RESIDENCE 708 EAST TREMONT AVE CHARLOTTE, NC 28203

Project No.: Drawing Title:

Drawing Title:

MAIN FLOOR PLAN

SET ISSUE DATE

▶ JUNE 9, 2019 ◀

A1.0

BDRM #2 TO BATH #2
BATH #2
STORAGE
STORAGE
MUDROOM

NOTES:

- OUTLETS TO BE COORDINATED WITH FURNITURE LAYOUT AND PER CODE. COORDINATE WITH OWNER AT TIME OF ROUGH-IN.
 PER HDC, ALL WINDOW ASSEMBLIES MUST MATCH EXISTING.



APPROVED

Charlotte Historic District Commission

Certificate of Appropriateness

#HDCKM7-2019-00160

02 A4.0

EJECTOR PUMP VENT

FD IN+EGRA





Number Date

SITTEMA RESIDENCE 708 EAST TREMONT AVE CHARLOTTE, NC 28203

Project No.:

LOWER FLOOR PLAN

SET ISSUE DATE JUNE 9, 2019

01 A4.0

01 A4.1

(214)

MUDROOM

211

206

BEDROOM 3

201)-

8'-1 1/2"

BEDROOM 1 214

212

CLOS 4 209/

CLOS 19 207

— 7 — — 9-1 1/2* —

KIDS GAMING/TV

204

3-23/8

200

208

25 (203)

4" DIAMETER, PERFORATED, FILTER FABRIC WRAPPED PIPE @ ELEVATION 6" BELOW TOP OF NEW SLAB


EXISTING CRAWLSPACE 200

BEDROOM 2


210

NEW LOWER FLOOR 01

(2) A4.1

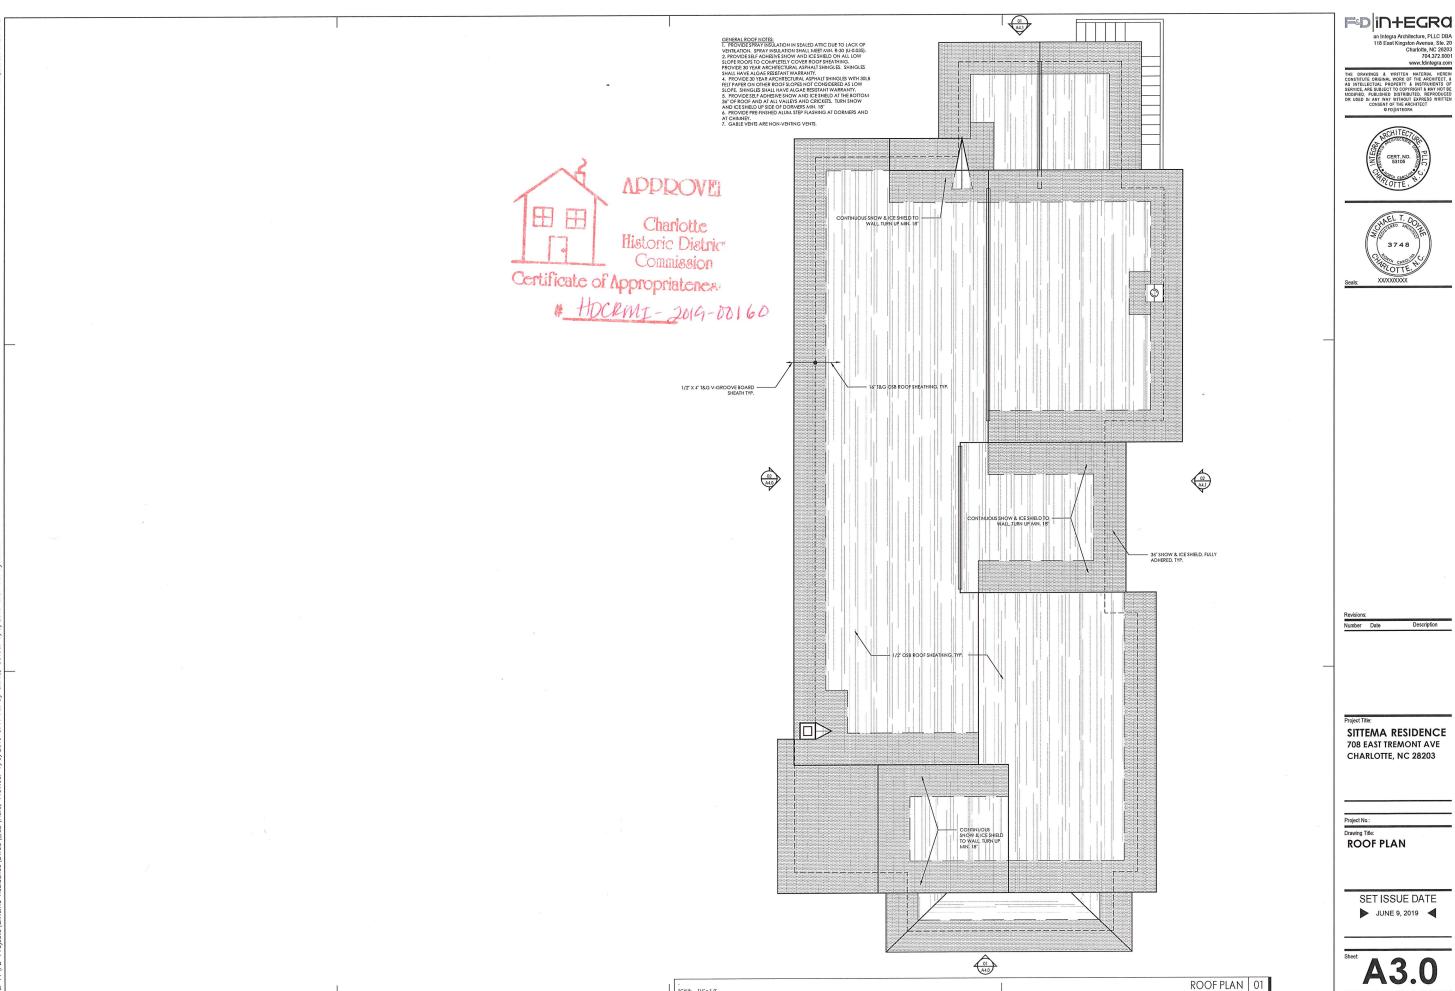

A3.0

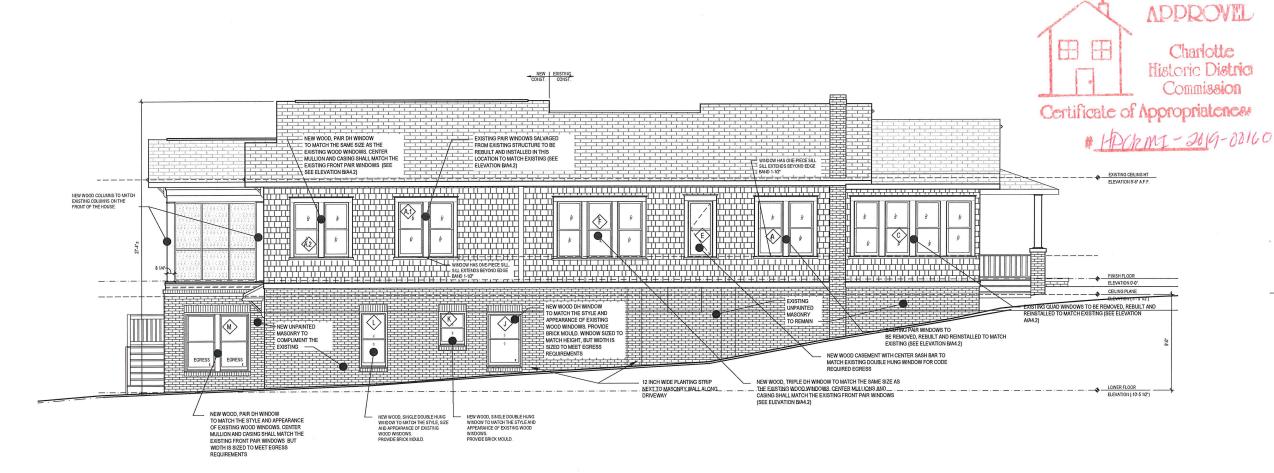

LEFT ELEVATION 02

Revisions:

lumber Date

FD in+EGRA

an Integra Architecture, PLLC DBA 118 East Kingston Avenue, Ste. 20 Charlotte, NC 28203 704.372.0001 www.fdintegra.com

5 · 170

SITTEMA RESIDENCE 708 EAST TREMONT AVE CHARLOTTE, NC 28203

Project No.: -

NEW ELEVATIONS

SET ISSUE DATE
JUNE 9, 2019

A4.0


INSTRUCTOR PART WINDOWS TO BE REMOVED, REBUILT AND REINSTRIC PART WINDOWS TO BE REMOVED, REBUILT AND REINSTRIC PART WINDOWS TO BE REMOVED, REBUILT TO MATCH EXISTING GENERAL "TO BE AND COLOR PART WINDOWS TO BE REMOVED, REBUILT TO MATCH EXISTING GENERAL "TO BE AND COLOR PART WINDOWS TO BE REMOVED, REBUILT TO MATCH EXISTING GENERAL "TO BE AND COLOR PART WINDOWS TO BE REMOVED, REBUILT ON MATCH EXISTING GOLOR PART WINDOWS TO BE REMOVED, REBUILT TO MATCH EXISTING GOLOR PART WINDOWS TO BE REMOVED, REBUILT TO MATCH EXISTING GOLOR PART WINDOWS TO BE REMOVED, REBUILT TO MATCH EXISTING GOLOR PART WINDOWS TO BE REMOVED, RESULT TO MATCH EXISTING GOLOR PART WINDOWS TO BE REMOVED, RESULT TO MATCH EXISTING GOLOR PART WINDOWS TO BE REMOVED. RESULT TO MATCH EXISTING GOLOR PART WINDOWS TO BE REMOVED, RESULT TO MATCH EXISTING GOLOR PART WINDOWS TO BE REMOVED. RESULT TO MATCH EXISTING GOLOR PART WINDOWS TO BE REMOVED, RESULT TO MATCH EXISTING GOLOR PART WINDOWS TO BE REMOVED. RESULT TO MATCH EXISTING GOLOR PART WINDOWS TO BE REMOVED. RESULT TO MATCH EXISTING GOLOR PART WINDOWS TO BE REMOVED. RESULT TO MATCH EXISTING GOLOR PART WINDOWS TO BE REMOVED. RESULT TO MATCH EXISTING GOLOR PART WINDOWS TO BE REMOVED. RESULT TO MATCH EXISTING GOLOR PART WINDOWS TO BE REMOVED. RESULT TO MATCH EXISTING GOLOR PART WINDOWS TO BE REMOVED. RESULT TO MATCH EXISTING GOLOR PART WINDOWS TO BE REMOVED. RESULT TO MATCH EXISTING GOLOR PART WINDOWS TO BE REMOVED. RESULT TO MATCH EXISTING GOLOR PART WINDOWS TO BE REMOVED. RESULT TO MATCH EXISTING GOLOR PART WINDOWS TO BE REMOVED. REMOVED.

. SCALE W**14"

CEILING PLANE
ELEVATION (-1'- 6' ____

SCALE: 1/4" = 1'-0"

REAR ELEVATION - SUNROOM 03

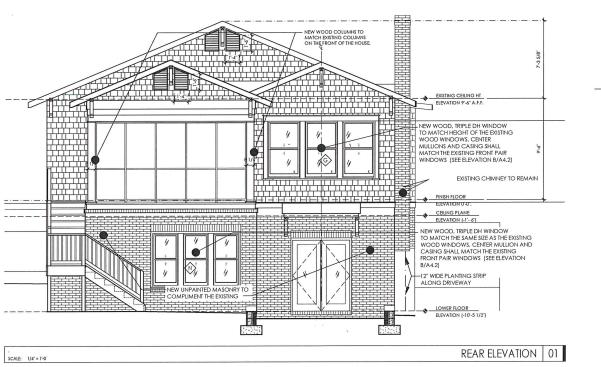

FD in+EGRa

an Integra Architecture, PLLC DBA 118 East Kingston Avenue, Ste. 20 Charlotte, NC 28203 704.372.0001 www.fdintegra.com





Revisions: Number Date

SITTEMA RESIDENCE 708 EAST TREMONT AVE CHARLOTTE, NC 28203

Project No.: Drawing Title: NEW ELEVATIONS

> SET ISSUE DATE JUNE 9, 2019

A4.


<u></u>

WINDOW SCHEDULE 02

EENERAL NOTES:

1. ALL NEW WINDOWS ARE ALL WOOD CONSTRUCTION WINDOWS FROM SIERRA PACIFIC. WINDOWS WILL BE CUSTOM BUILT TO MATCH THE SIZE OF THE EXISTING WINDOWS WHERE NOT DICTATED BY BUILDING CODE OR A BATHROOM.

2. ALL CAINES AND MULLION TRIM WILL MOUSE (SEE DETAIL "BOWS ON FRONT OF THE SIZE OF THE SIZE

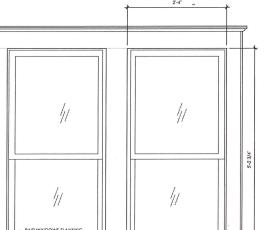

EXISTING PAIR FRONT WINDOWS | B

NOTE: THIS ELEVATION REPRESENTS THE EXISTING WINDOW ON THE FRONT PORCH FACING THE STREET. THIS IS THE MODEL



DOOR SCHEDULE 01

 $\langle B \rangle$


N ...

(3)

SCALE: 1/4" = 1'-0"

POCKET DOOR POCKET DOOR

SCALE: 1/4' = 1'-0"

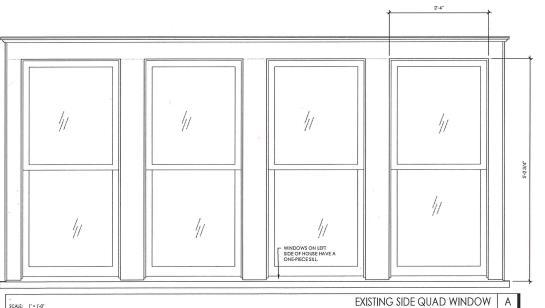

NOTE: THIS ELEVATION REPRESENTS THE EXISTING WINDOW ON THE SIDE PORCH FACING THE DRIVEWAY.
THE CENTER MULLION TRIM IS WIDER THAN THE TYPICAL TRIM ON THE REST OF THE HOUSE. CONTRACTOR
MUST REPLICATE THIS WINDOW ASSEMBLY. SASHES, TRIM, ETC MUST EITHER BE RESTORED/REPAIRED OR REPLACED TO MATCH EXISTING.

FD IN+EGRA






SITTEMA RESIDENCE 708 EAST TREMONT AVE CHARLOTTE, NC 28203

Description

Project No.:
Drawing Title:
WINDOWS AND
DOORS

SET ISSUE DATE JUNE 9, 2019

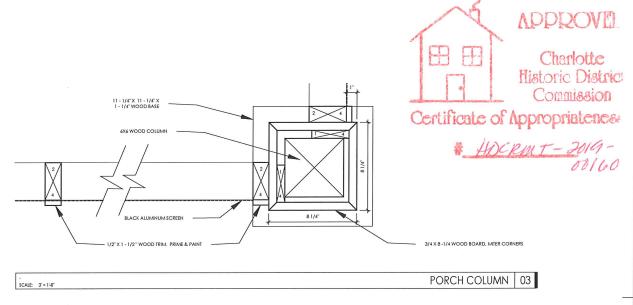

FD in+EGRa





CEDAR SHAKES
AIR BARRIER

2" PLYWOOD SHEATHING PLYWOOD SHEATHING PRE-FINISHED ALUMINUM FLASHING € GWB -BRICK TIES @ 16" O.C. EACH WAY 1" AIR SPACE -1/2" SHEATHING 2 X 6 WALL STUD ANCHOR BOLT (SEE STRUCTURAL) - 1-1/4" WOOD FURRING STRIPS - 16" 0.C - 1" DRAINABLE PROTECTION BOARD 4" COMPACTED CONCRETE FOOTING (SEE STRUCTURAL)


FOUNDATION 01

SITTEMA RESIDENCE 708 EAST TREMONT AVE CHARLOTTE, NC 28203

Revisions: Number Date

Project No.:
Drawing Title:
SECTIONS & DETAILS

SET ISSUE DATE JUNE 9, 2019

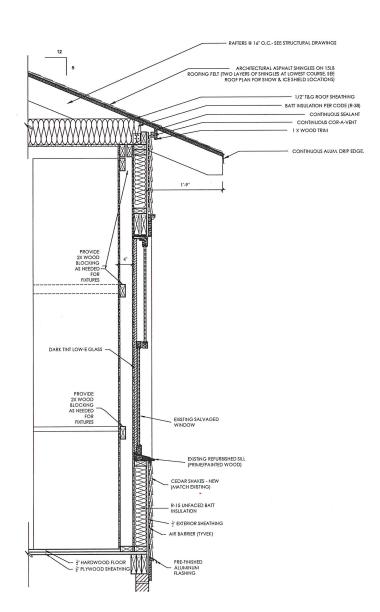

SCALE: 1 1/2' = 1'-0'

KITCHEN 02


SCALE: 1" = 1'-0"


HACKMI-2019-00160

FD in+EGRa





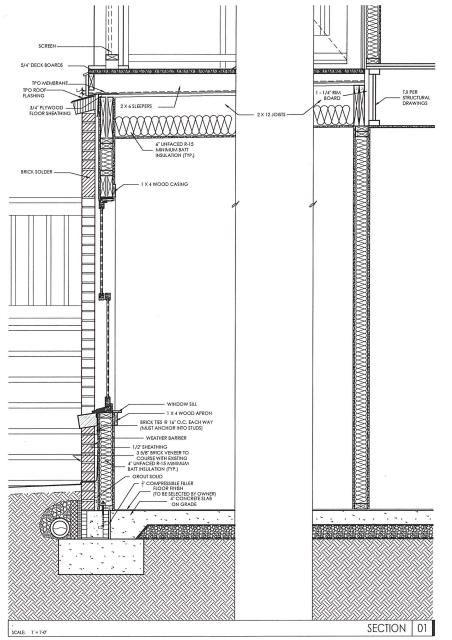


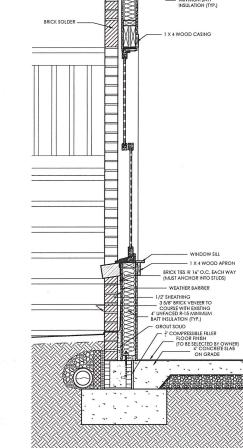

Project Title:
SITTEMA RESIDENCE
708 EAST TREMONT AVE
CHARLOTTE, NC 28203

Project No.:
Drawing Title:
SECTIONS & DETAILS

SET ISSUE DATE JUNE 9, 2019

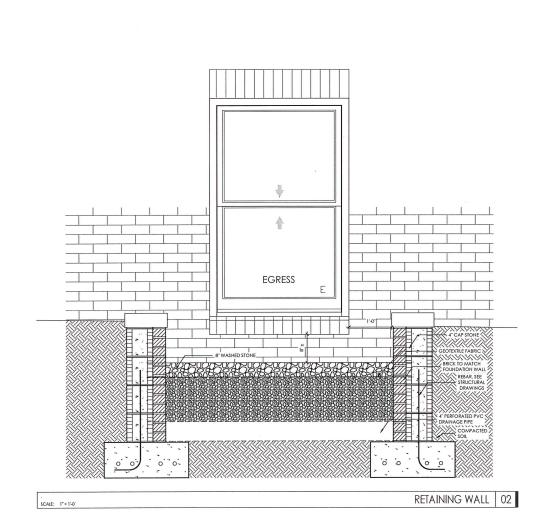



Dear Historic District of Charlotte,

On Wednesday April 24, 2019, Santigie Kabia (ISA TRAQ Certified Arborist with Heartwood Tree Service) was asked to assess the health and structural integrity of a shared 34" Willow Oak growing along the right rear perimeter of 708 E. Tremont Ave., 28203.

A limited visual inspection revealed a large stressed canopy growing on the assumed property line. The canopy has vigorous growth expanding uniformly to the tips/towards sun exposure; however, there are isolated limbs with aggressive dieback and evidence of Hypoxylon Canker (indicator of severe stress/decline/dead tissue).

Santigie was advised of a potential new home construction project to take place in close proximity of the mature Willow Oak which could severely affect the tree's health and structural integrity. As an attempt to mitigate the potential stresses incurred from construction, Santigie was asked to compose a management plan to preserve the tree's long-term health and structural integrity for as long as possible..

The following mitigation actions and services are strongly recommended (as listed) to assist in the tree's preparation for and recovery from soil and root disturbance:

- In spring 2019, monitor and treat the lower 6' of main stem and root collar for active
 Ambrosia Beetle populations. This destructive, wood-boring pest is attracted to trees
 under stress, and has multiple generations/life cycles in a single growing season.
 Preventative treatment programs are recommended to begin in early-spring
 (April/Forsythia bloom), and continued at 60-90 day intervals through November.
- In spring 2019, administer a natural, liquid-injected soil conditioner ("ArborPlex") directly
 to the root zone to support bloom/leaf expansion. Comprised primarily of sea kelp and
 worm castings, this (low-Nitrogen) material improves the soil structure, alleviates drought
 stress, and increases plant vigor.
- In spring 2019, apply a systemic tree growth regulator ("Cambistat") soil drench to maximize resource efficiency. This material reallocates energy within the vascular system to produce slightly smaller leaves and shorter annual twig growth, while increasing feeder root (volume) production. This process develops a stronger collection root system with less canopy surface area to support (increasing stored energy/vigor). This material has a 36-month residual effect and should not be re-applied before spring 2022.
- Prior to construction, prune lower canopy to provide 6-8' house clearance. Reduce horizontal canopy (weight) to mitigate risk of branch/stem failure (1-3" diameter pruning cuts). Remove hazardous dead branches 2" diameter and larger.

Heartwood Tree Service, LLC · P.O. Box 240881 Charlotte, NC 28224 · (704)525-3066 · www.heartwoodtree.com

ī			



- Prior to construction, install a highly visible barrier fence to protect the critical root zone from root disturbance/soil compaction. The fencing is recommended to protect as much of the calculated 11.5' radius of the root collar.
- Prior to construction, use an "Air Knife" (compressed air tool) to create a trench (12-18" deep) spanning within the outermost perimeters of the tree protection fencing (house-side). Prune any exposed roots within the trench and backfill immediately to avoid root system dehydration.
- Prior to construction, install a 2-4" layer of wood chips within the tree's protective barrier fence to buffer the soil and critical root zone from stress during construction.
- In fall 2019, administer a natural, liquid-injected soil conditioner ("ArborPlex") directly to the calculated 11.5' critical root zone to support feeder root production..

The listed recommendations are based on the tree conditions at the time of the assessment. It is advised to have a qualified arborist assess the tree and site conditions throughout the duration of the construction project, annually thereafter, and after any significant weather events that could affect the tree's health or structural integrity. The listed services are recommended as risk mitigation and do not entirely remove risk of tree decline, death, or failure.

Best Regards,
Santigie ("Tig") Kabia
ISA TRAQ Certified Arborist & Municipal Specialist (MA-4553AM)




Heartwood Tree Service, LLC · P.O. Box 240881 Charlotte, NC 28224 · (704)525-3066 · www.heartwoodtree.com







Certificate of Appropriateness

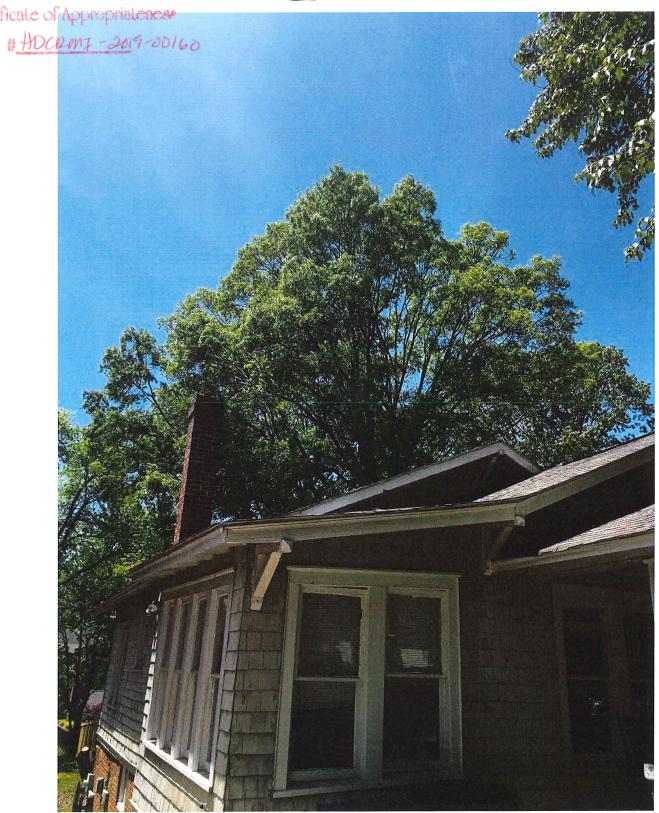

Heartwood Tree Service, LLC · P.O. Box 240881 Charlotte, NC 28224 · (704)525-3066 · www.heartwoodtree.com



Certificate of Appropriateness

