Charlotte Historic District Commission Application for a Certificate of Appropriateness

Staff Review Date: February 13, 2019

HDC 2019-00040 PID# 08117519

LOCAL HISTORIC DISTRICT: Plaza Midwood

PROPERTY ADDRESS: 1418 Hamorton Place

SUMMARY OF REQUEST: Addition

APPLICANT/OWNER: Benjamin Lippincott, applicant

Details of Proposed Request

Existing Conditions

The existing structure is a 1-story Craftsman bungalow house constructed in 1930. Other features include front clipped gable roof, partial width front porch with a matching clipped gable roof supported by square wood columns atop brick piers, 4/1 windows, exposed rafter and bracket details. House height as measured from grade to ridge is 18'-9". The lot size is approximately 46' x 148'.

Proposal

The proposal is an addition that raises the main ridge approximately 7'-6". The addition adds a cross gable roof that will eliminate the exposed rafters on the left and right elevations. A second story will be added to an existing one-story element on the rear elevation. A two-story covered terrace/deck will be added to the rear. Materials are 5" wood German siding to match existing and wood or aluminum clad windows to match existing. All details (corner boards, brackets, window trim, etc.) will be wood to match existing. A 32" Oak tree is located near the left corner of the addition. No changes to existing window openings on first floor.

Design Guidelines – Additions, page 7.2

- 1. Attempt to locate the addition on the rear elevation so that it is minimally visible from the street.
- 2. Limit the size of the addition so that it does not visually overpower the existing building.
- 3. Attempt to attach new additions or alterations to existing buildings in such a manner that, if such additions or alterations were to be removed in the future, the essential form and integrity of the building would be unimpaired.
- 4. Maintain the original orientation of the structure. If the primary entrance is located on the street façade, it should remain in that location.
- 5. Maintain the existing roof pitch. Roof lines for new additions should be secondary to those of the existing structure. The original roof as visible from the public right-of-way should not be raised.
- 6. Make sure that the design of a new addition is compatible with the existing building. The new work should be differentiated from the old while being compatible with its massing, form, scale, directional expression, roof forms and materials, foundation, fenestration, and materials.

All New Construction	n Projects Will be Evaluated for Compatibility by the Following Criteria	Page #
Setback	in relationship to setback of immediate surroundings	6.2
Spacing	the side distance from adjacent buildings as it relates to other buildings	6.3
Orientation	the direction of the front of the building as it relates to other buildings in the district	6.4
Massing	the relationship of the buildings various parts to each other	6.5
Height and Width	the relationship to height and width of buildings in the project surroundings	6.6
Scale	the relationship of the building to those around it and the human form	6.7
Directional Expression	the vertical or horizontal proportions of the building as it relates to other buildings	6.8
Foundations	the height of foundations as it relates to other buildings in project surroundings	6.9
Roof Form and Materials	as it relates to other buildings in project surroundings	6.10
Cornices and Trim	as it relates to the stylistic expression of the proposed building	6.11
Doors and Windows	the placement, style and materials of these components	6.12
Porches	as it relates to the stylistic expression of the proposed building and other buildings in the district.	6.14
Materials	proper historic materials or approved substitutes	6.15
Size	the relationship of the project to its site	6.2 &
Rhythm	the relationship of windows, doors, recesses and projections	6.12
Context	the overall relationship of the project to its surroundings.	6.1-10
Landscaping	a tool to soften and blend the project with the district	8.1-1

All projects should use this summary checklist to ensure a submittal addresses all the new construction criteria.

Staff Recommendation

Staff has the following concerns with the proposal:

- 1. Height, massing, scale, directional expression, roof form, context.
- 2. Tree protection plan needed for the 32" Oak.
- 3. Minor revisions may be reviewed by staff.



HDC-201900040

PD 08117519

LOCAL HSTORCDSTRCT: PLAZA MIDWOOD

PROPOSED PROJECT: ADDITION



Existing Conditions









Context/Adjacent Structures









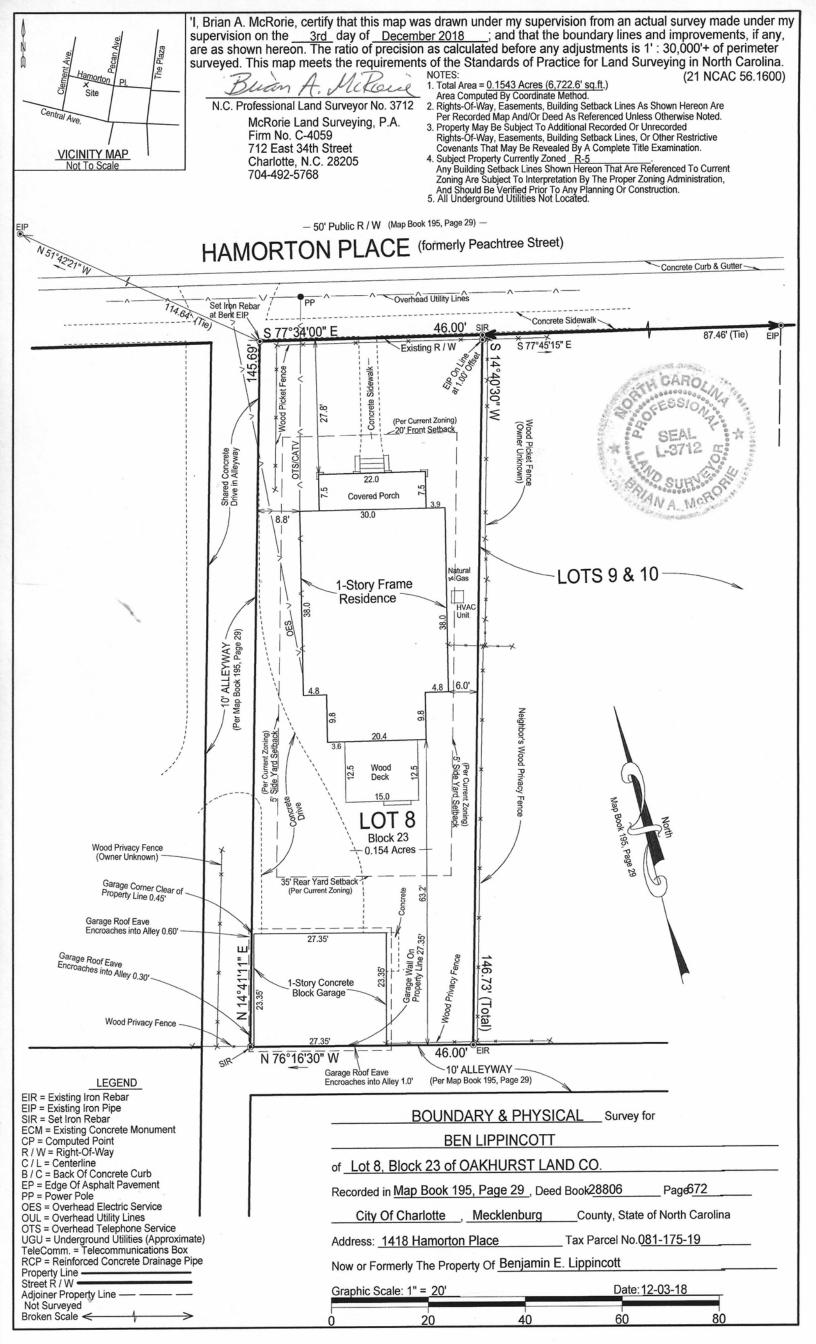


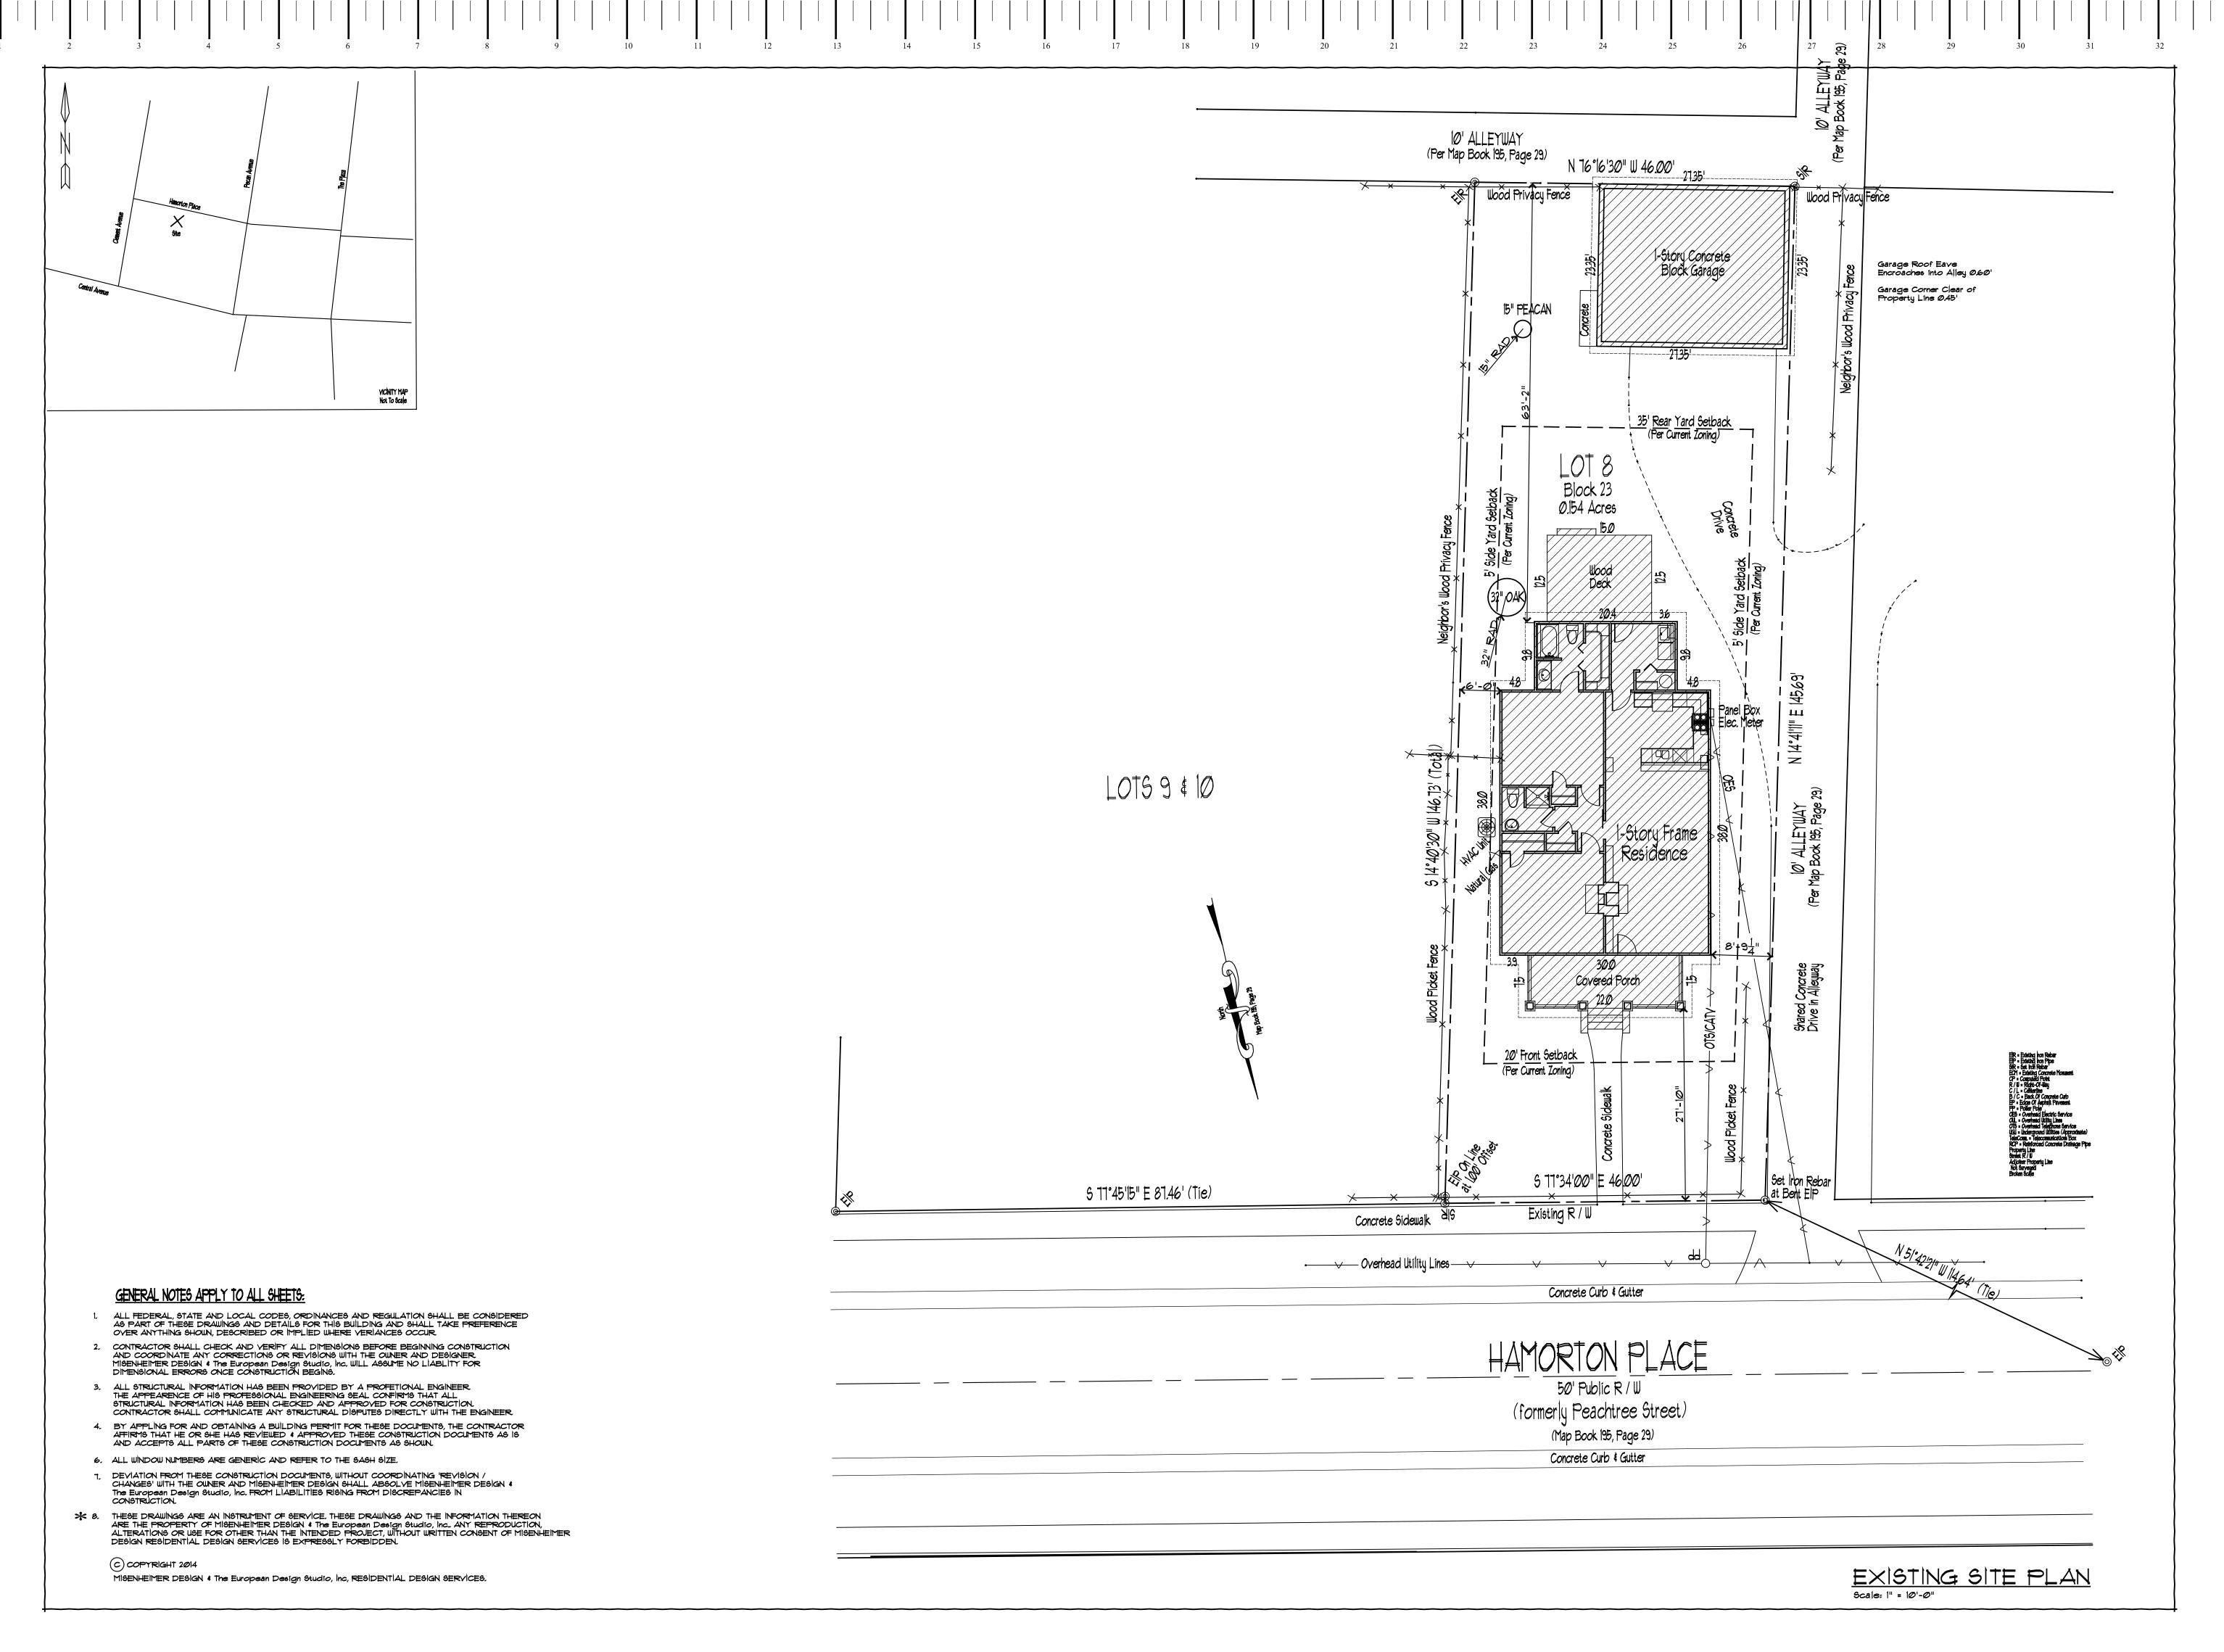






Site Plan/Survey









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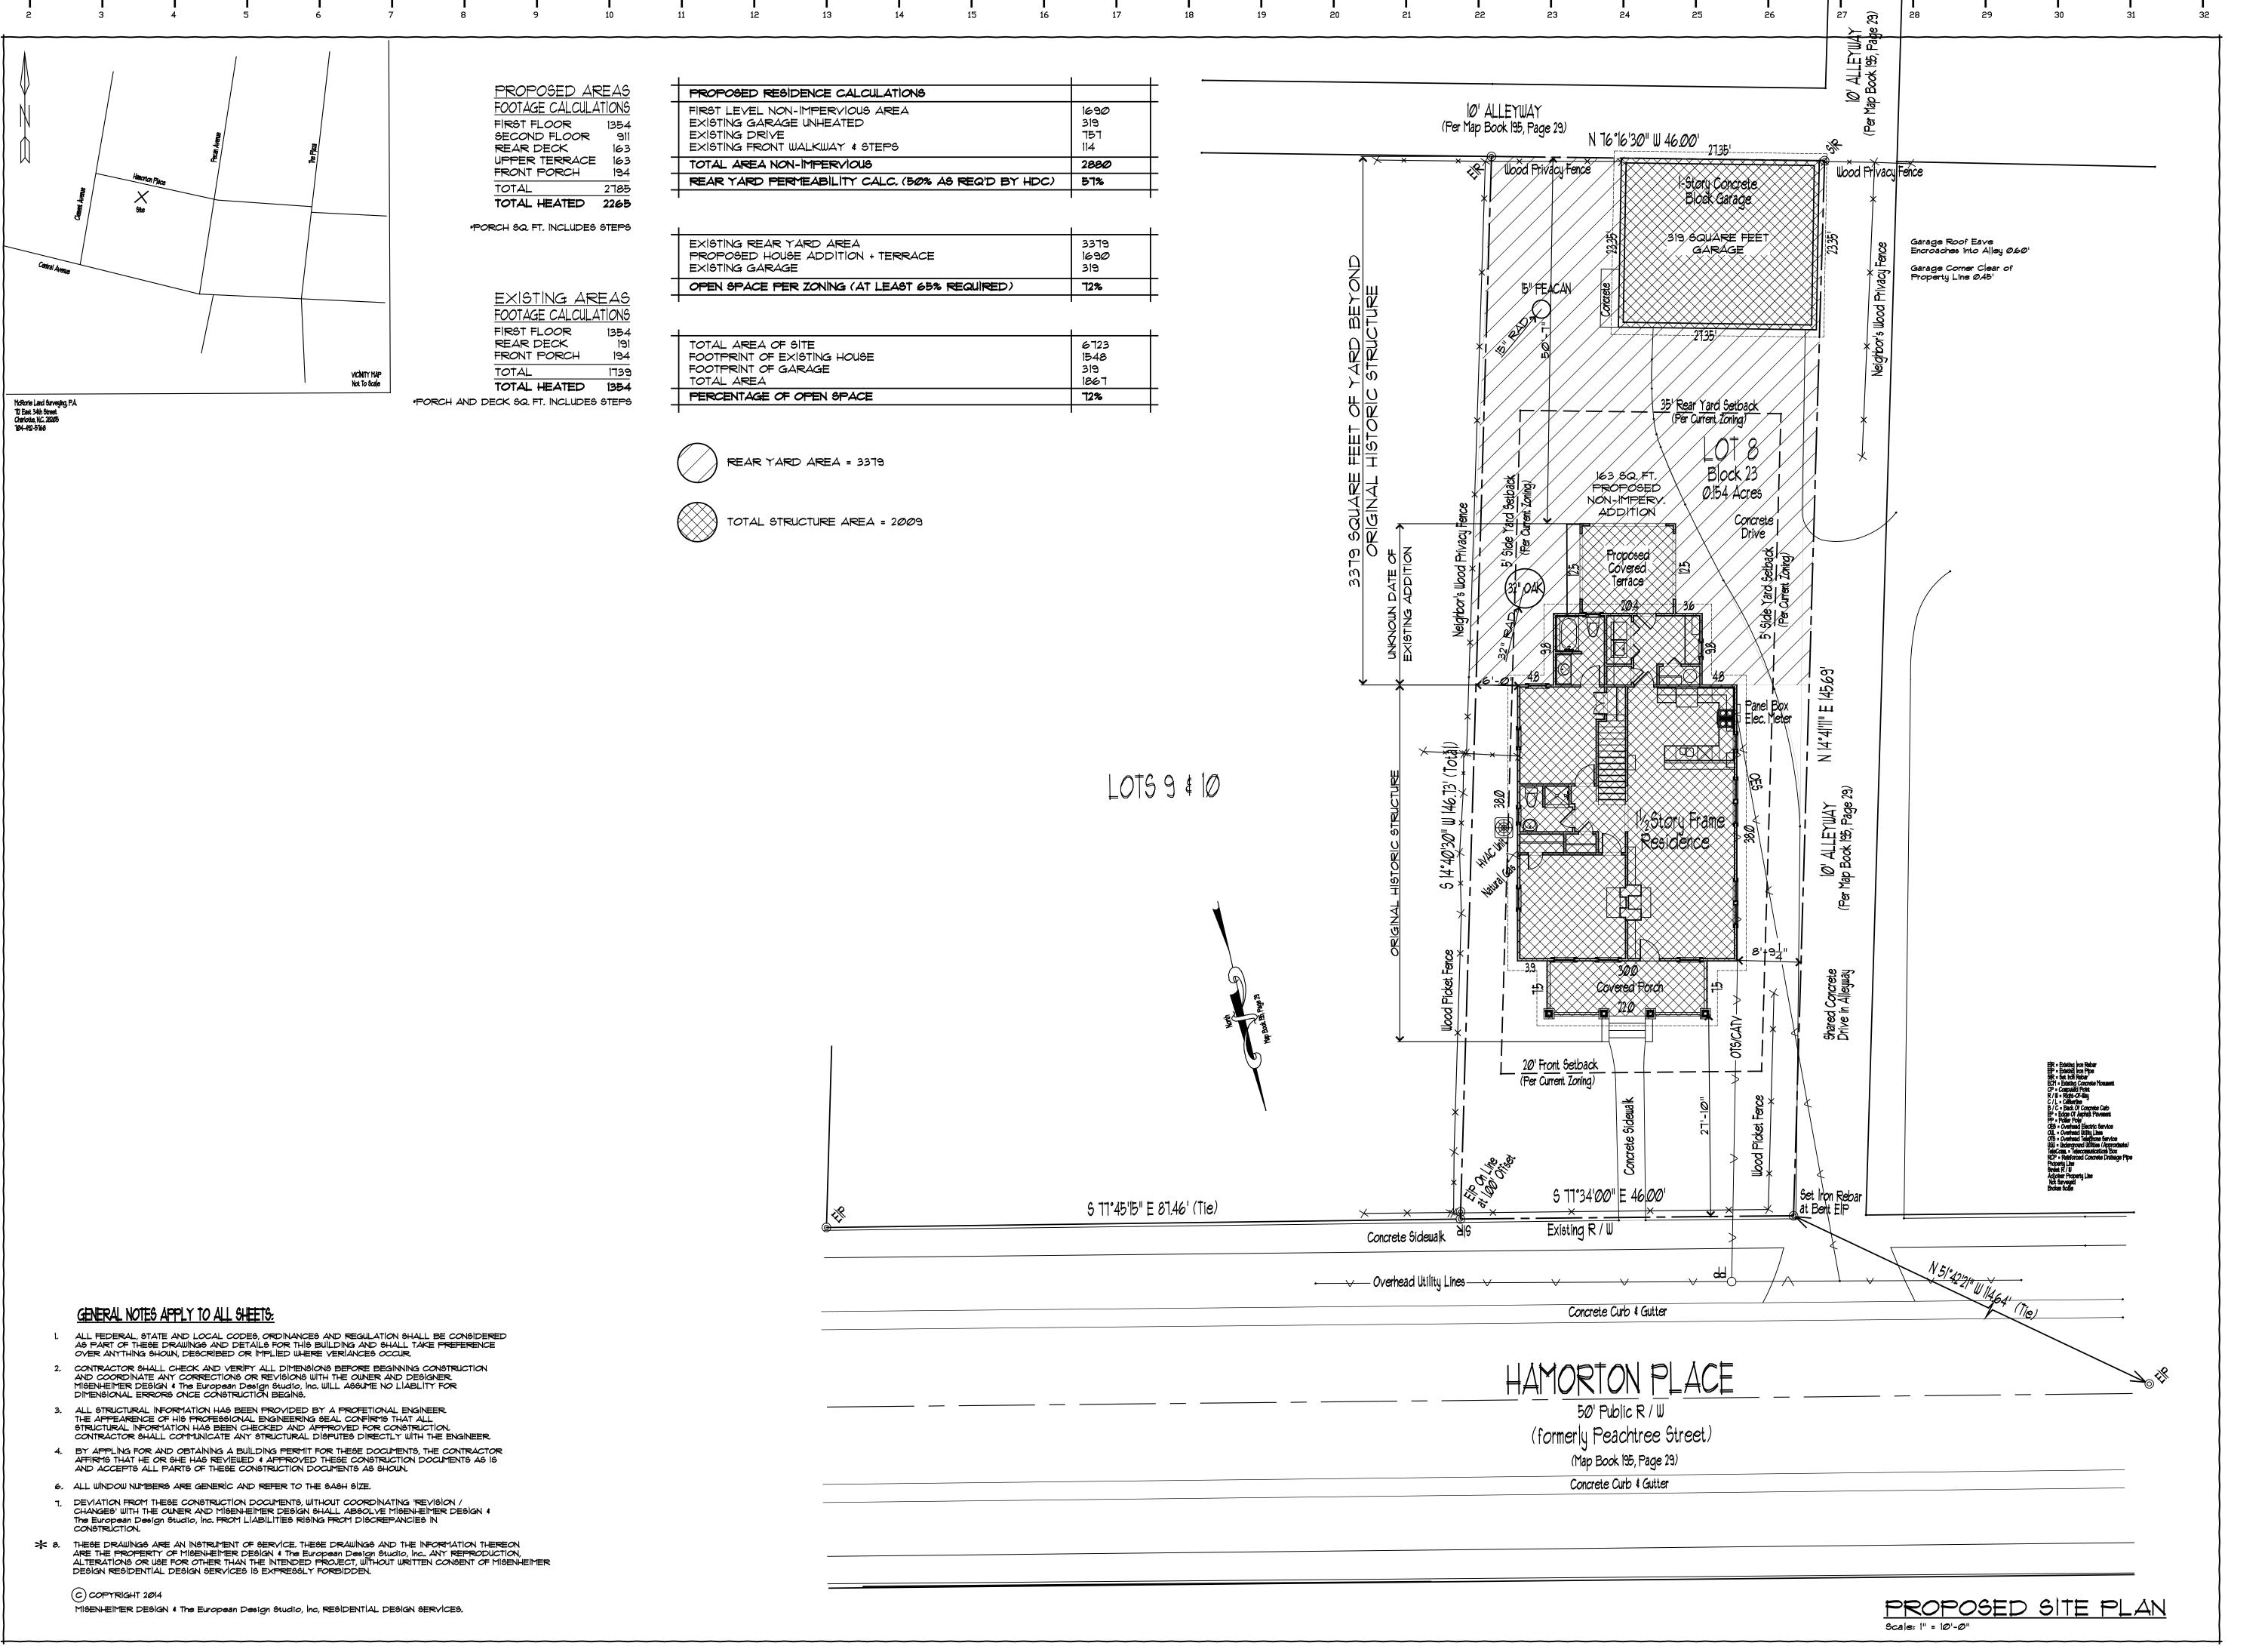
Revision Date

DATE: 16 January 2019

DRAWN BY: DLM SHEET NUMBER: L1.0

> EXISITING SITE PLAN

L1.0



residential design services

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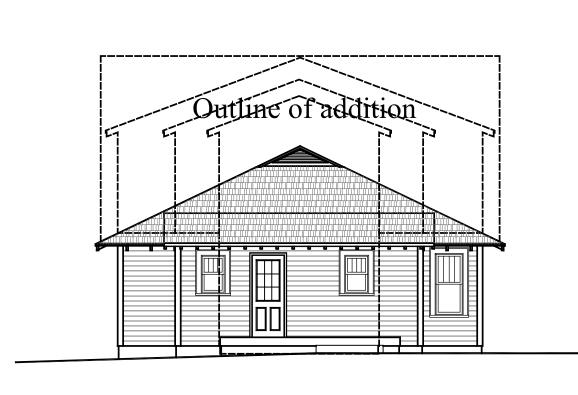
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> PROPOSED SITE PLAN

L1.1

Front & Rear Elevations - Existing and Proposed



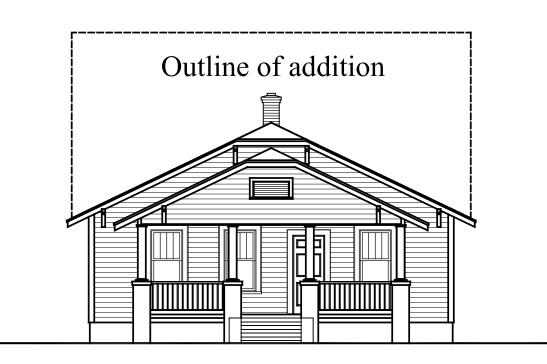
Existing Rear Elevation

Scale: 1/4"=1'-0"

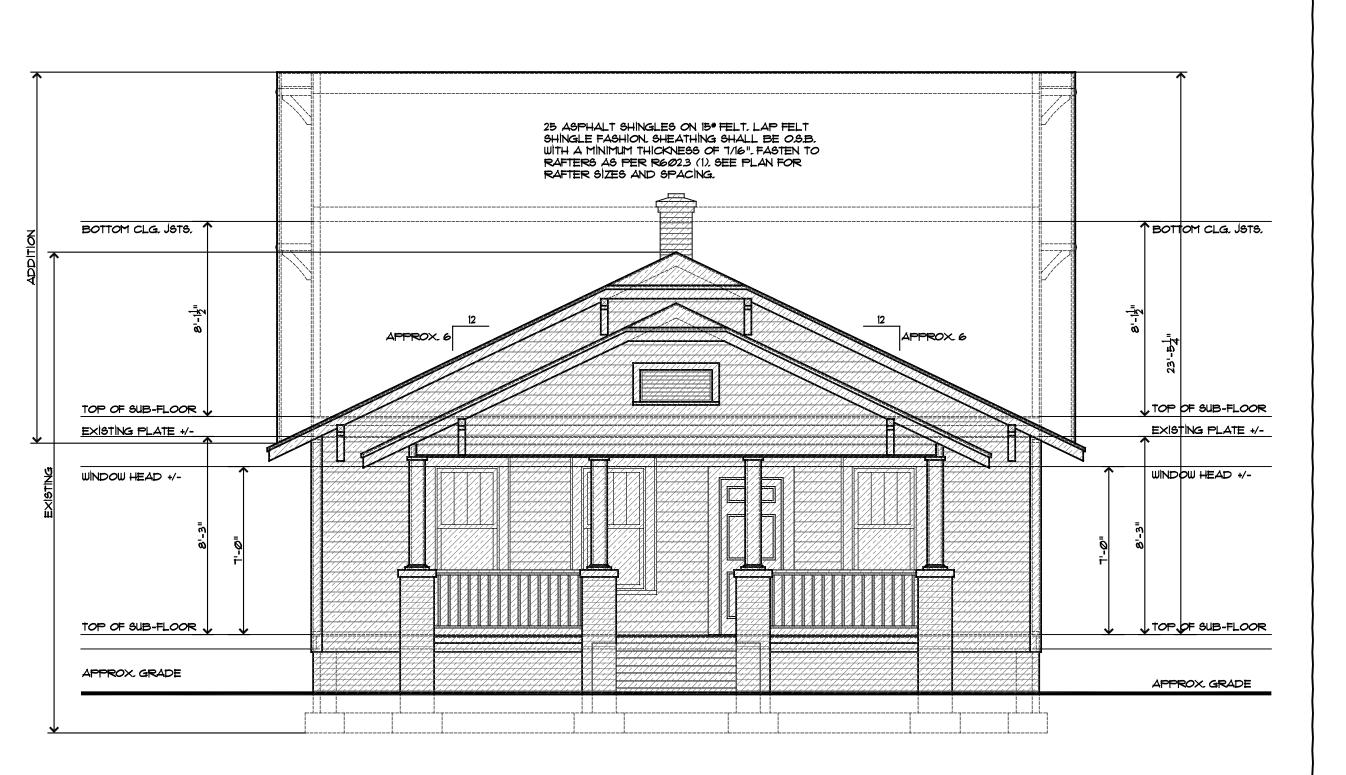


Proposed Rear Elevation

Scale: 1/4"=1'-0"

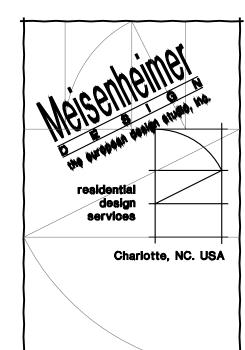


Existing Front Elevation
Scale: 1/4"=1'-0"



Proposed Front Elevation

Scale: 1/4"=1'-0"



704-906-8361 Phone



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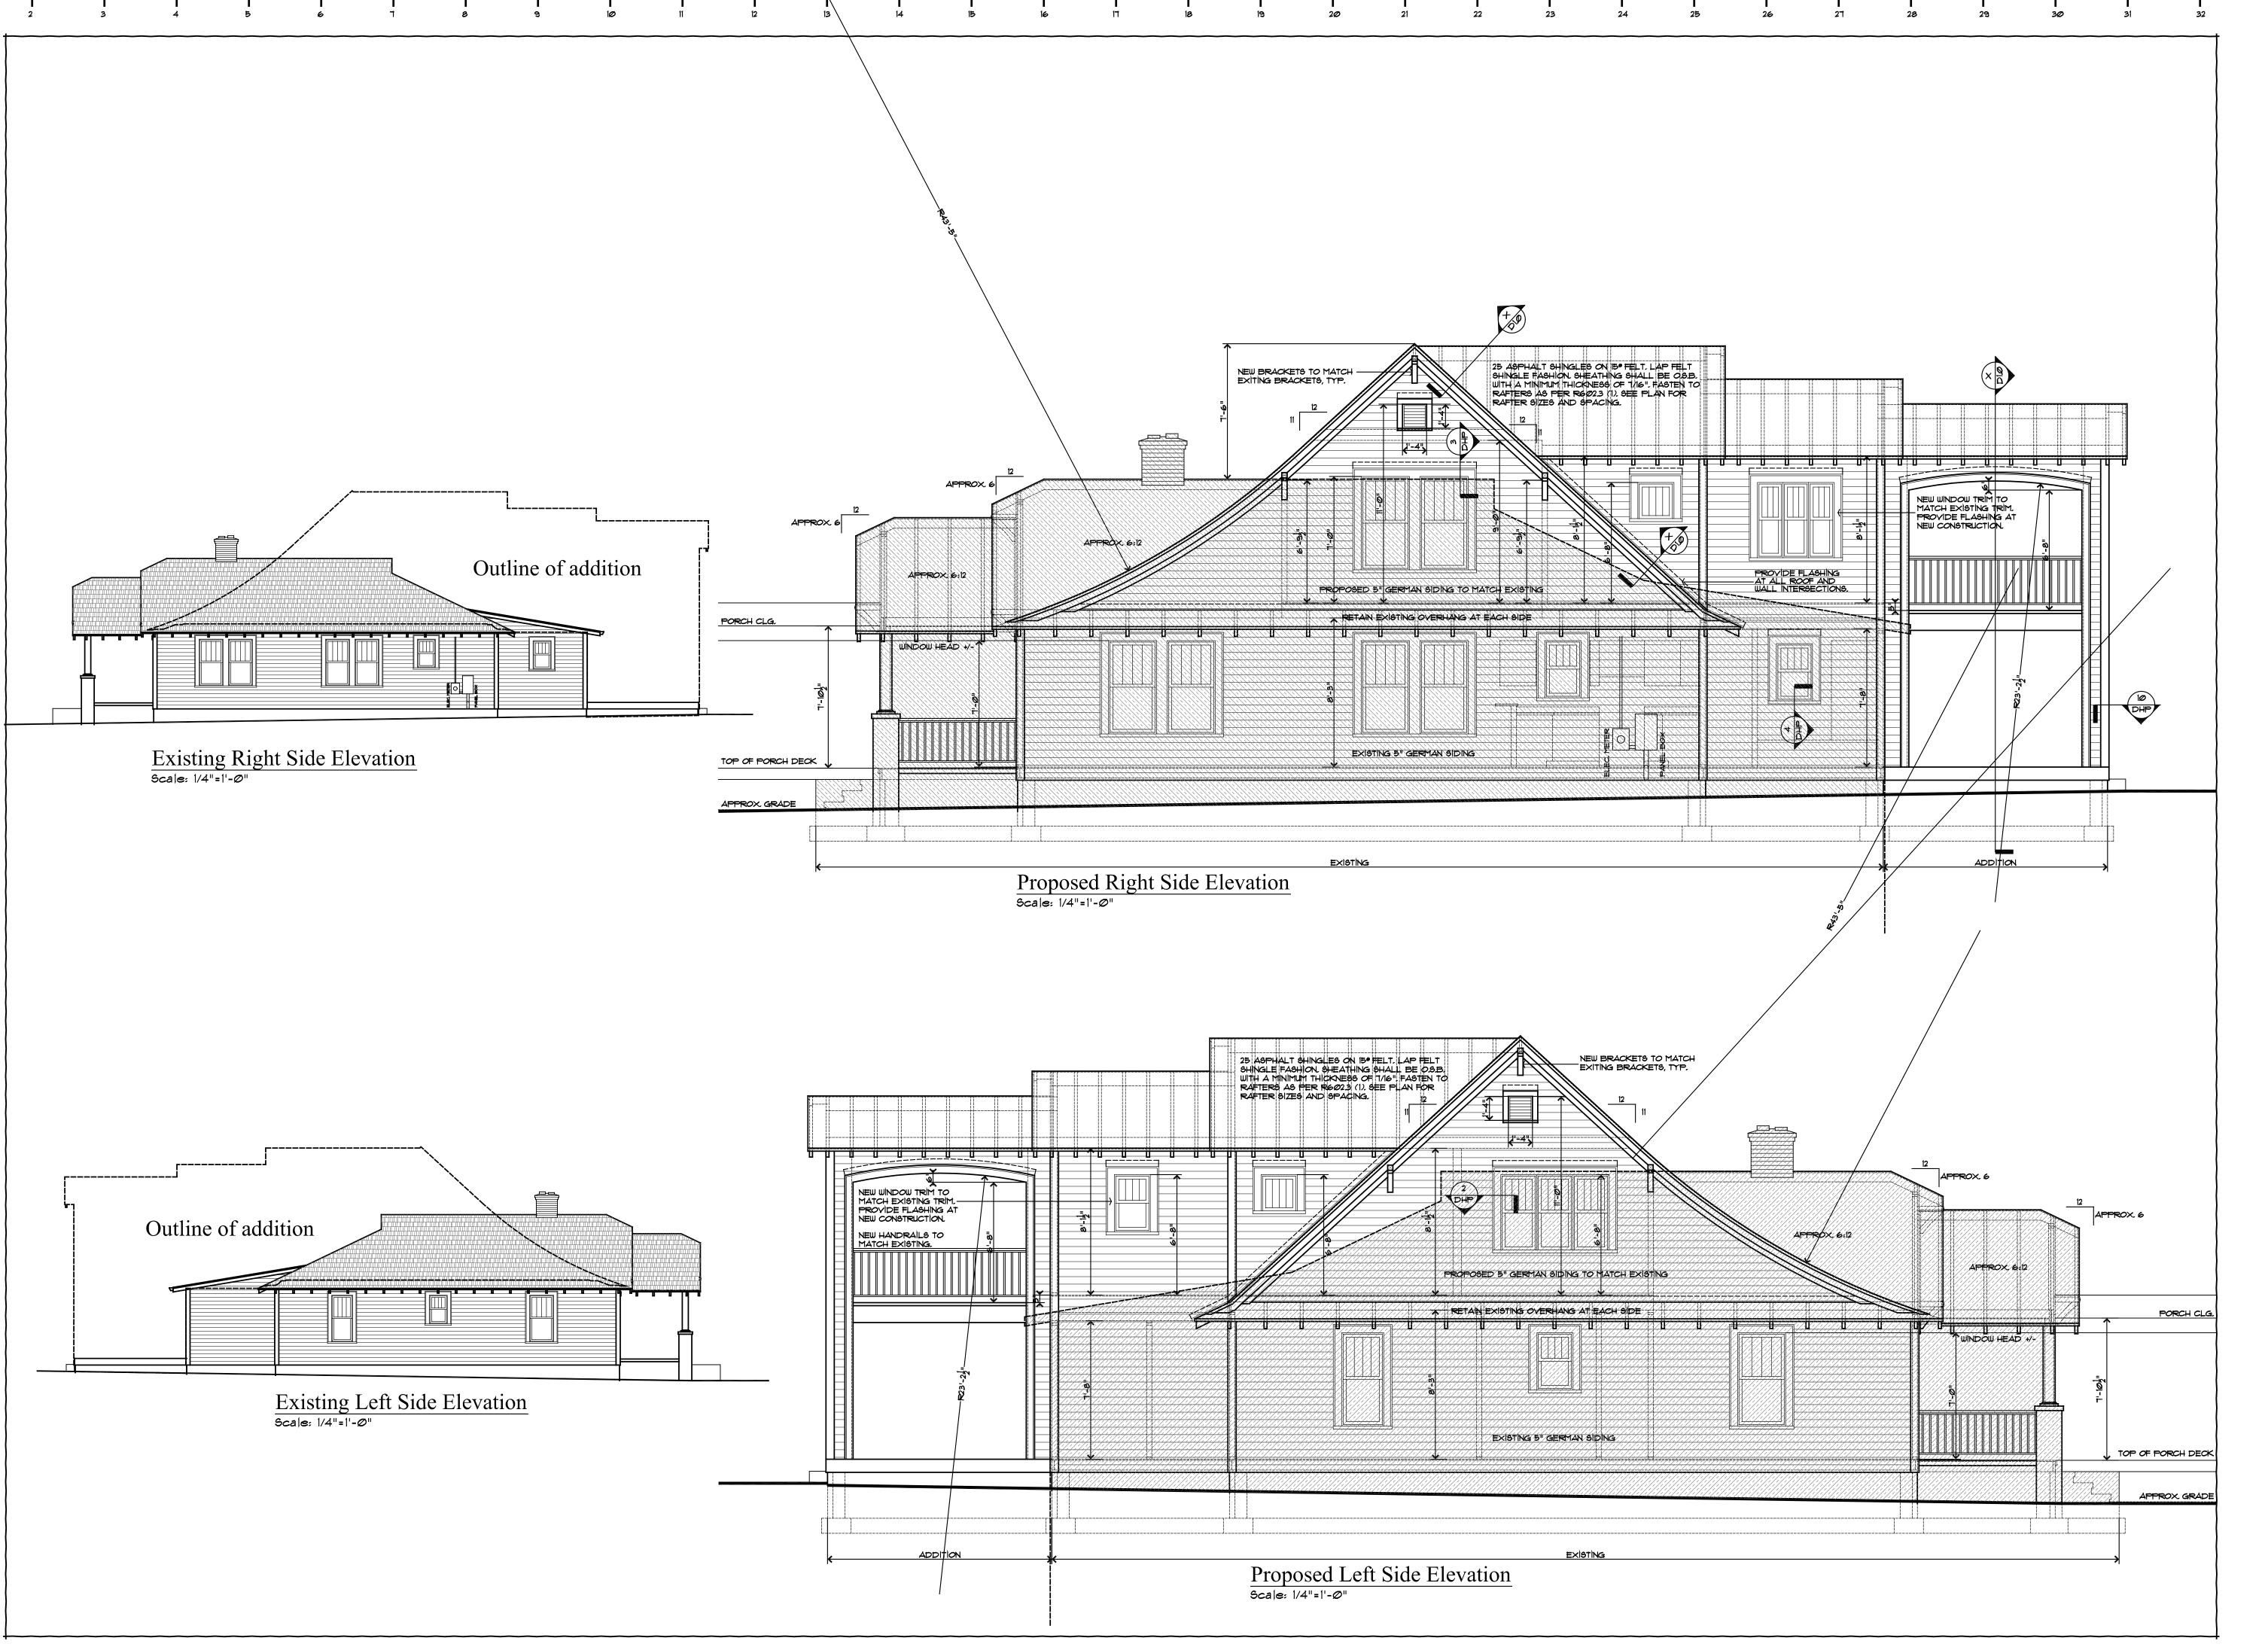
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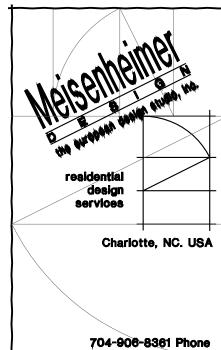
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> PROPOSED FRONT & REAR ELEVATIONS

A4.0

Left & Right Elevations - Existing and Proposed





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PROPOSED RIGHT & LEFT SIDE ELEVATIONS

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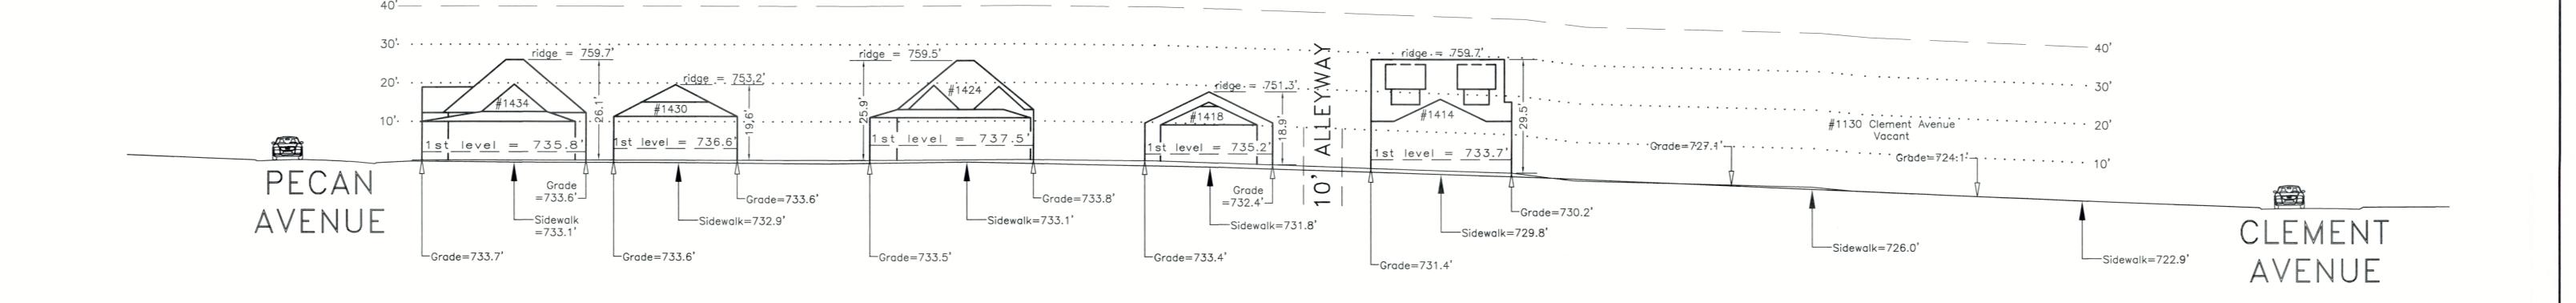
Streetscape Elevations

I hereby certify that this schematic drawing was prepared based on field—surveyed elevation measurements of the points shown hereon. This map is not intended to meet G.S. 47—30 recording requirements.

This 6th day of February, 2019.



Andrew G. Zoutewelle
Professional Land Surveyor
NC License No. L-3098



HAMORTON PLACE

A.G. ZOUTEWELLE SURVEYORS

1418 East Fifth St. Charlotte, NC 28204
Phone: 704-372-9444 Fax: 704-372-9555
Firm Licensure Number C-1054

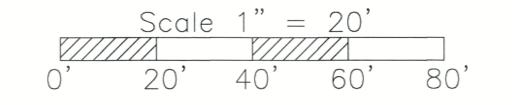
Building Heights Sketch of

1400 BLOCK of HAMORTON PLACE

FACING SOUTHWEST - EVEN SIDE

CHARLOTTE, MECKLENBURG COUNTY, N.C.

for Charlotte-Mecklenburg Planning Department
February 5, 2019

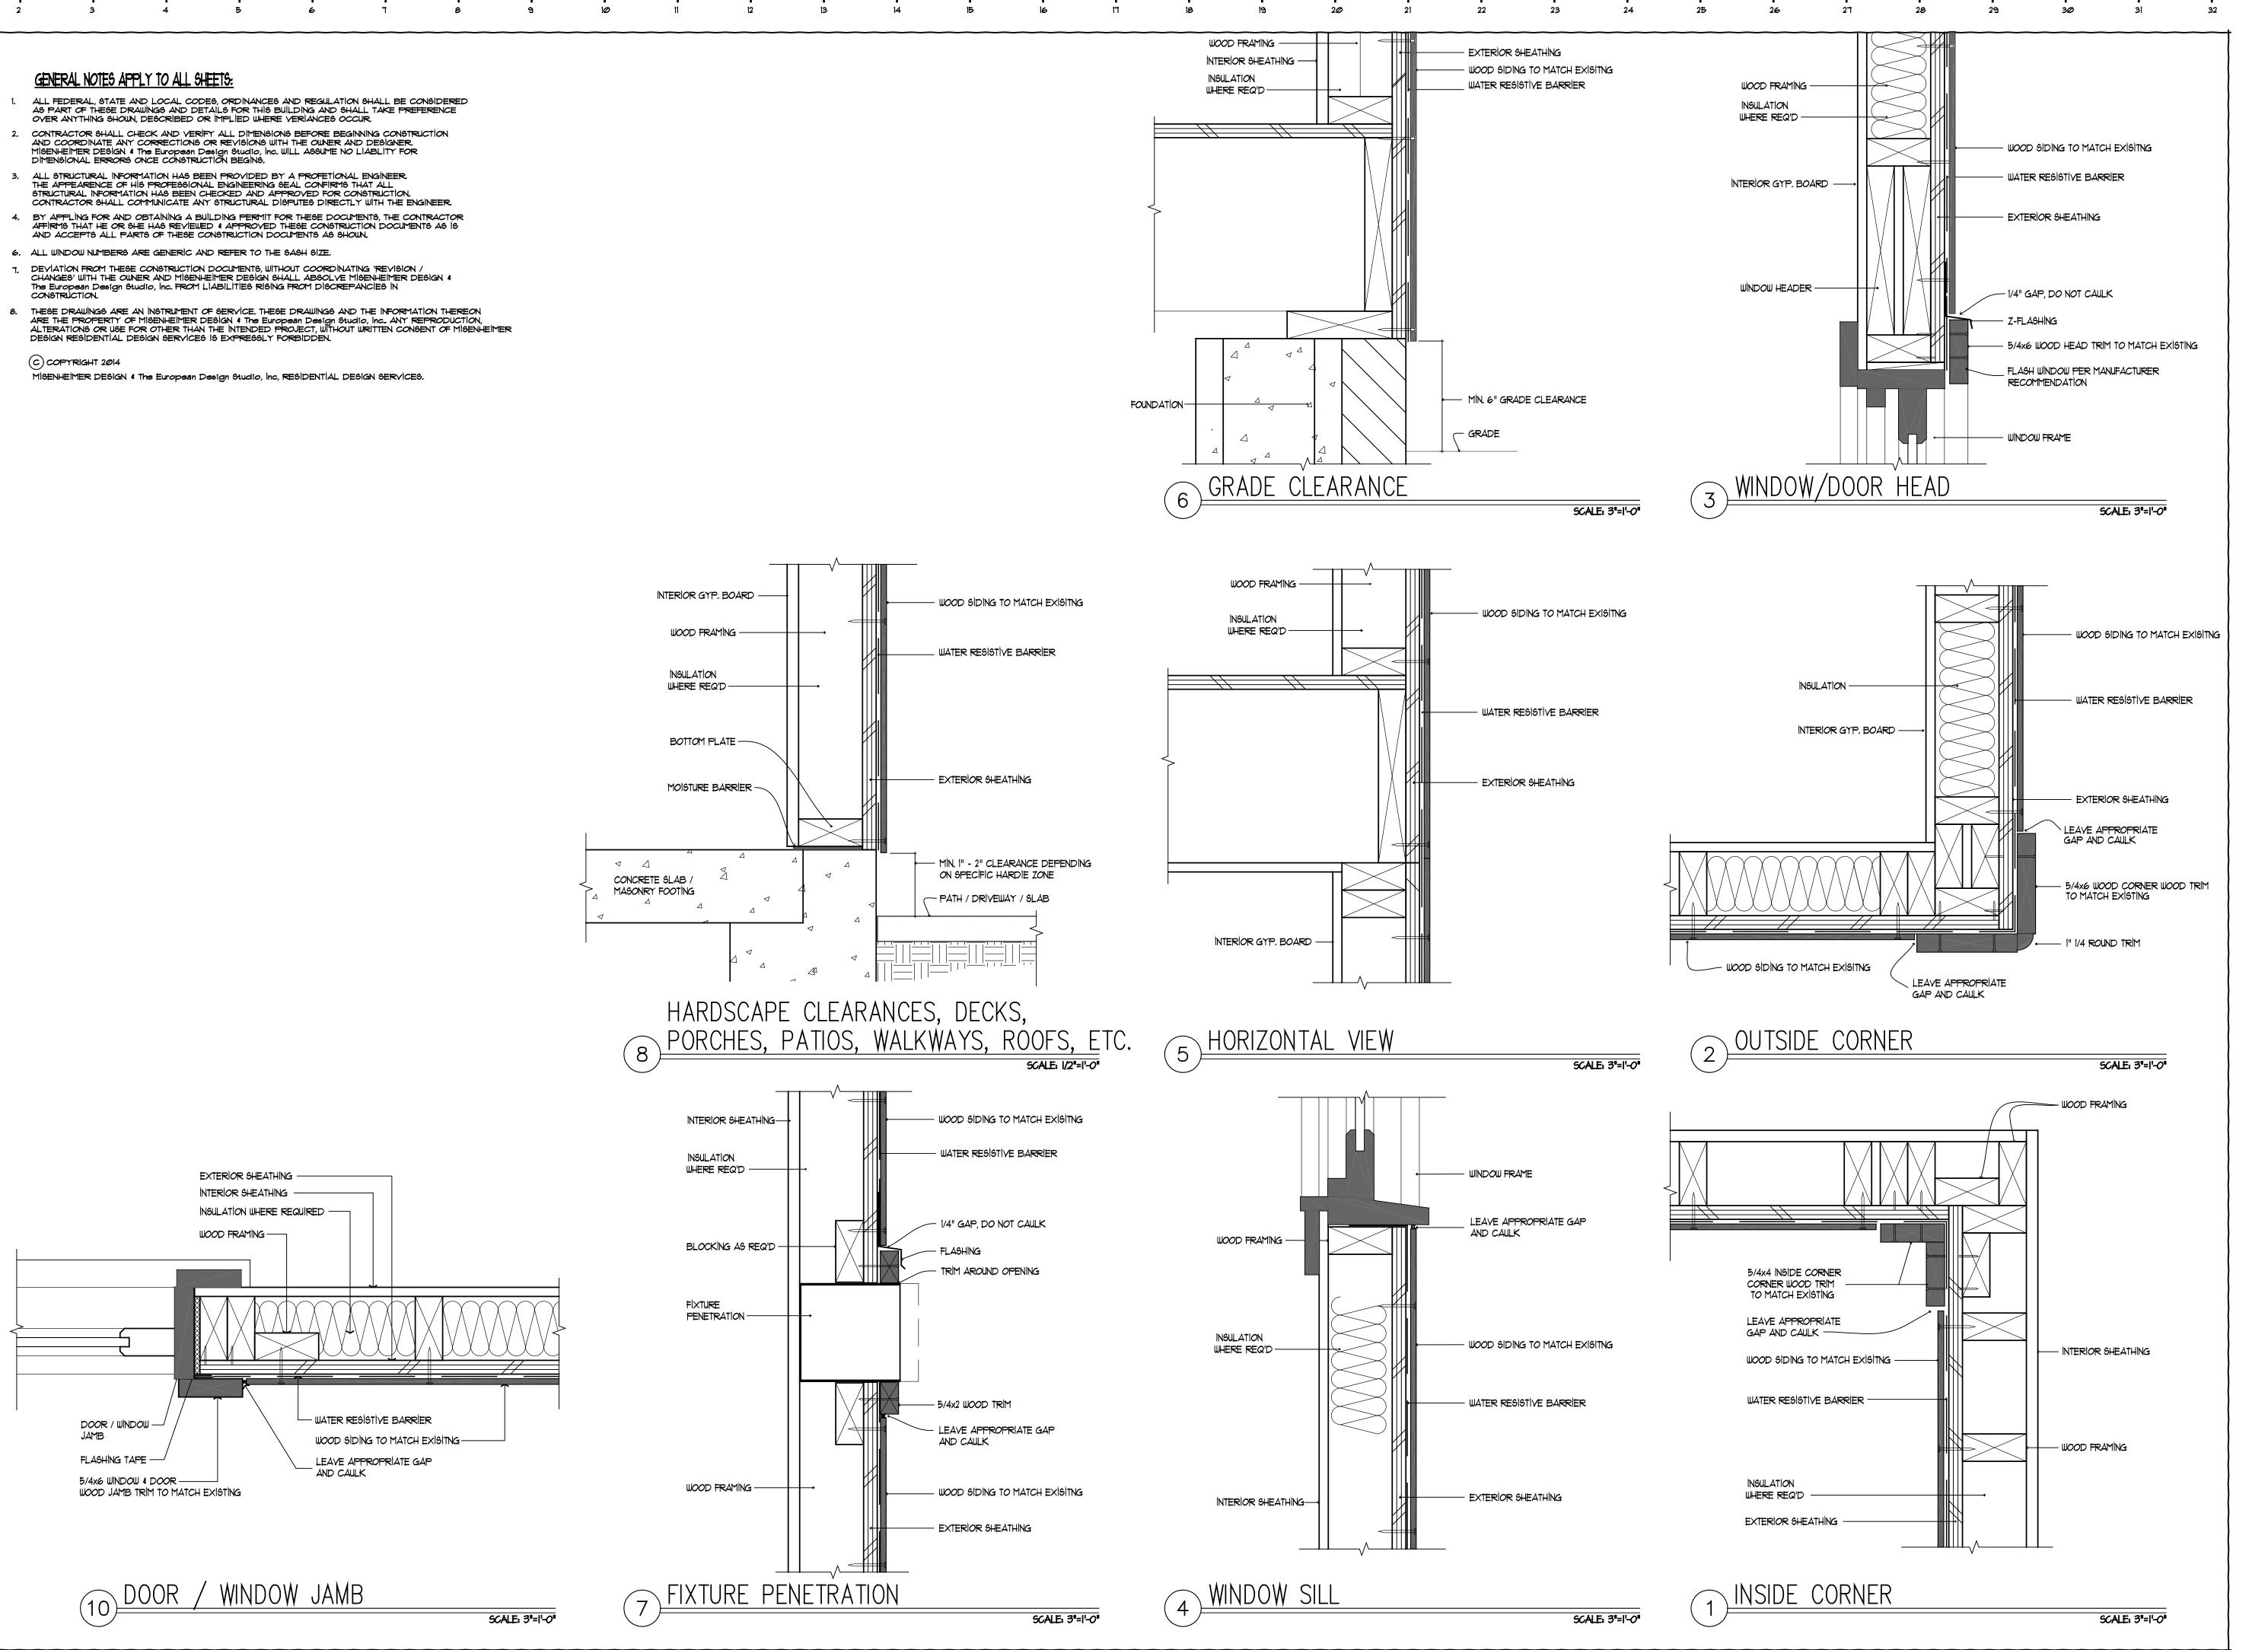


General Notes:

1. The purpose of this Building Heights Sketch is to show existing building facade heights relative to the elevation points at the public sidewalk or top of curb, front yard grade ("Grade"), 1st level, and ridgeline of the houses depicted hereon. No rearyard or sideyard measurements were made. The heights shown hereon were derived from indirect measurements and are not intended for structural design.

2. The vertical datum for these elevation measurements is the North American Vertical Datum of 1988 (i.e., sea level). All other information and graphics are conceptual in nature and are not intended to represent accurate architectural or landscape features.

Architectural Details





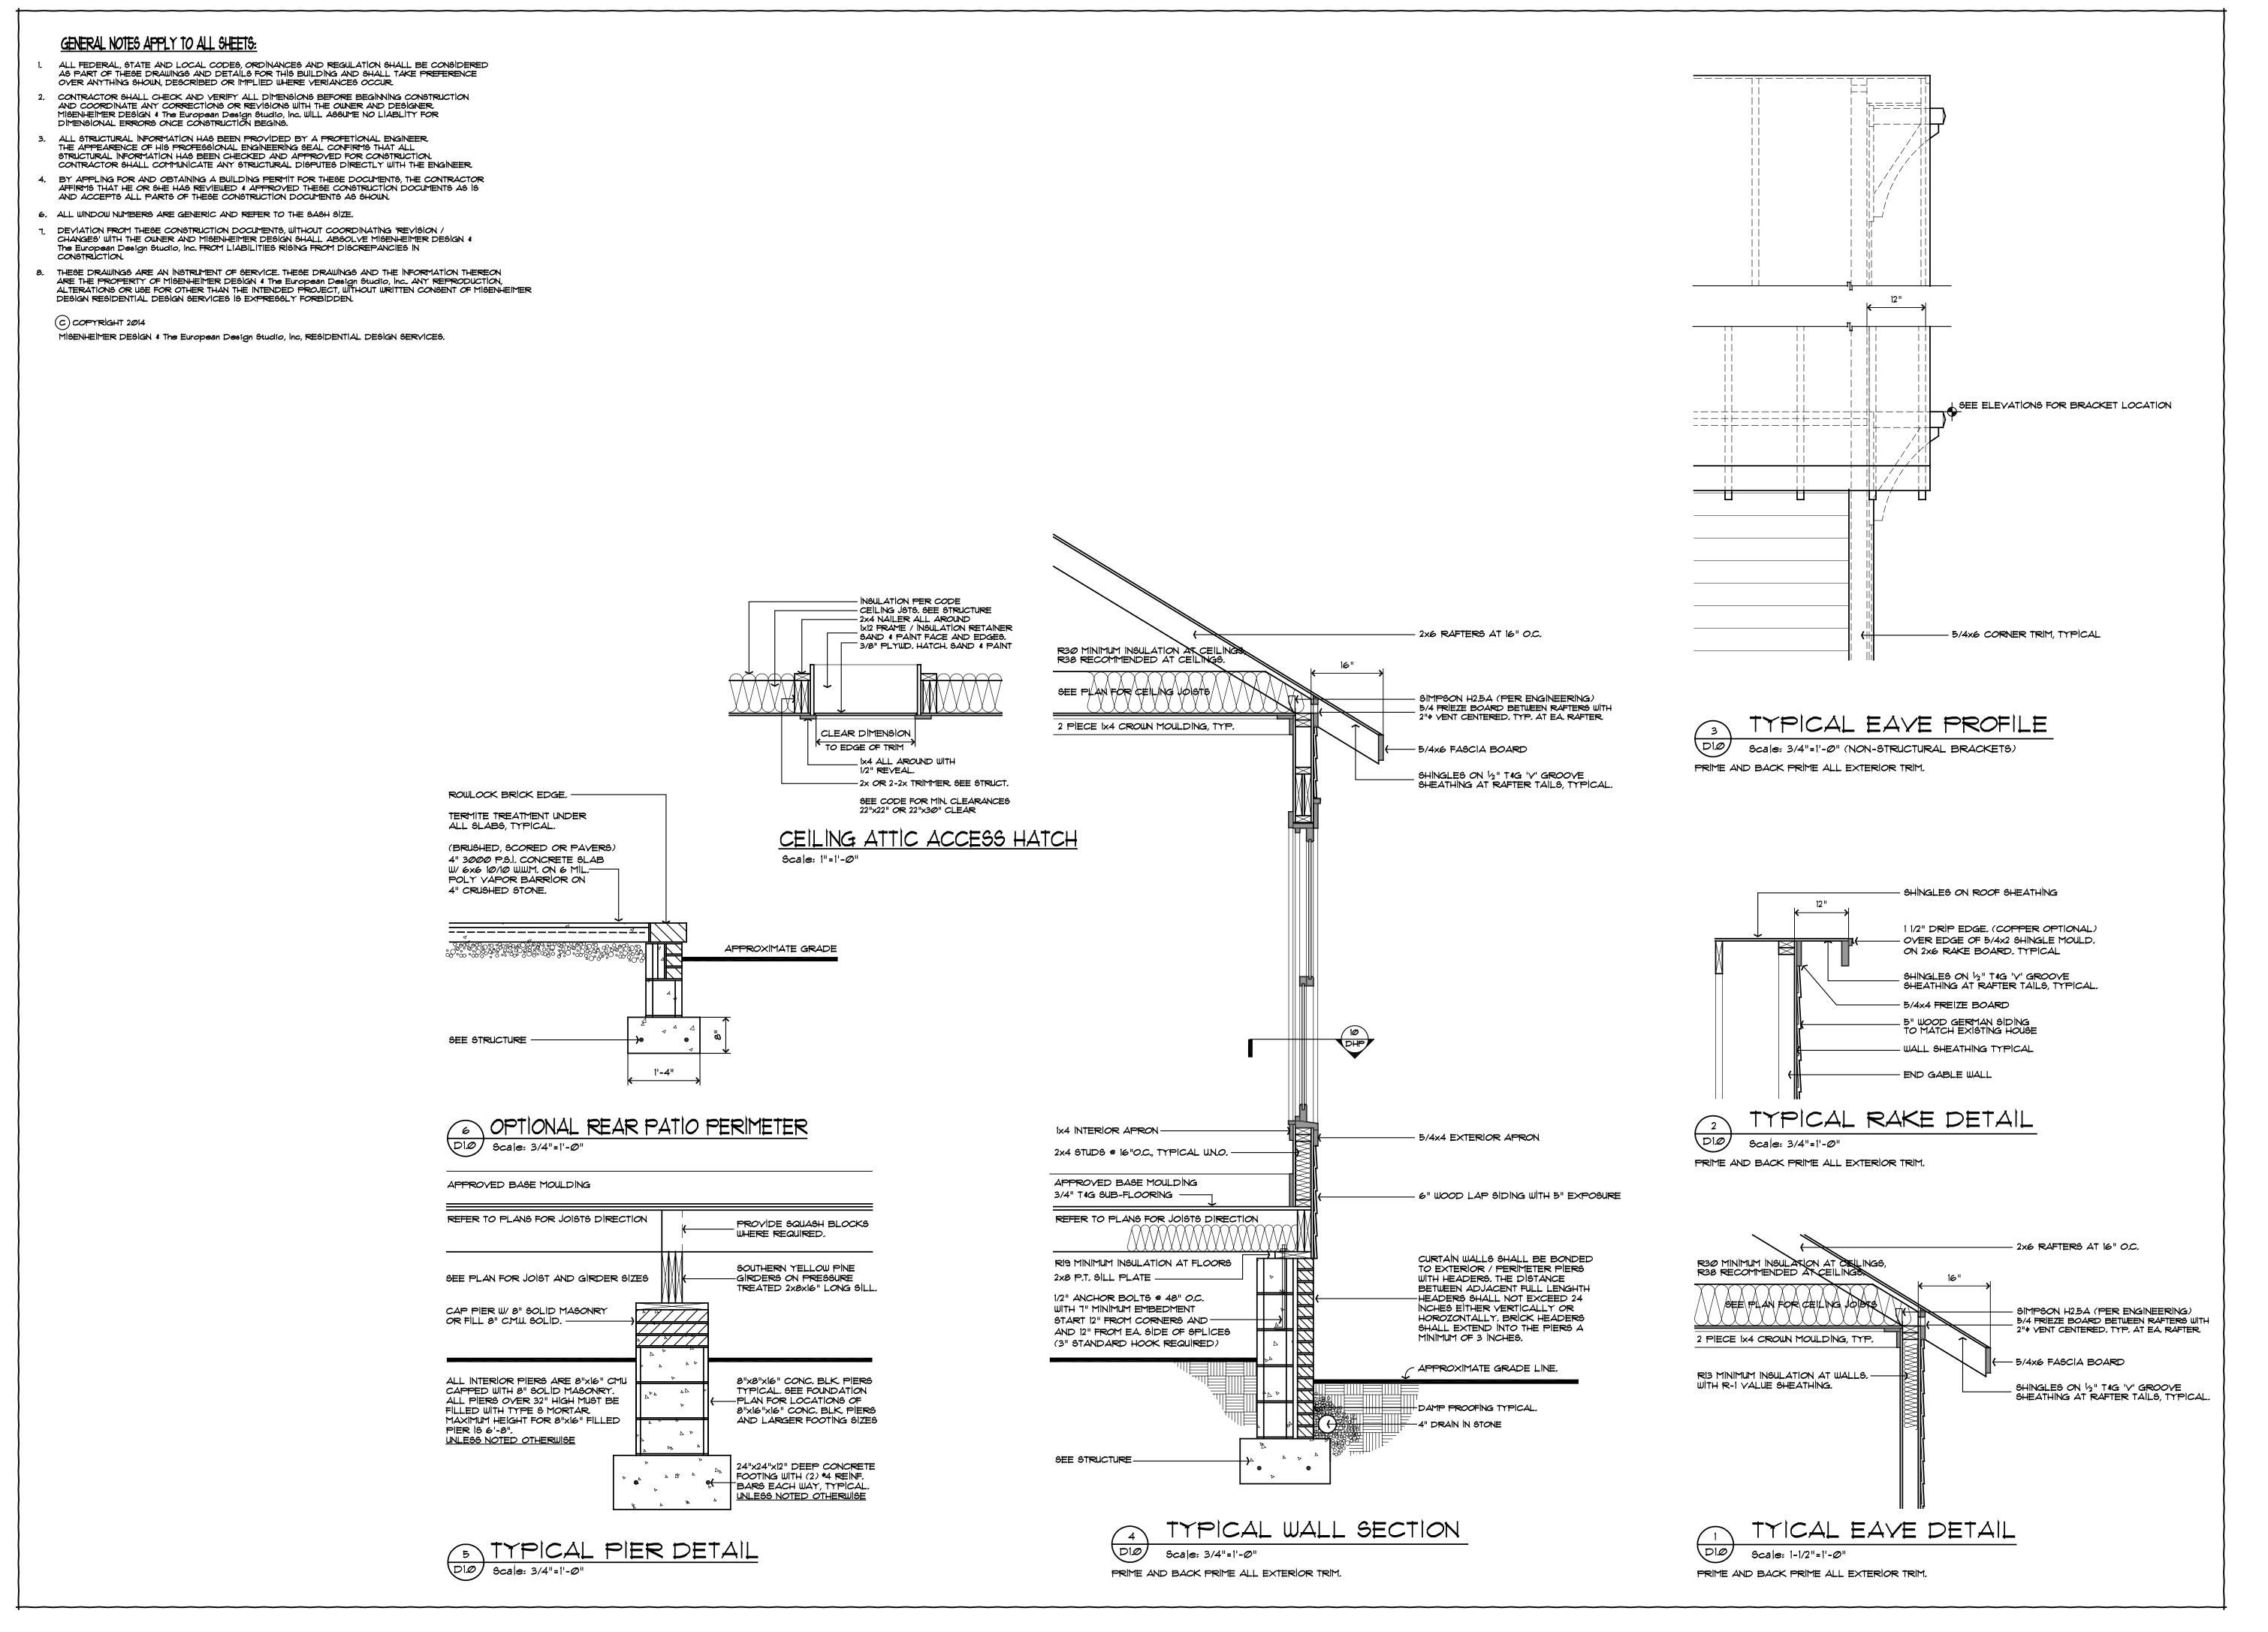
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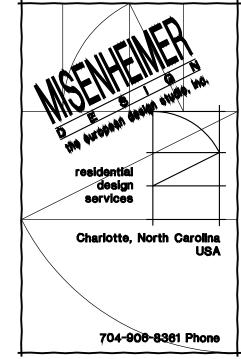
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> DETAIL SHEET

D1.0

GENERAL NOTES APPLY TO ALL SHEETS:

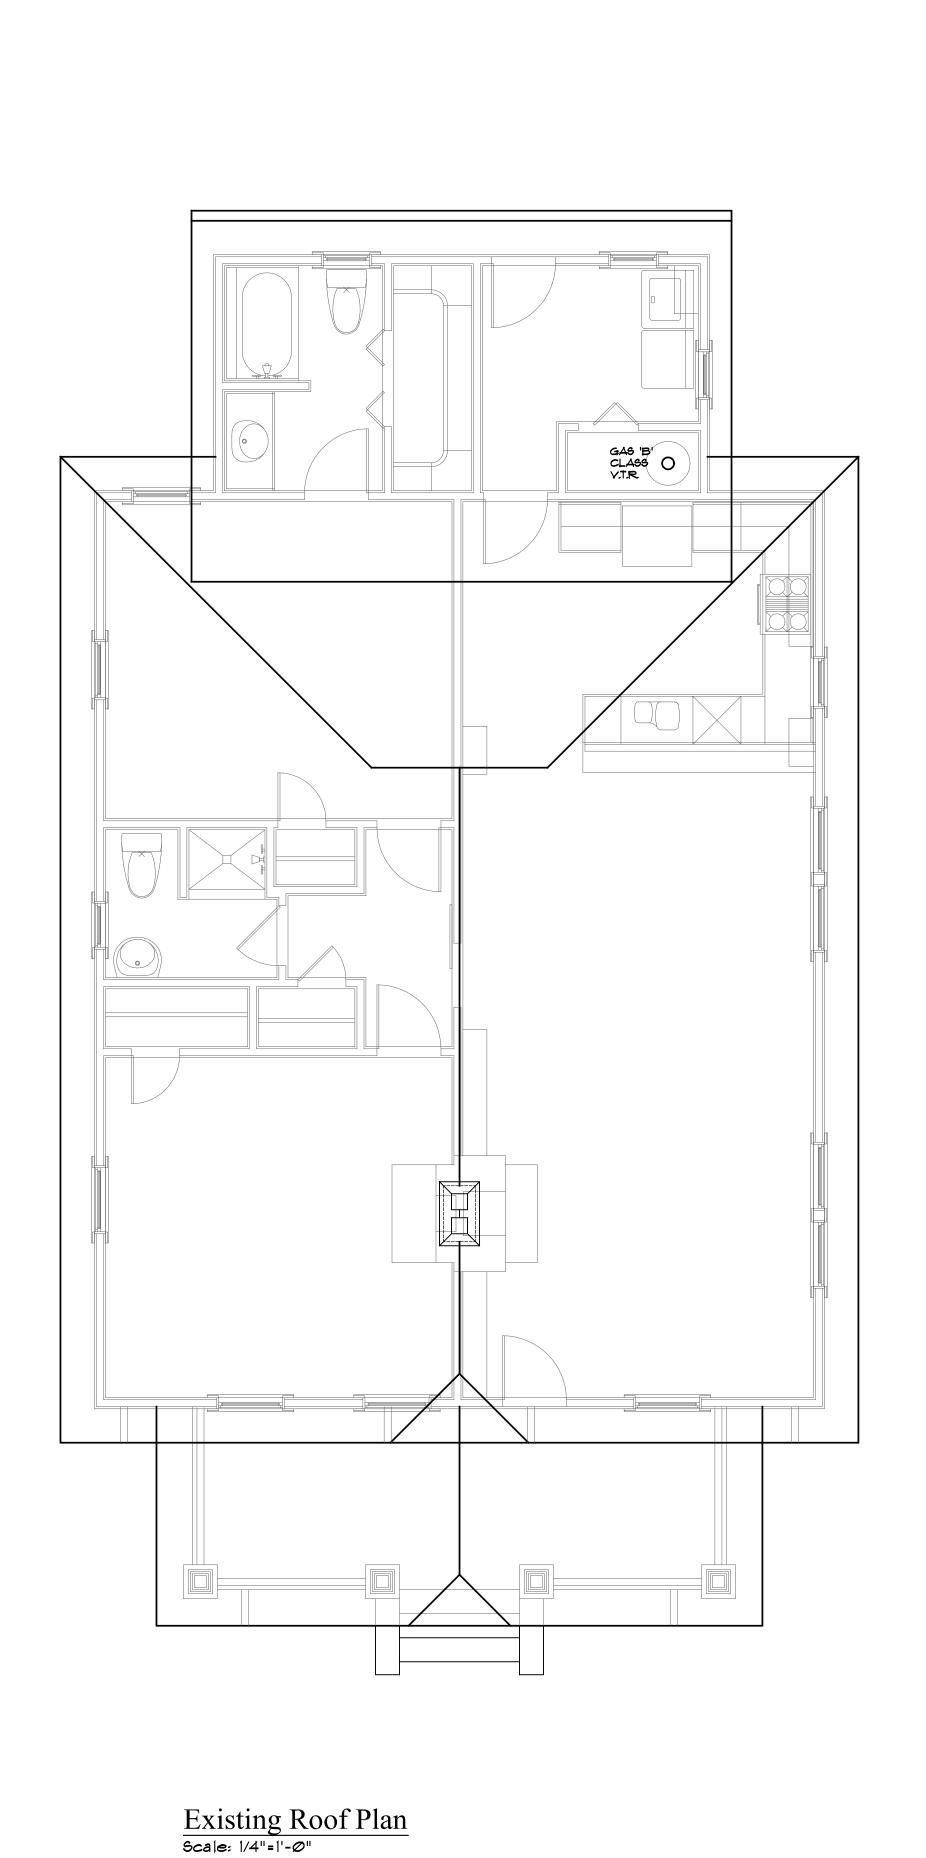
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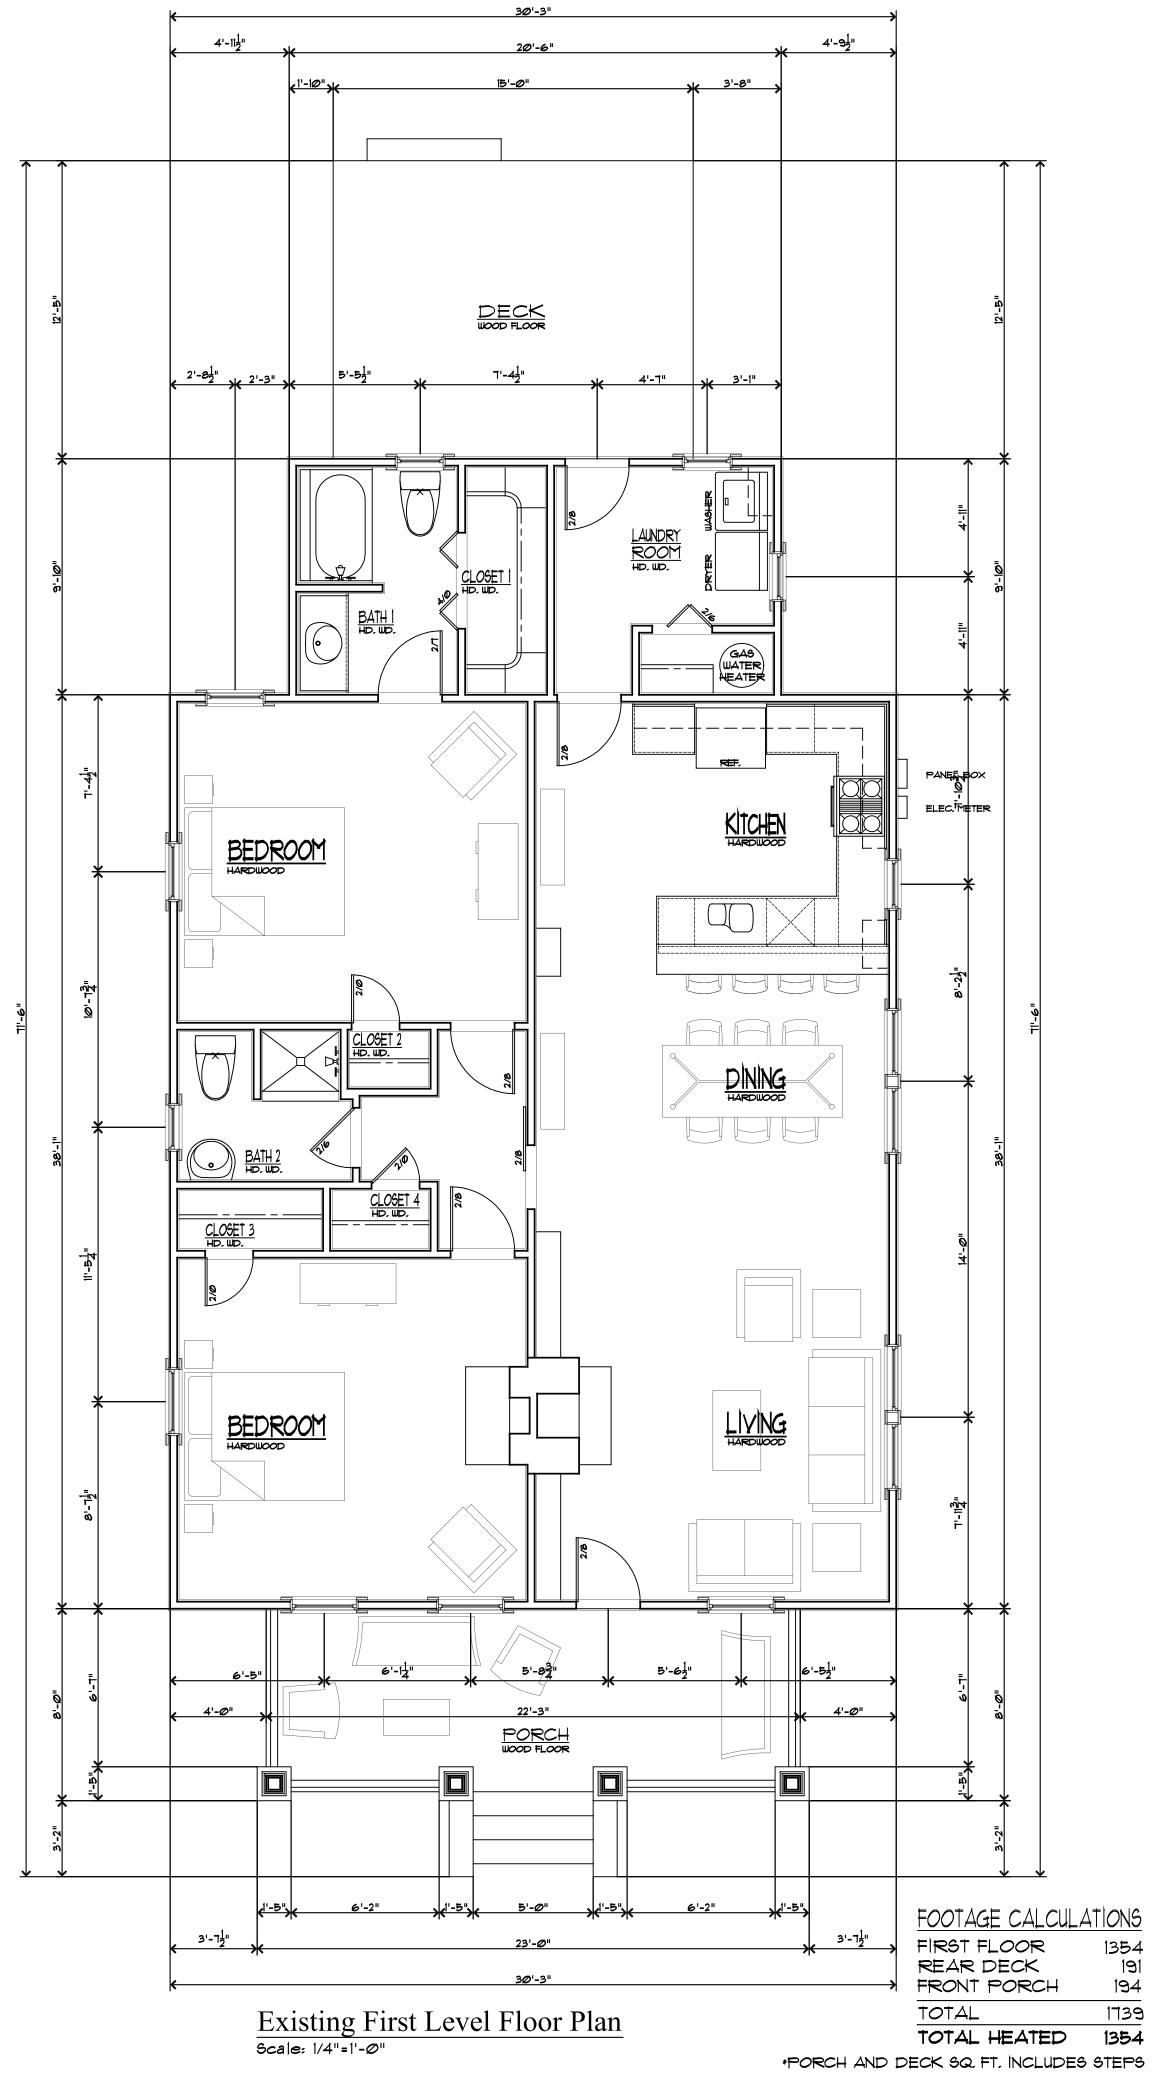
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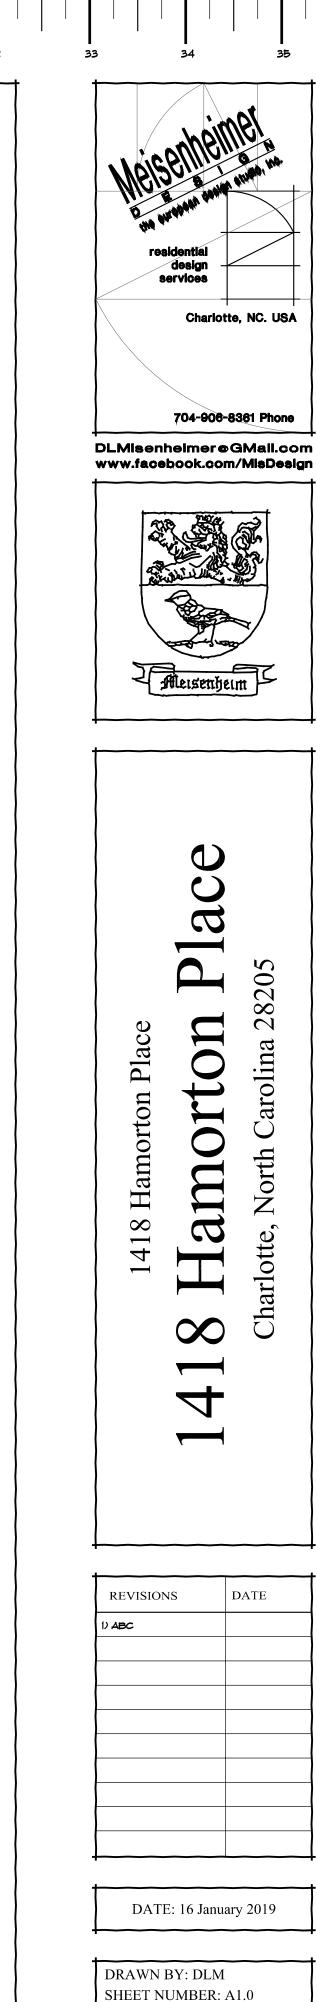
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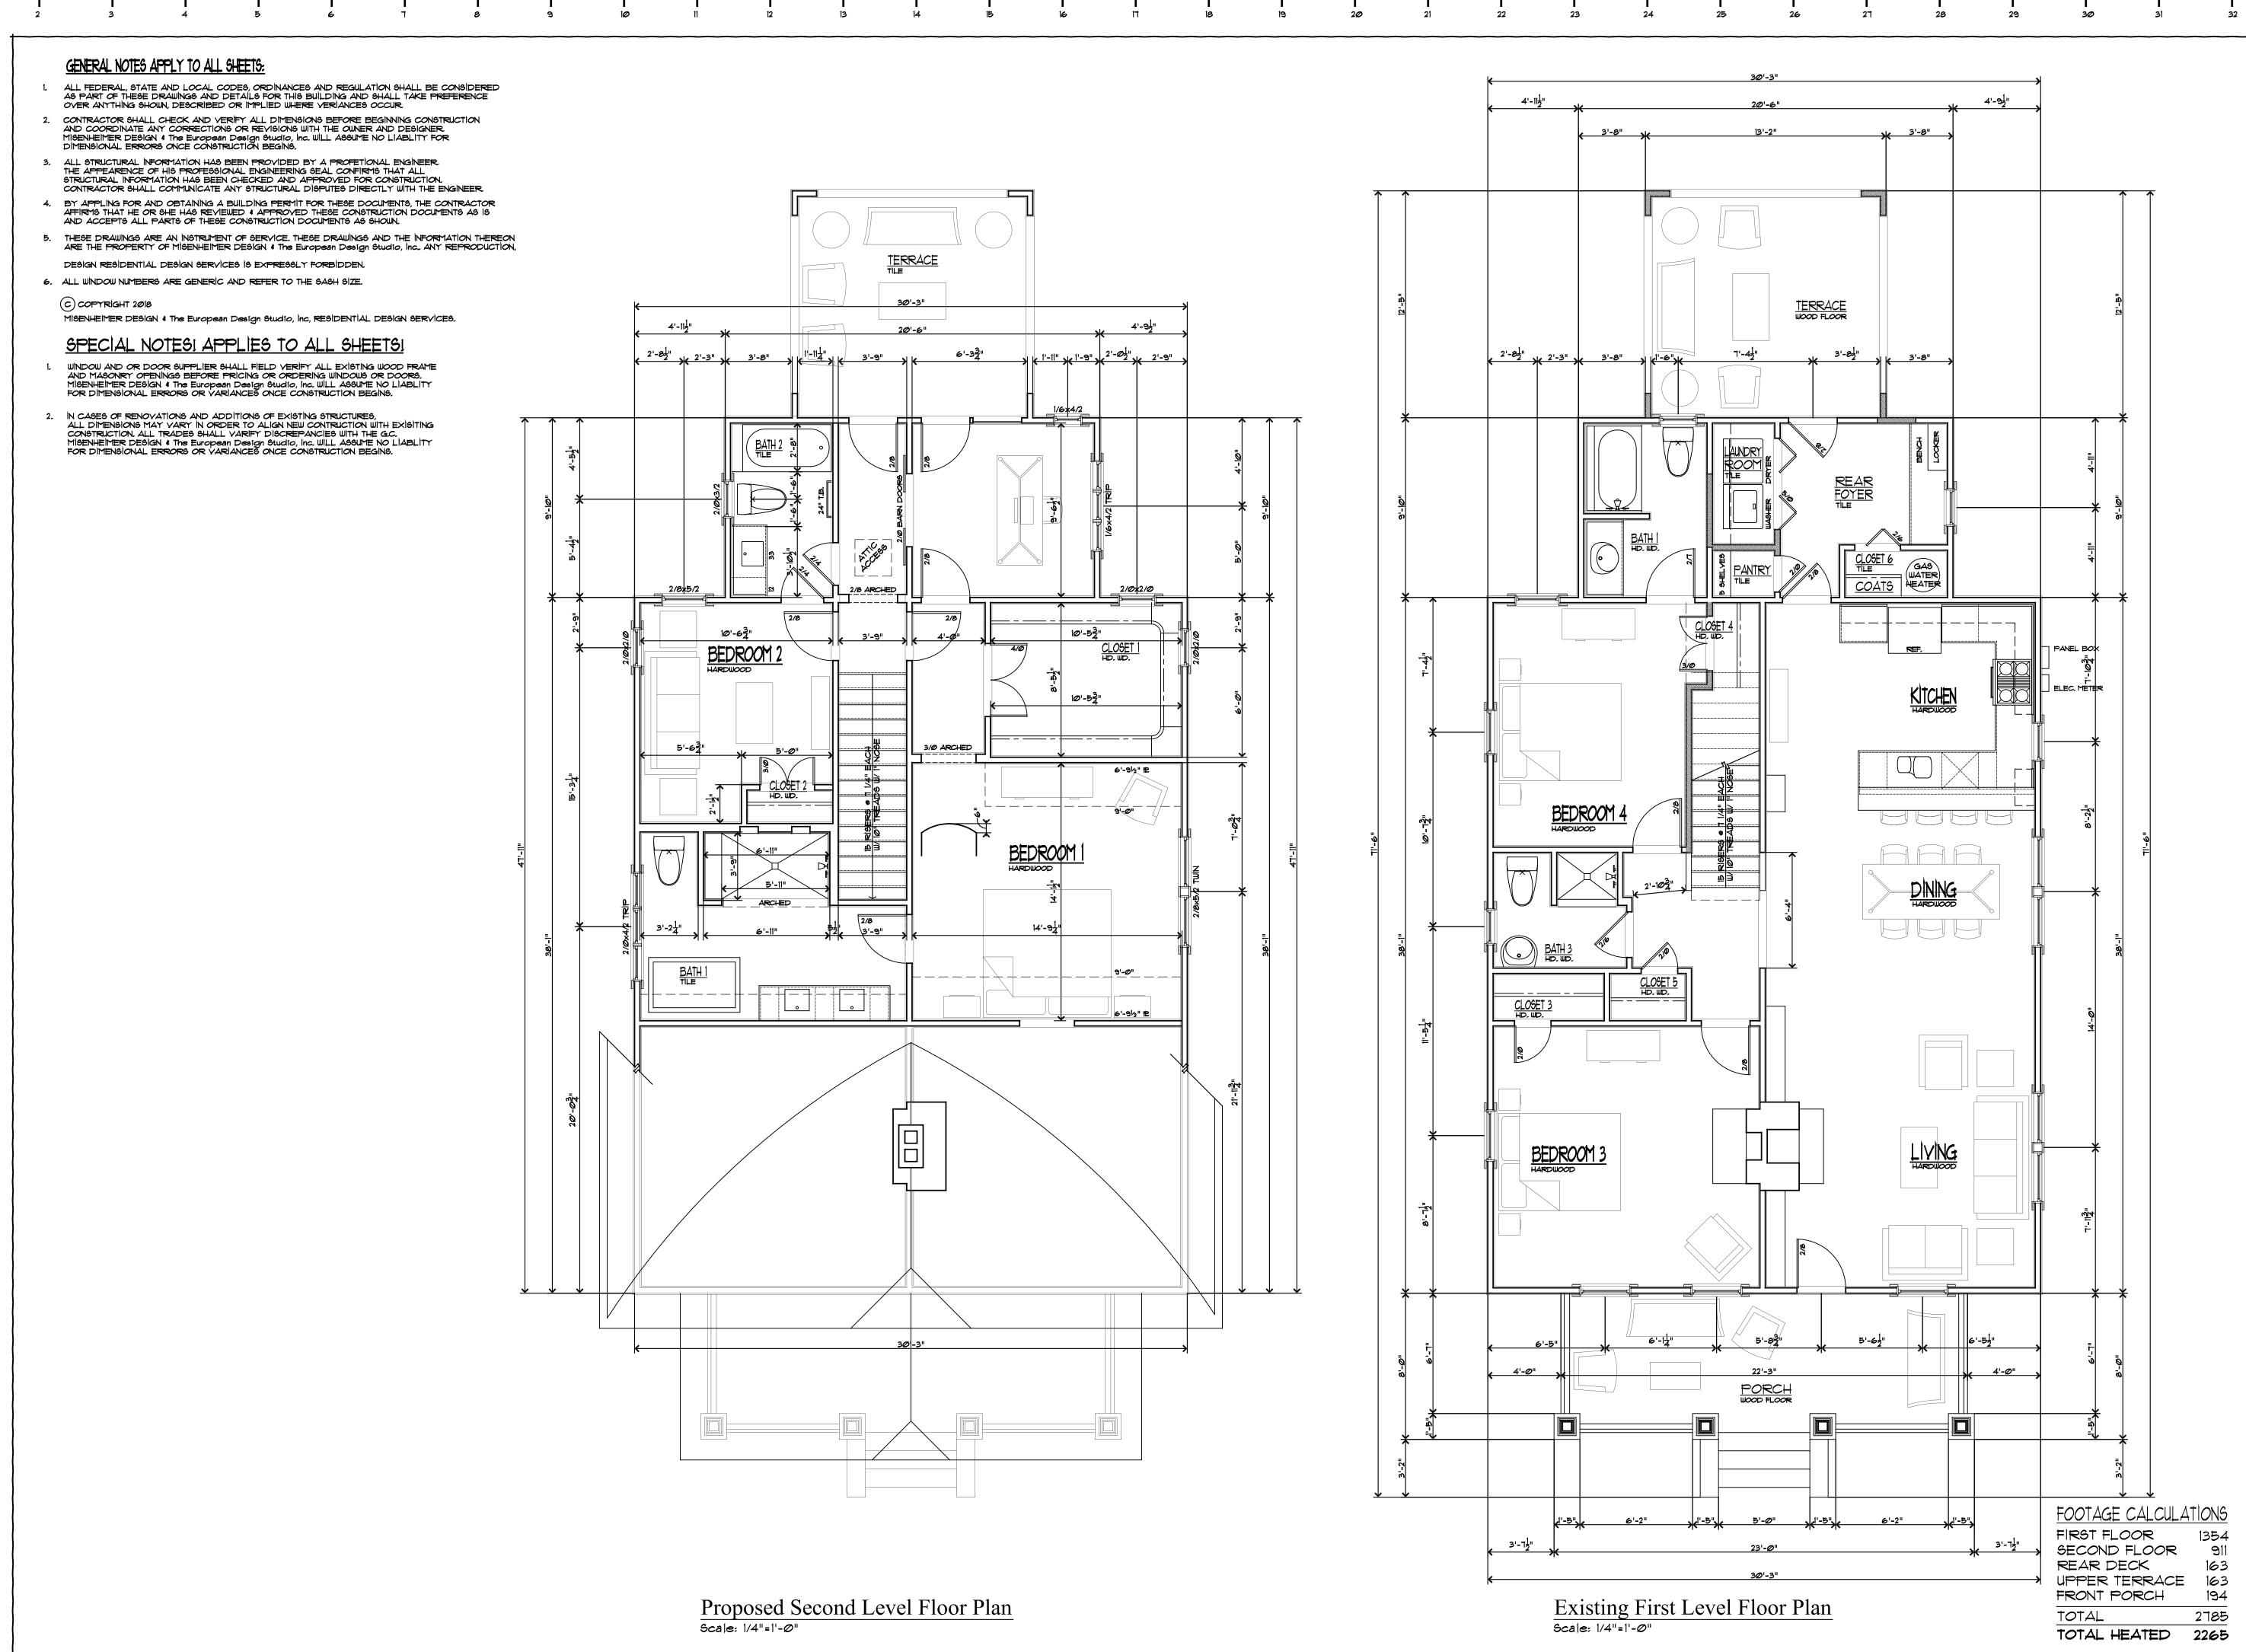
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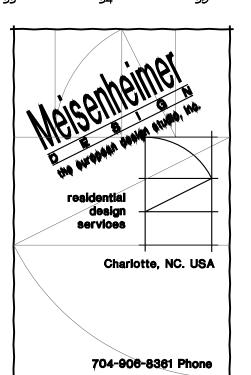
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EXISTING FIRST FLOOR PLAN AND ROOF PLAN

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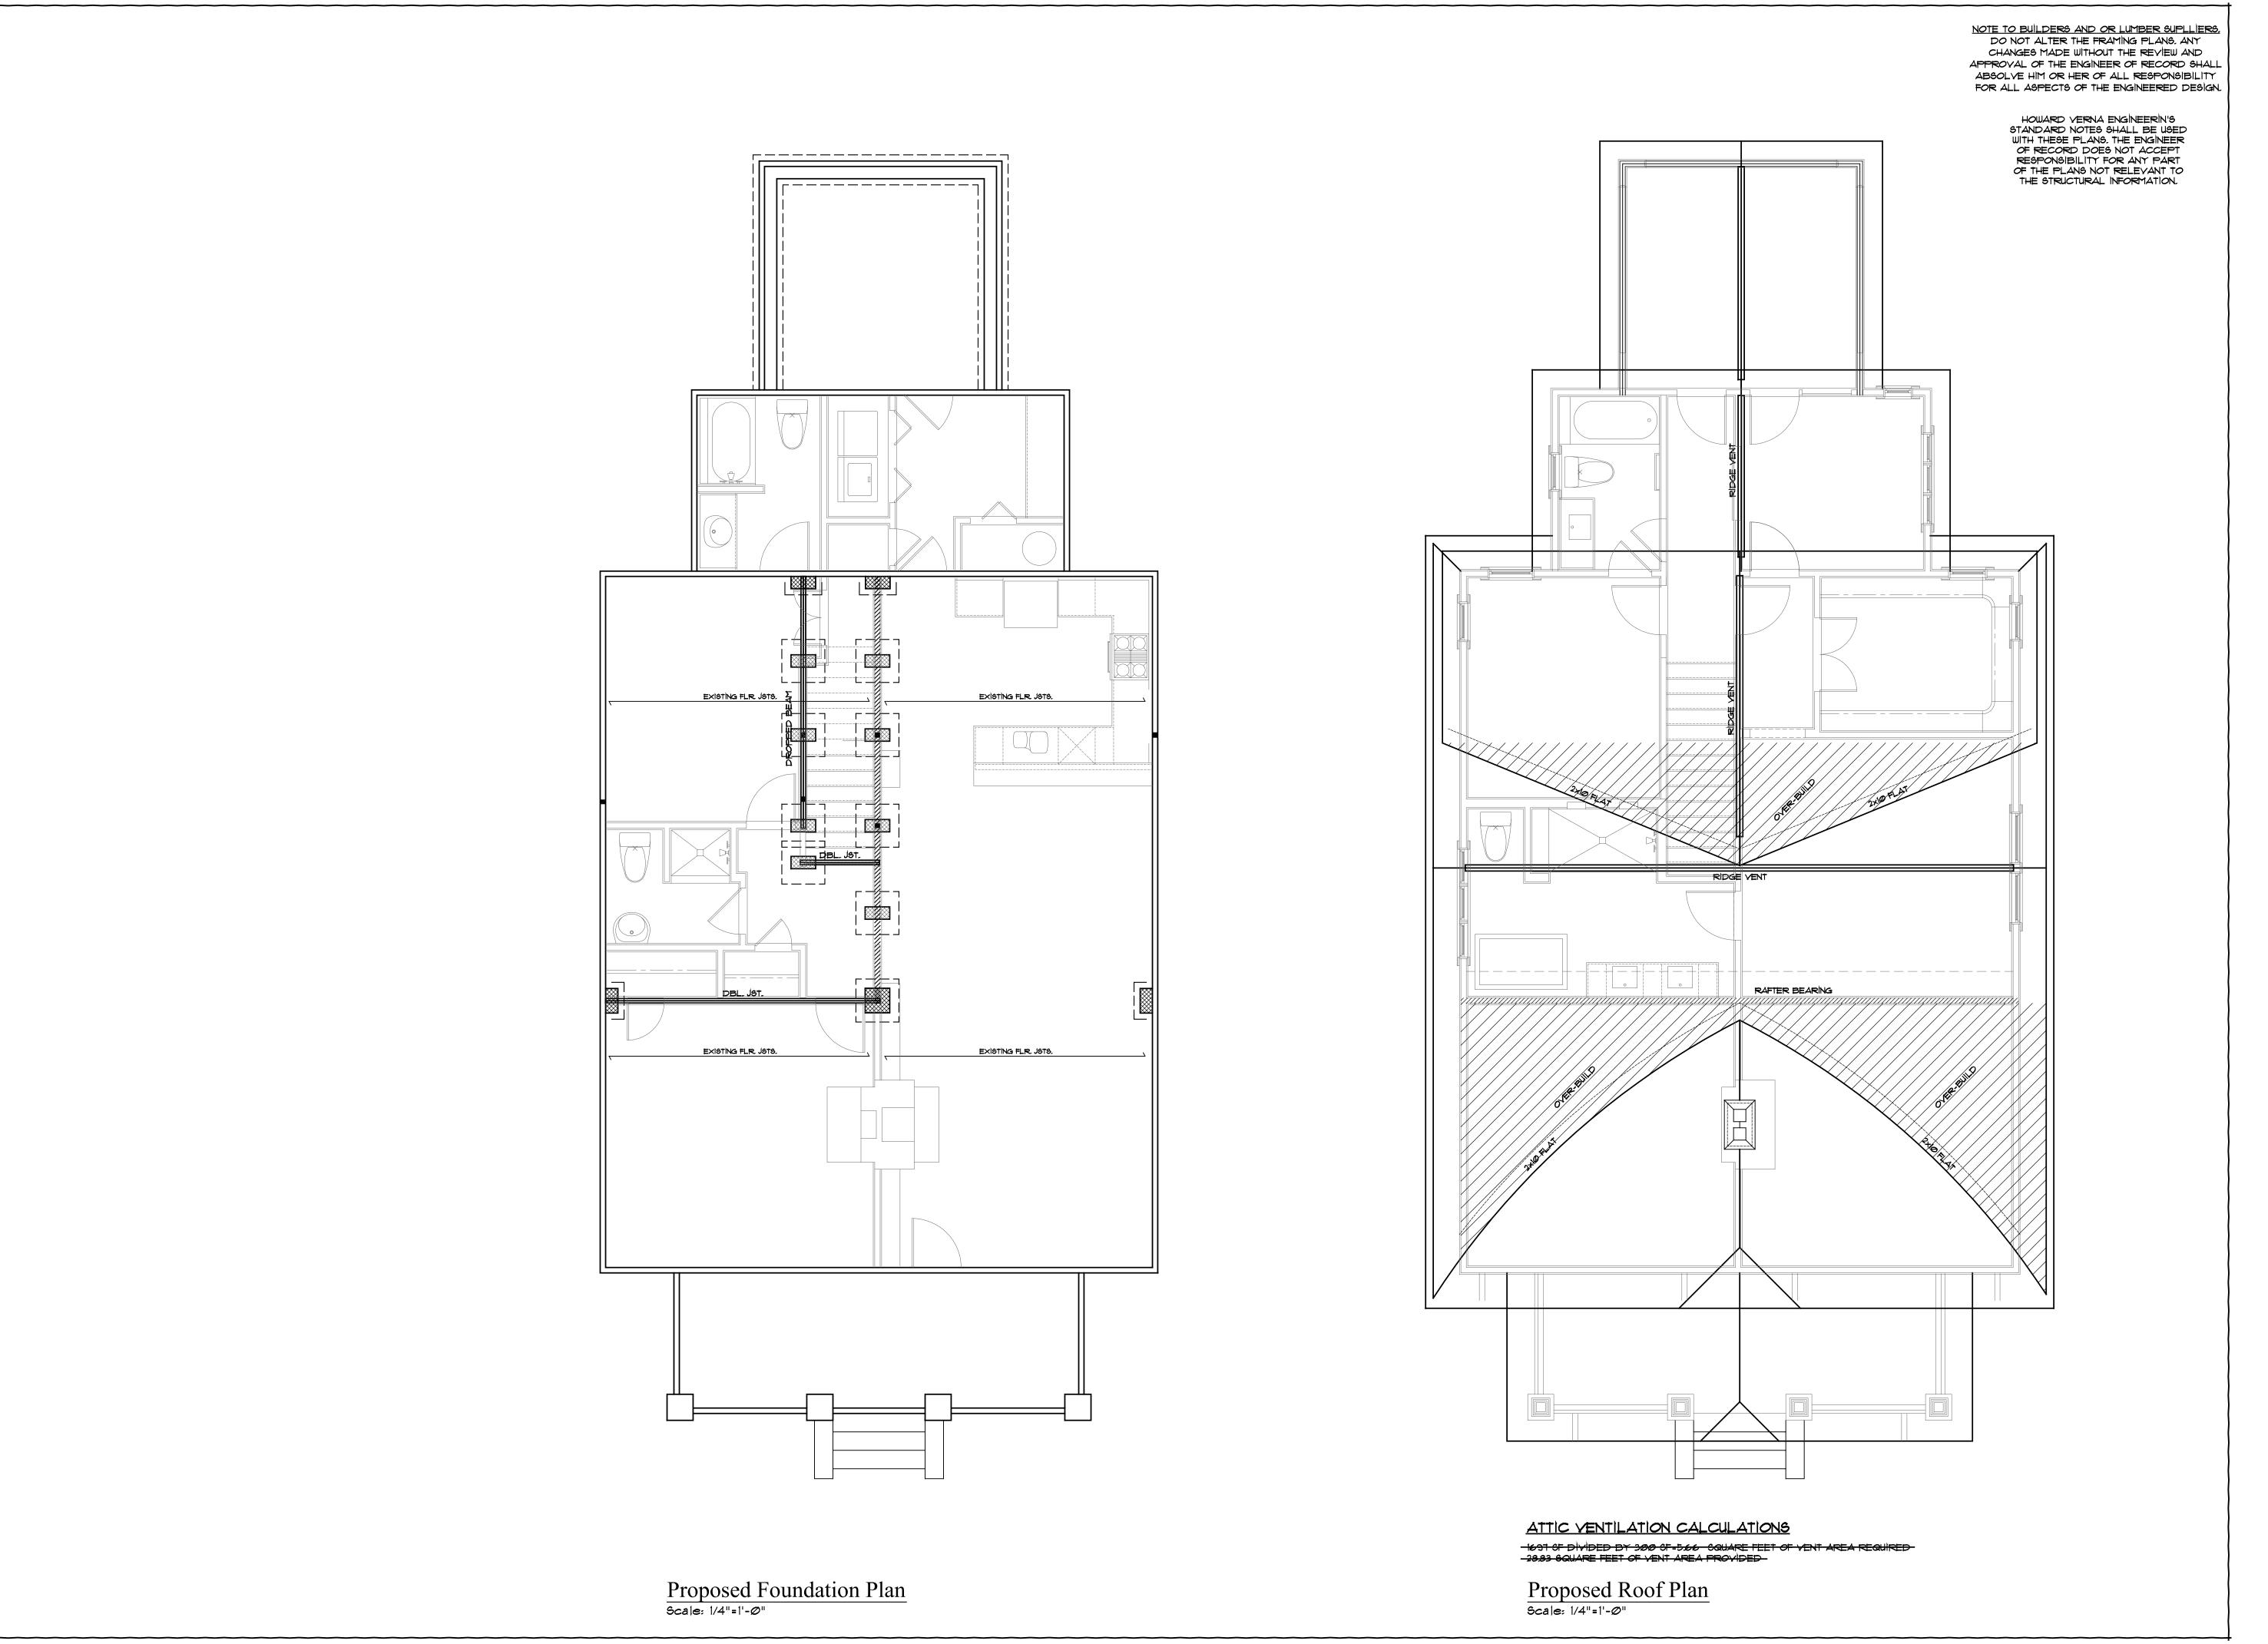
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PROPOSED FIRST FLOOR AND SECOND FLOOR PLANS

A3.0

*PORCH SQ. FT. INCLUDES STEPS

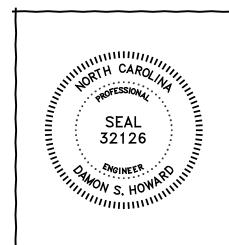


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> PROPOSED FOUNDATION & ROOF PLAN

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