Charlotte Historic District Commission

Staff Review HDC 2017-114

Application for a Certificate of Appropriateness

Date: May 10, 2017 PID# 11907315

LOCAL HISTORIC DISTRICT: Wilmore

PROPERTY ADDRESS: 1824 South Mint Street

SUMMARY OF REQUEST: New Construction

APPLICANT: Liliana Jimenez

The application was continued for the following: 1) Improve massing along the West Kingston elevation with architectural details, 2) Identify types of trees to be removed and update the landscaping plan. Provide landscaping along West Kingston Avenue side of the house, 3) Revise driveway entrance to one car width, 4) Include the garage and house on side elevations.

Details of Proposed Request

Existing Conditions

The existing site is a vacant corner lot with parcel dimensions of approximately 36.6' x 160'. The previous structure was a two story commercial structure. Adjacent structures are two stories in height. The required setback is 30 feet from ROW.

Proposal

The proposal is the construction of a single family house and garage. Design features include a brick foundation, wood lap siding, wood shakes in the gables, wood windows, metal porch roof and wood trim details. Building height is approximately 24'-11". The garage is one story with materials to match the house. The garage is setback approximately 25' from the rear property line. Two mature trees will be removed and new trees planted.

Revised Proposal – May 10, 2017

- 1. The left side elevation includes a new window pattern and second floor balcony
- 2. Trees to be removed and planted are identified on the site plan
- 3. The driveway width along the street is one car wide
- 4. The garage and house are shown on the side elevations

Policy & Design Guidelines for New Construction, page 34

New construction in Local Historic Districts has an obligation to blend in with the historic character and scale of the Local Historic District in which it is located. Designs for infill projects and other new construction within designated Local Historic Districts must be designed with the surroundings in mind. The Historic District Commission will not specify a particular architectural style or design for new construction projects. The scale, mass and size of a building are often far more important than the decorative details applied. However, well designed stylistic and decorative elements, as well as building materials and landscaping, can give new construction projects the attributes necessary to blend in with the district, while creating a distinctive character for the building. New construction projects in Local Historic Districts must be appropriate to their surroundings.

The Historic District Commission will review the building details for all new construction as part of their evaluation of new construction project proposals.

All New Construction Projects Will Be Evaluated For Compatibility By The Following Criteria			
1. Size	the relationship of the project to its site		
2. Scale	the relationship of the building to those around it		
3. Massing	the relationship of the building's various parts to each other		
4. Fenestration	the placement, style and materials of windows and doors		
5. Rhythm	the relationship of fenestration, recesses and projections		
6. Setback	in relation to setback of immediate surroundings		
7. Materials	proper historic materials or approved substitutes		
8. Context	the overall relationship of the project to its surroundings		
9. Landscaping	as a tool to soften and blend the project with the district		

Staff Analysis - The Commission will determine if the proposal meets the guidelines for new construction.

Charlotte Historic District Commission Case 2017-114 HISTORIC DISTRICT: Wilmore **NEW CONSTRUCTION** Kingston Av B_{V} Sminis W Worthington Av Mood Dale II WICKEROLDE Woodcrest Av Wilmore Dr 1824 S. Mint Street Wilmore **Historic District Property Lines** 280 140 420 **Building Footprints** April 5, 2017 ■ Feet

This application was continued from April for the following:

- Improve massing along the W. Kingston elevation with architectural details
- Identify types of trees to be removed and update the landscaping plan. Provide landscaping along W. Kingston Avenue side of house
- Revise driveway entrance to one car width
- Include the garage and house on side elevations.

ABBREVIATIONS Schedule SECT DET High Strength Section **Anchor Bolt** NEG A/C Drinking Fountain Hand Sink Select Air Conditioning DF Negative ABV Noise Frequency Separate Diagonal SER DIM Dimension Not In Contract Serial Acoustical Ceiling Tile ACT Smooth Faced ADH Heating, Ventilation & NOM Dead Load Adhesive Nominal Square Feet ADJ Nickel Plated SGL DN Air Conditioning Adiacent Single AFF SIM Above Finish Floor DOZ AGGR SK Dampproofing Coefficient Sink Aggregate HYDR SM Near Side Small Aluminum Hydrant ALLOW SOG Slab on Grade Allowance Double Strengt SOL Inside Diamete Alternate OCT SP ALUM Aluminum Downspout Isolation Joint On Center Soil Pipe OD APPX Duplicate Stand Pipe DUP Illuminate Octagonal Approximate APT OFF Outside Diameter SPEC Specification Impregnate Appendix ARCH INC OPNG SPKR Apartment Speaker INCL OPP ASPH SPRK Architect(ural) EΑ Each Sprinkler OPT Each Face INDL Industrial SQ Opposite Square Asphalt Association Exterior Insulation Infinite ORIG Optional Single Strength OUT AUTO and Finish System INFO Information Soil Stack OV SST AVE Impact Noise Rating Outlet, Outside Stainless Steel **Automobile** Expansion Joint INST AVG Institute Steam Elevation Avenue Average **ELEC** Electric INSTL Installed B/ (B.O. **ELEV** Elevation INSUL Insulation PART STAG Staggered INT STATN **ELEV** Elevator Bottom of Interior Stationary PCT BD Bottom Chord EMB Embedmen International Pieces STD Standard PED BDY ENAM Iron Pipe Size STL Board PERF STN Boundary **ENGR** Pedestal Stone STOR BLDG PERM **ENTR** Entrance Perforated Storage Building Line BLW PERP STR EQ Equal Junction Box Permanent Straight Building BMBelow **EQUIP** Equipment Junction Perpendicular STR Strength BOT Beam Estimated Junior STRM Storeroom Each Way Plate STRUCT **Bottom** Joint Structural SUB Bedroom EXC Excavate Property Line BSMT Kips (Kilopounds) SURF Exhaust Plastic Laminate Surface BTWN SUSP PLUMB Basement Exposed KD Kiln Dried Suspended SW Knock Down PLN Plumbing Single Weight Between SWM Storm Water Managemen Plane CABPMP SYM Center to Center Symmetrical CAP PNL SYS Flat Bar LAB Laboratory Cabinet FB CAT Floor Drain Panel Capacity СВ Foundation LAQ PORT Catalog FDN T&G POS CF LAV Circuit Breaker Finish Floor Elevation Lavatory Portable Tongue & Groove FIG PR Positive Cubic Feet Low Frequency Top Chord CIP PREFAB Cast Iron FIN Large Pair Trench Drain CIR LGTH Cast Iron Pipe FIX PRELIM TECH CIRC PREP Flashing Left Hand Circle Telephone CJ PRGM TEMP Temperature, Temporary Circular Licensed **FLDG** PRL Control Joint Linear Program Thickness PROP THRES LINO Linoleum CLG LIQ THRU FLG Flooring Property Centerline Liquid Through CLKG LLH PΤ TOL **FLUOR** Fluorescent Long Leg Horizonta Tolerance PTD TOS CLOS Face of LLV Top Of Stee Caulking Long Leg Vertical CLR PVC TOT LNTL Freezing Point Painted Total CMPTR Polyvinyl Chloride TRANS Fiber Reinforced Plastics Transparent Clear TRANSV Fireproof Transverse Computer Fire Retardant Treated Concrete Masonry Unit CND QT Concealed Far Side Level Typical CO QTR Footing Light Weight Concrete FTG Conduit Quarry Tile CO CO QTY Change Order **FURN Furnished** Quarter QUAL UNGD Underground COM UNO **Unless Noted Otherwise** Company Manual Quality COMBManufacturer UNTRD Untreated Common COMP UPR Combination GALV Galvanized Radius Upper COMP GAR Composition MATL Right of Way Ultra Violet **GFRC** MAX**RCPT** CONC Glass Fiber Compressive Maximum CONSTR Reinforced Concrete Member Concrete Receptacle Voltage CONT Construction Mechanical Variable/Varies RECT CONTR VENT Continue, Continuous Reinforced Gypsum Ventilation Galvanized Iron MEMBR Membrane Contractor Rectangular GOVT MEMO Memorandum Refrigerator VIB Vibrate Government Copper CORR Corporation GWB Gypsum Wall Board MFG Manufacturing Reinforcement Volume MGR CPM **GWT** Glazed Wall Tile Corrugated Relative Versus CR Critical Path Method REPL GYP Minimum Gypsum Remove CSK Cold Rolled Miscellaneous Replace Countersunk Molding REQD Reproduce With CTD MN REV W/C Ceramic Tile HD Hard Main Required Watercloset/Watercooler CTR Coated HD Head RFG WD Wood Masonry Opening Revision CU Modification Roofing Center **HDWR** Hardware Width CV Cubic Hexagonal Melting Point Rough WDW Window CW MRK HGT Height Right Hand Check Valve Mark Waterheater Hollow Metal MSW Master Switch RO Wire Mesh Cold Water Room **HMDR** Hollow Metal Door Marble Threshold Rough Opening Without MTG RTN HNDRL Handrail Mounting Repair Waterproofing DAT MTL RVS Penny (Nails) HOL Hollow Metal Return Working Point HOR Horizontal Multiple Reverse Wiring Datum Dry Bulb Hospital Weight DCL High Performance North SAN South Welded Wire Fabric Double

INSULATION

SUBSURFACE

CONCRETE

Sanitary

RIGID INSULATION

BATT INSULATION

CONCRETE

CONCRETE MASONRY UNIT

LIGHTWEIGHT CONCRETE

Welded Wire Mesh

DEG

Door Closer

MATERIAL SYMBOLS

GYPSUM WALLBOARD

ACOUSTICAL TILE

STEEL: LARGE SCALE

METAL: SMALL SCALE

WOOD BLOCKING OR

SPLIT FACE/GROUND FACE CMU

PLYWOOD

#


Degree

FINISHES


METAL


RESIDENCE

1824 MINT ST. CHARLOTTE, NC

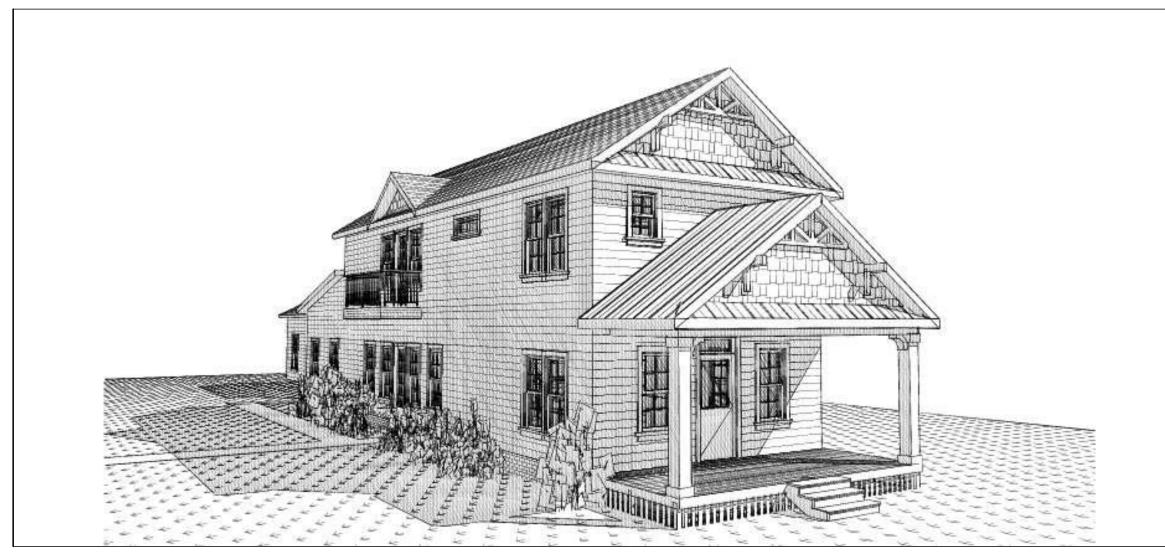

D1	RAWINGS					
			S	HEET INDEX		
ID	Name	XX/XX/XX				
A-001	COVER SHEET					
A-101	SITE PLAN					
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A-103	2ND FLOOR & ROOF PLAN					
A-104	GARAGE PLANS					
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A-301	INTERIOR ELEVATIONS					
A-401	DETAILS					
A-501	SPECIFICATIONS					

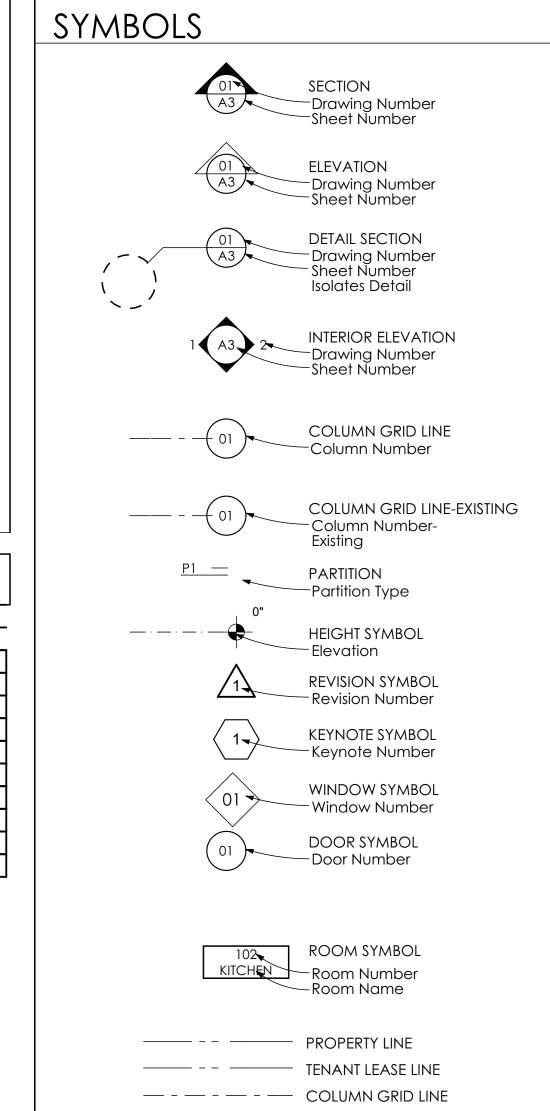

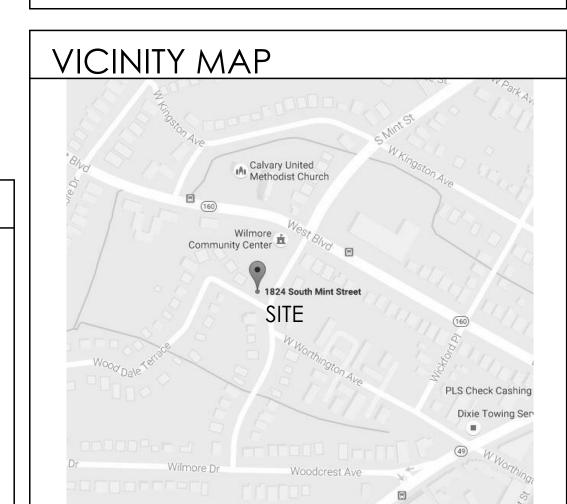



ALL WORK SHALL COMPLY WITH THE LIFE SAFETY CODE, ALL LOCAL AND STATE FIRE CODES AND CURRENT

GENERAL NOTES

- THE CONTRACTOR SHALL COMPLY WITH ANY EXISTING STATE AND APPLICABLE COUNTY OR CITY REGULATIONS AND LEGISLATION REGARDING THE CONTROL OF POLLUTION AS IT APPLIES TO THE WORK.
- CODES: ALL MATERIALS, CONSTRUCTION TECHNIQUES, AND PRACTICES IN ALL ARCHITECTURAL, STRUCTURAL, MECHANICAL, PLUMBING, FIRE PROTECTION, AND ELECTRICAL WORK SHALL CONFORM TO THE APPLICABLE
- CODES AND REGULATIONS OF THE STATE AND ITS LOCAL JURISDICTION AND ALL INDUSTRY STANDARDS. CLARIFICATION: IF THE CONTRACT DRAWINGS ARE FOUND TO BE UNCLEAR, AMBIGUOUS, OR CONTRADICTORY, THE CONTRACTOR MUST REQUEST CLARIFICATION FROM THE ARCHITECT BEFORE
- PROCEEDING WITH THAT PART OF THE PROJECT WORK... THE CONTRACTOR SHALL BE SOLELY RESPONSIBLE FOR ALL SAFETY PRECAUTIONS AND STANDARDS TO INSURE THE SAFETY OF ALL PERSONS ON THE SITE.
- THE CONTRACTOR IS TO VERIFY ALL DIMENSIONS AND EXISTING CONDITIONS AND REPORT ANY DISCREPANCIES IMMEDIATELY TO THE ARCHITECT.

BUILDING INFORMATION

CODES: North Carolina Residential Code 2012

FIRST FLOOR: 1169 SQ. FT. SECOND FLOOR: 898 SQ. FT. TOTAL HEATED: 2067 SQ. FT. GARAGE: 441 SQ. FT.

BUILDING USE: RESIDENTIAL

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SIDENCE

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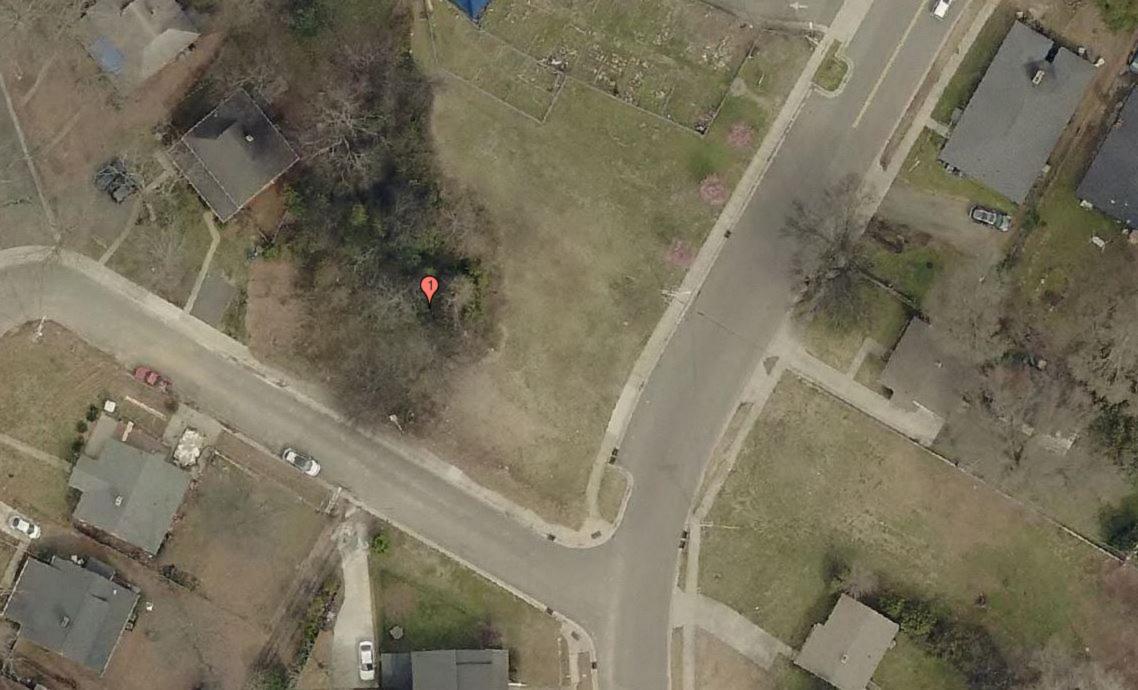
DRAWN BY: 4/26/2017 PROJECT NO:

16.580

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COVER SHEET SHEET NUMBER:

ISSUED FOR CONSTRUCTION




I hereby certify that this schematic drawing was prepared based on field—surveyed elevation measurements of the points shown hereon. This map is not intended to meet G.S. 47—30 recording requirements.

This 3rd day of April , 2017



Andrew G. Zoutewelle Professional Land Surveyor NC License No. L—3098

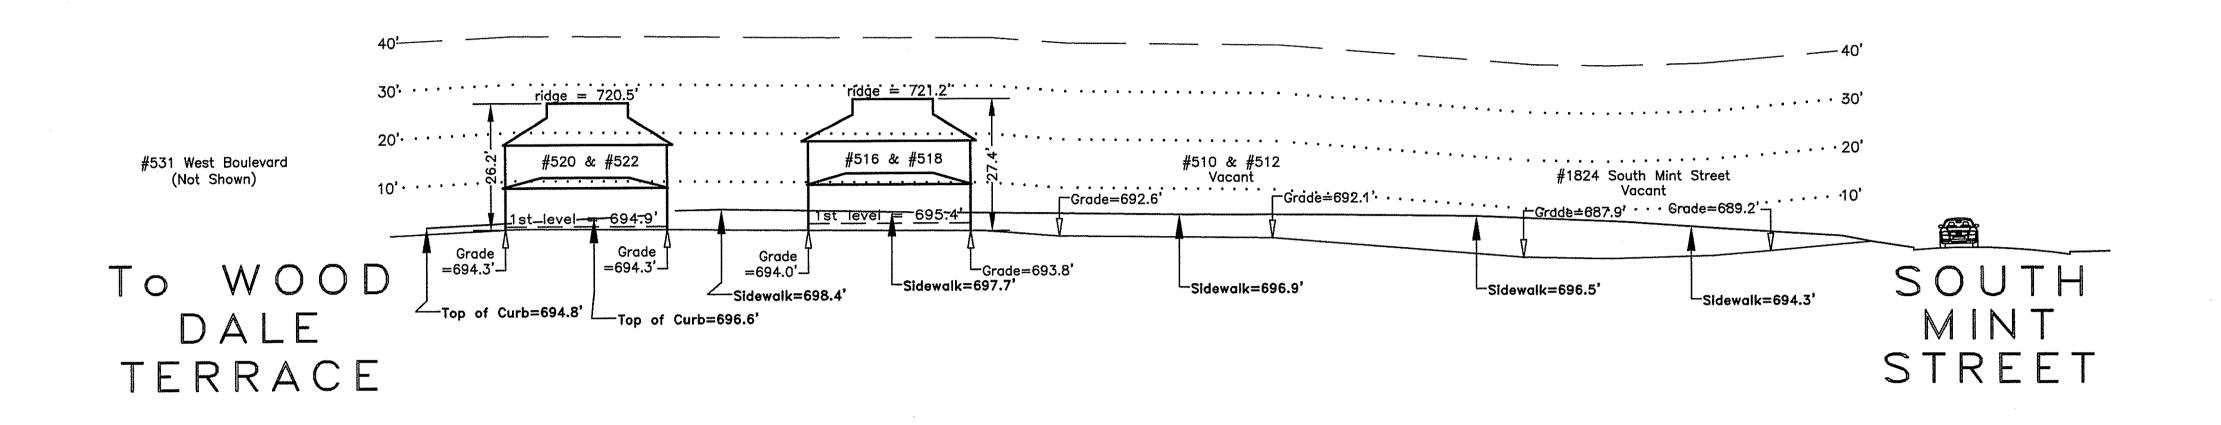

WEST WORTHINGTON AVENUE

A.G. ZOUTEWELLE SURVEYORS 1418 Fast Fifth St. Charlotte NC 38304

1418 East Fifth St. Charlotte, NC 28204
Phone: 704-372-9444 Fax: 704-372-9555
Firm Licensure Number C-1054


Building Heights Sketch of

500 BLOCK of WEST WORTHINGTON AVENUE

FACING NORTHEAST - EVEN SIDE

CHARLOTTE, MECKLENBURG COUNTY, N.C.


for Charlotte-Mecklenburg Planning Department March 28, 2017

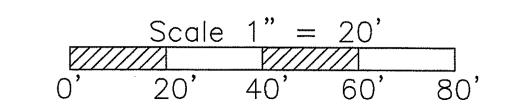

General Notes:


1. The purpose of this Building Heights Sketch is to show existing building facade heights relative to the elevation points at the public sidewalk or top of curb, front yard grade ("Grade"), 1st level, and ridgeline of the houses depicted hereon. No rearyard or sideyard measurements were made. The heights shown hereon were derived from indirect measurements and are not intended for structural

2. The vertical datum for these elevation measurements is the North American Vertical Datum of 1988 (i.e., sea level). All other information and graphics are conceptual in nature and are not intended to represent accurate architectural or landscape features.

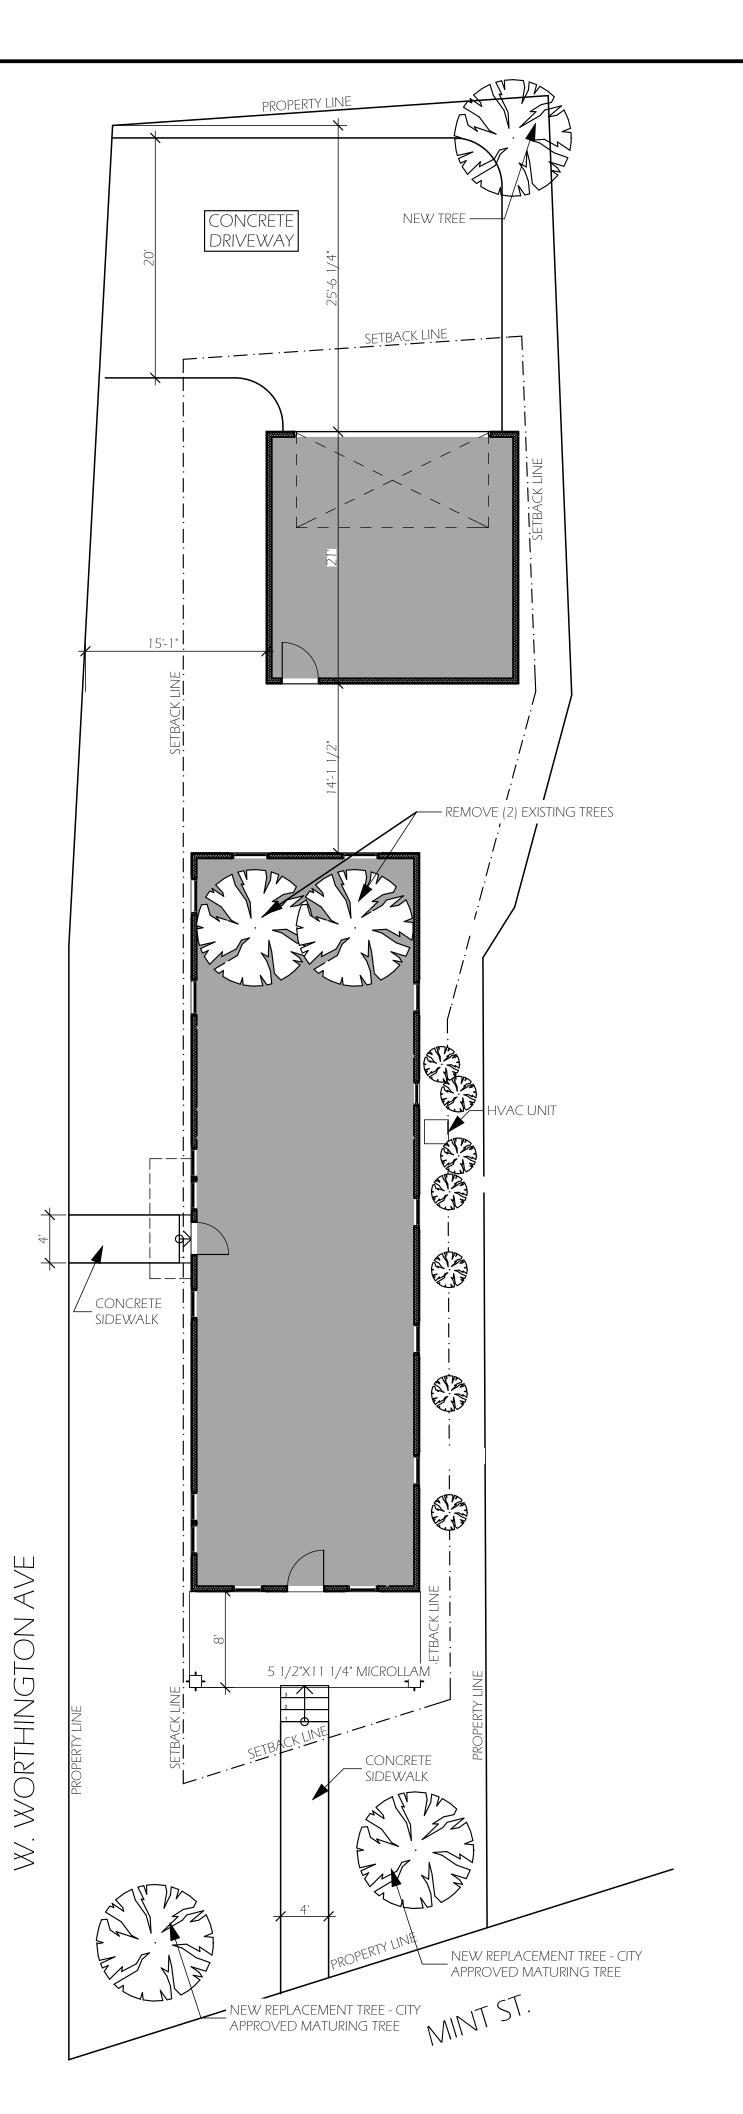



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SHEET TITLE:
SITE PLAN

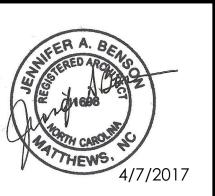
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SITE SCALE: 1/


SITE PLAN

SCALE: 1/8" = 1'-0"

ISSUED FOR CONSTRUCTION

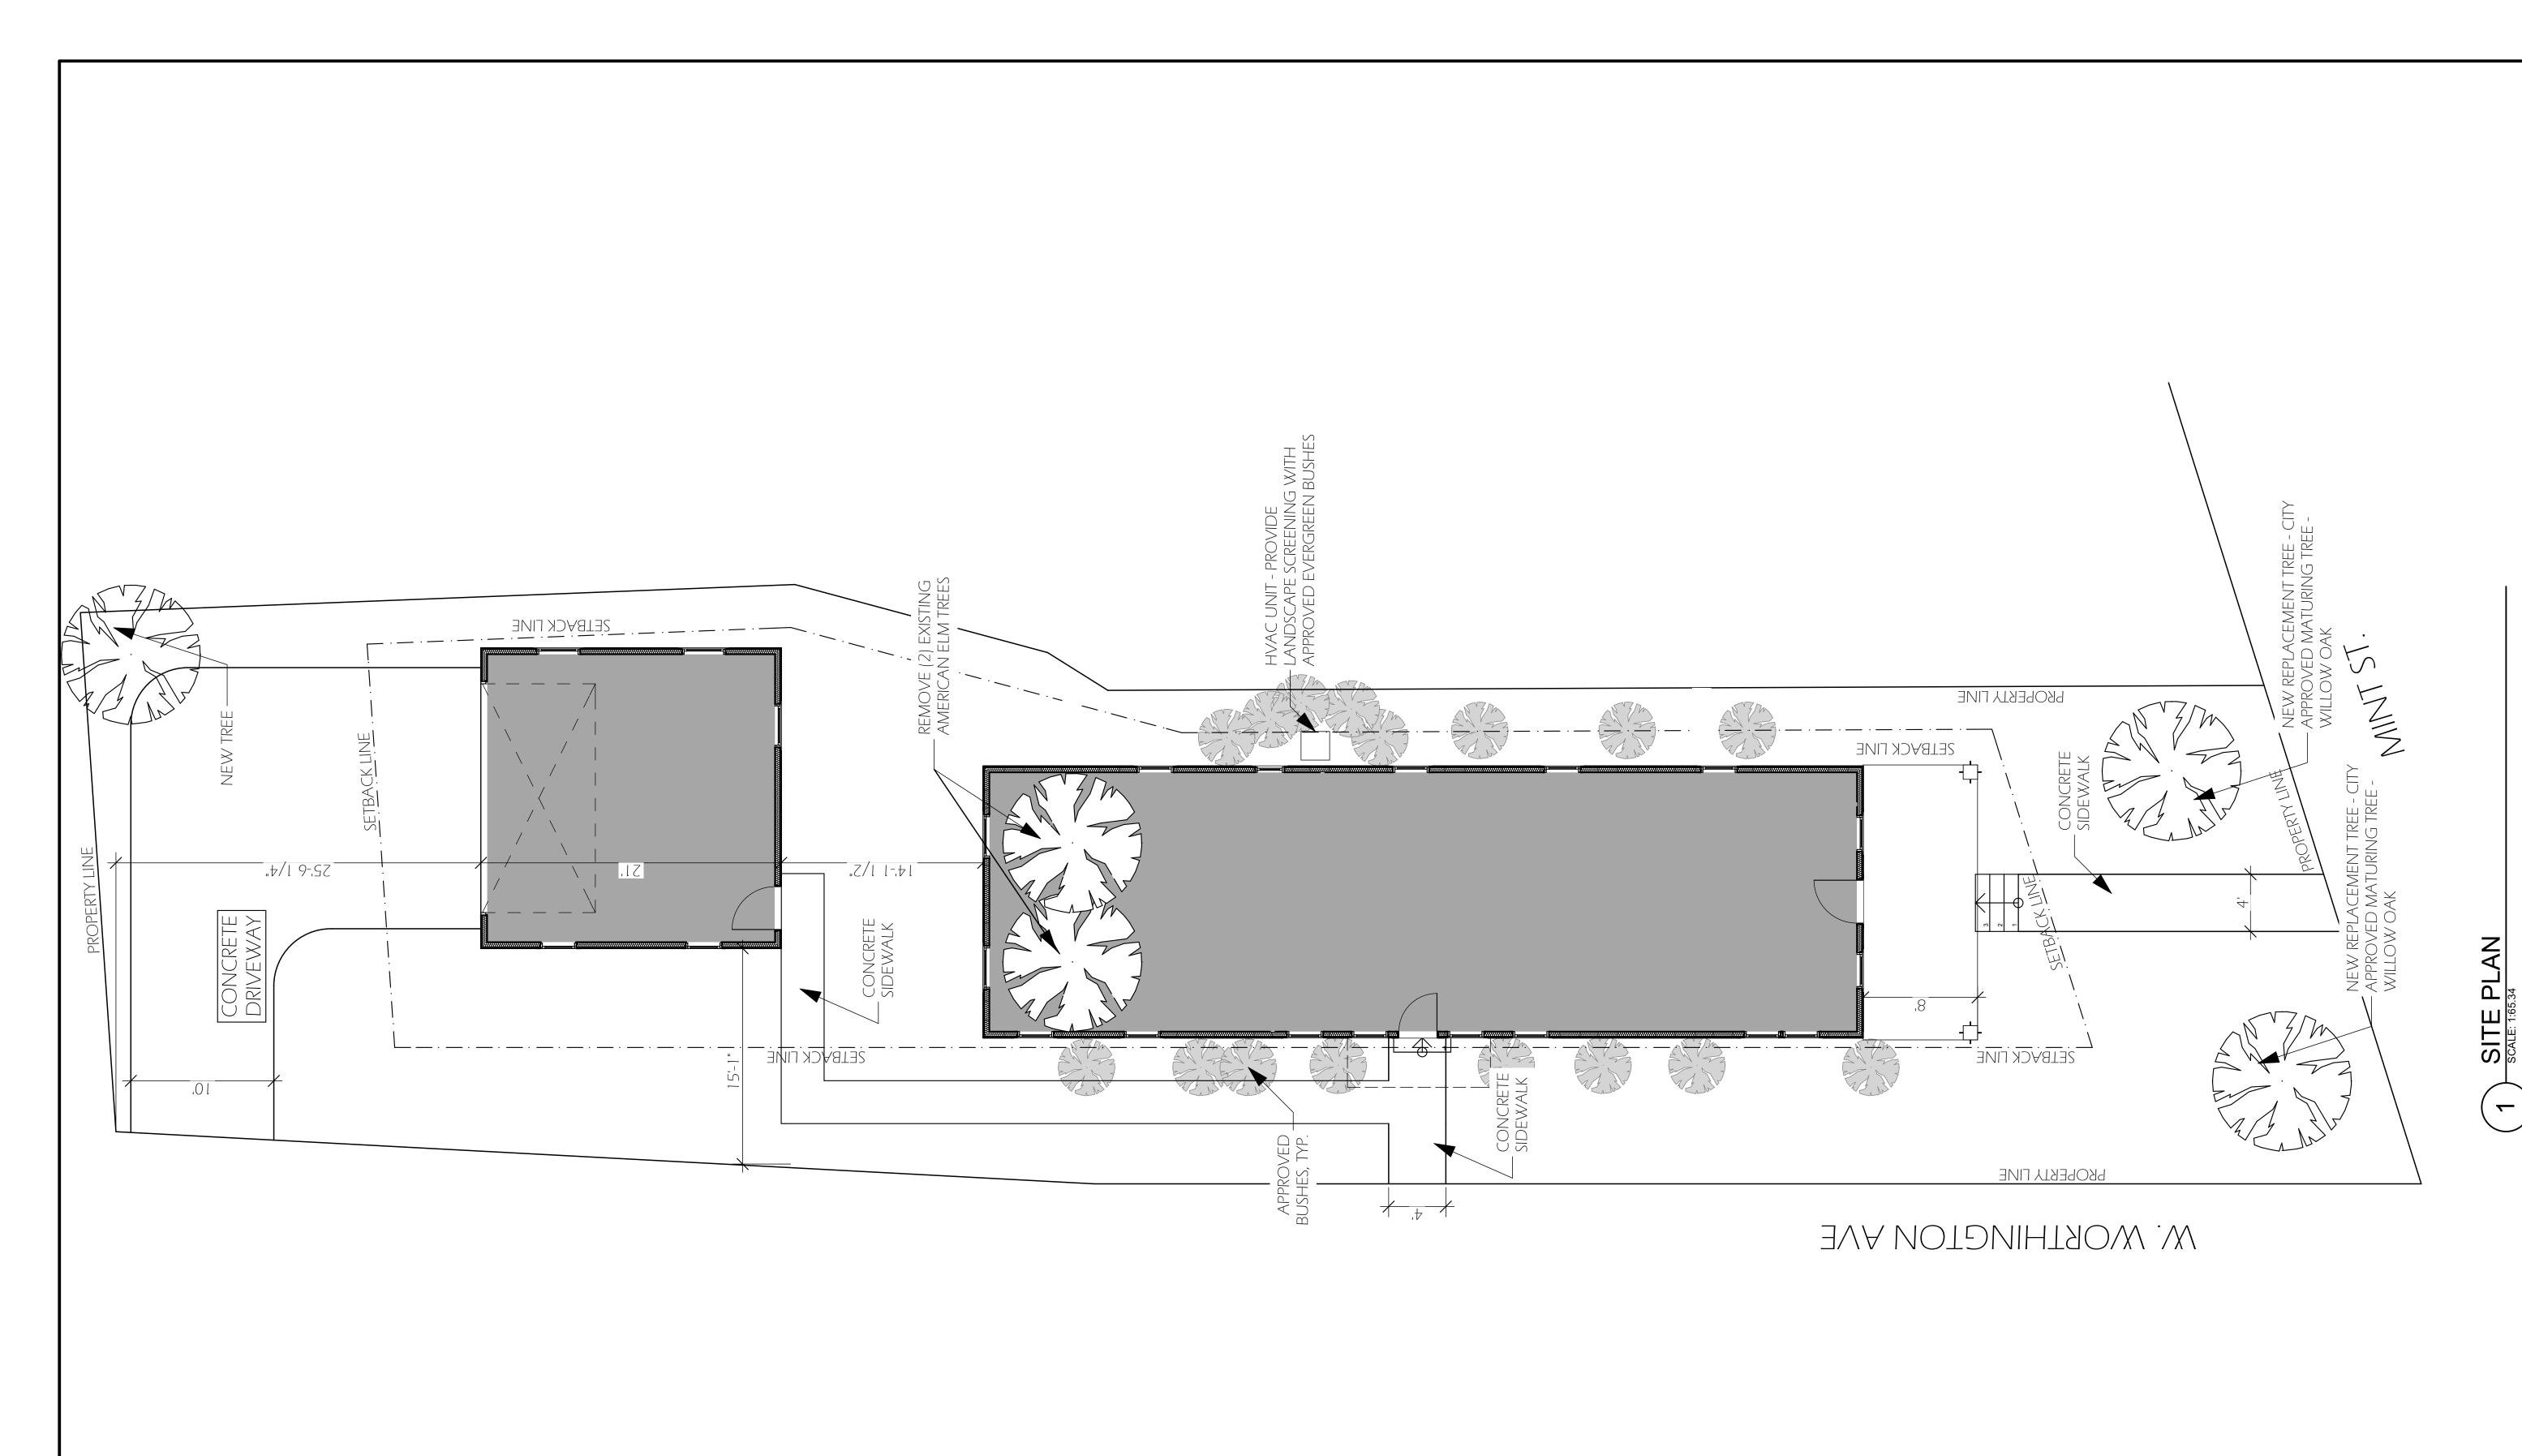

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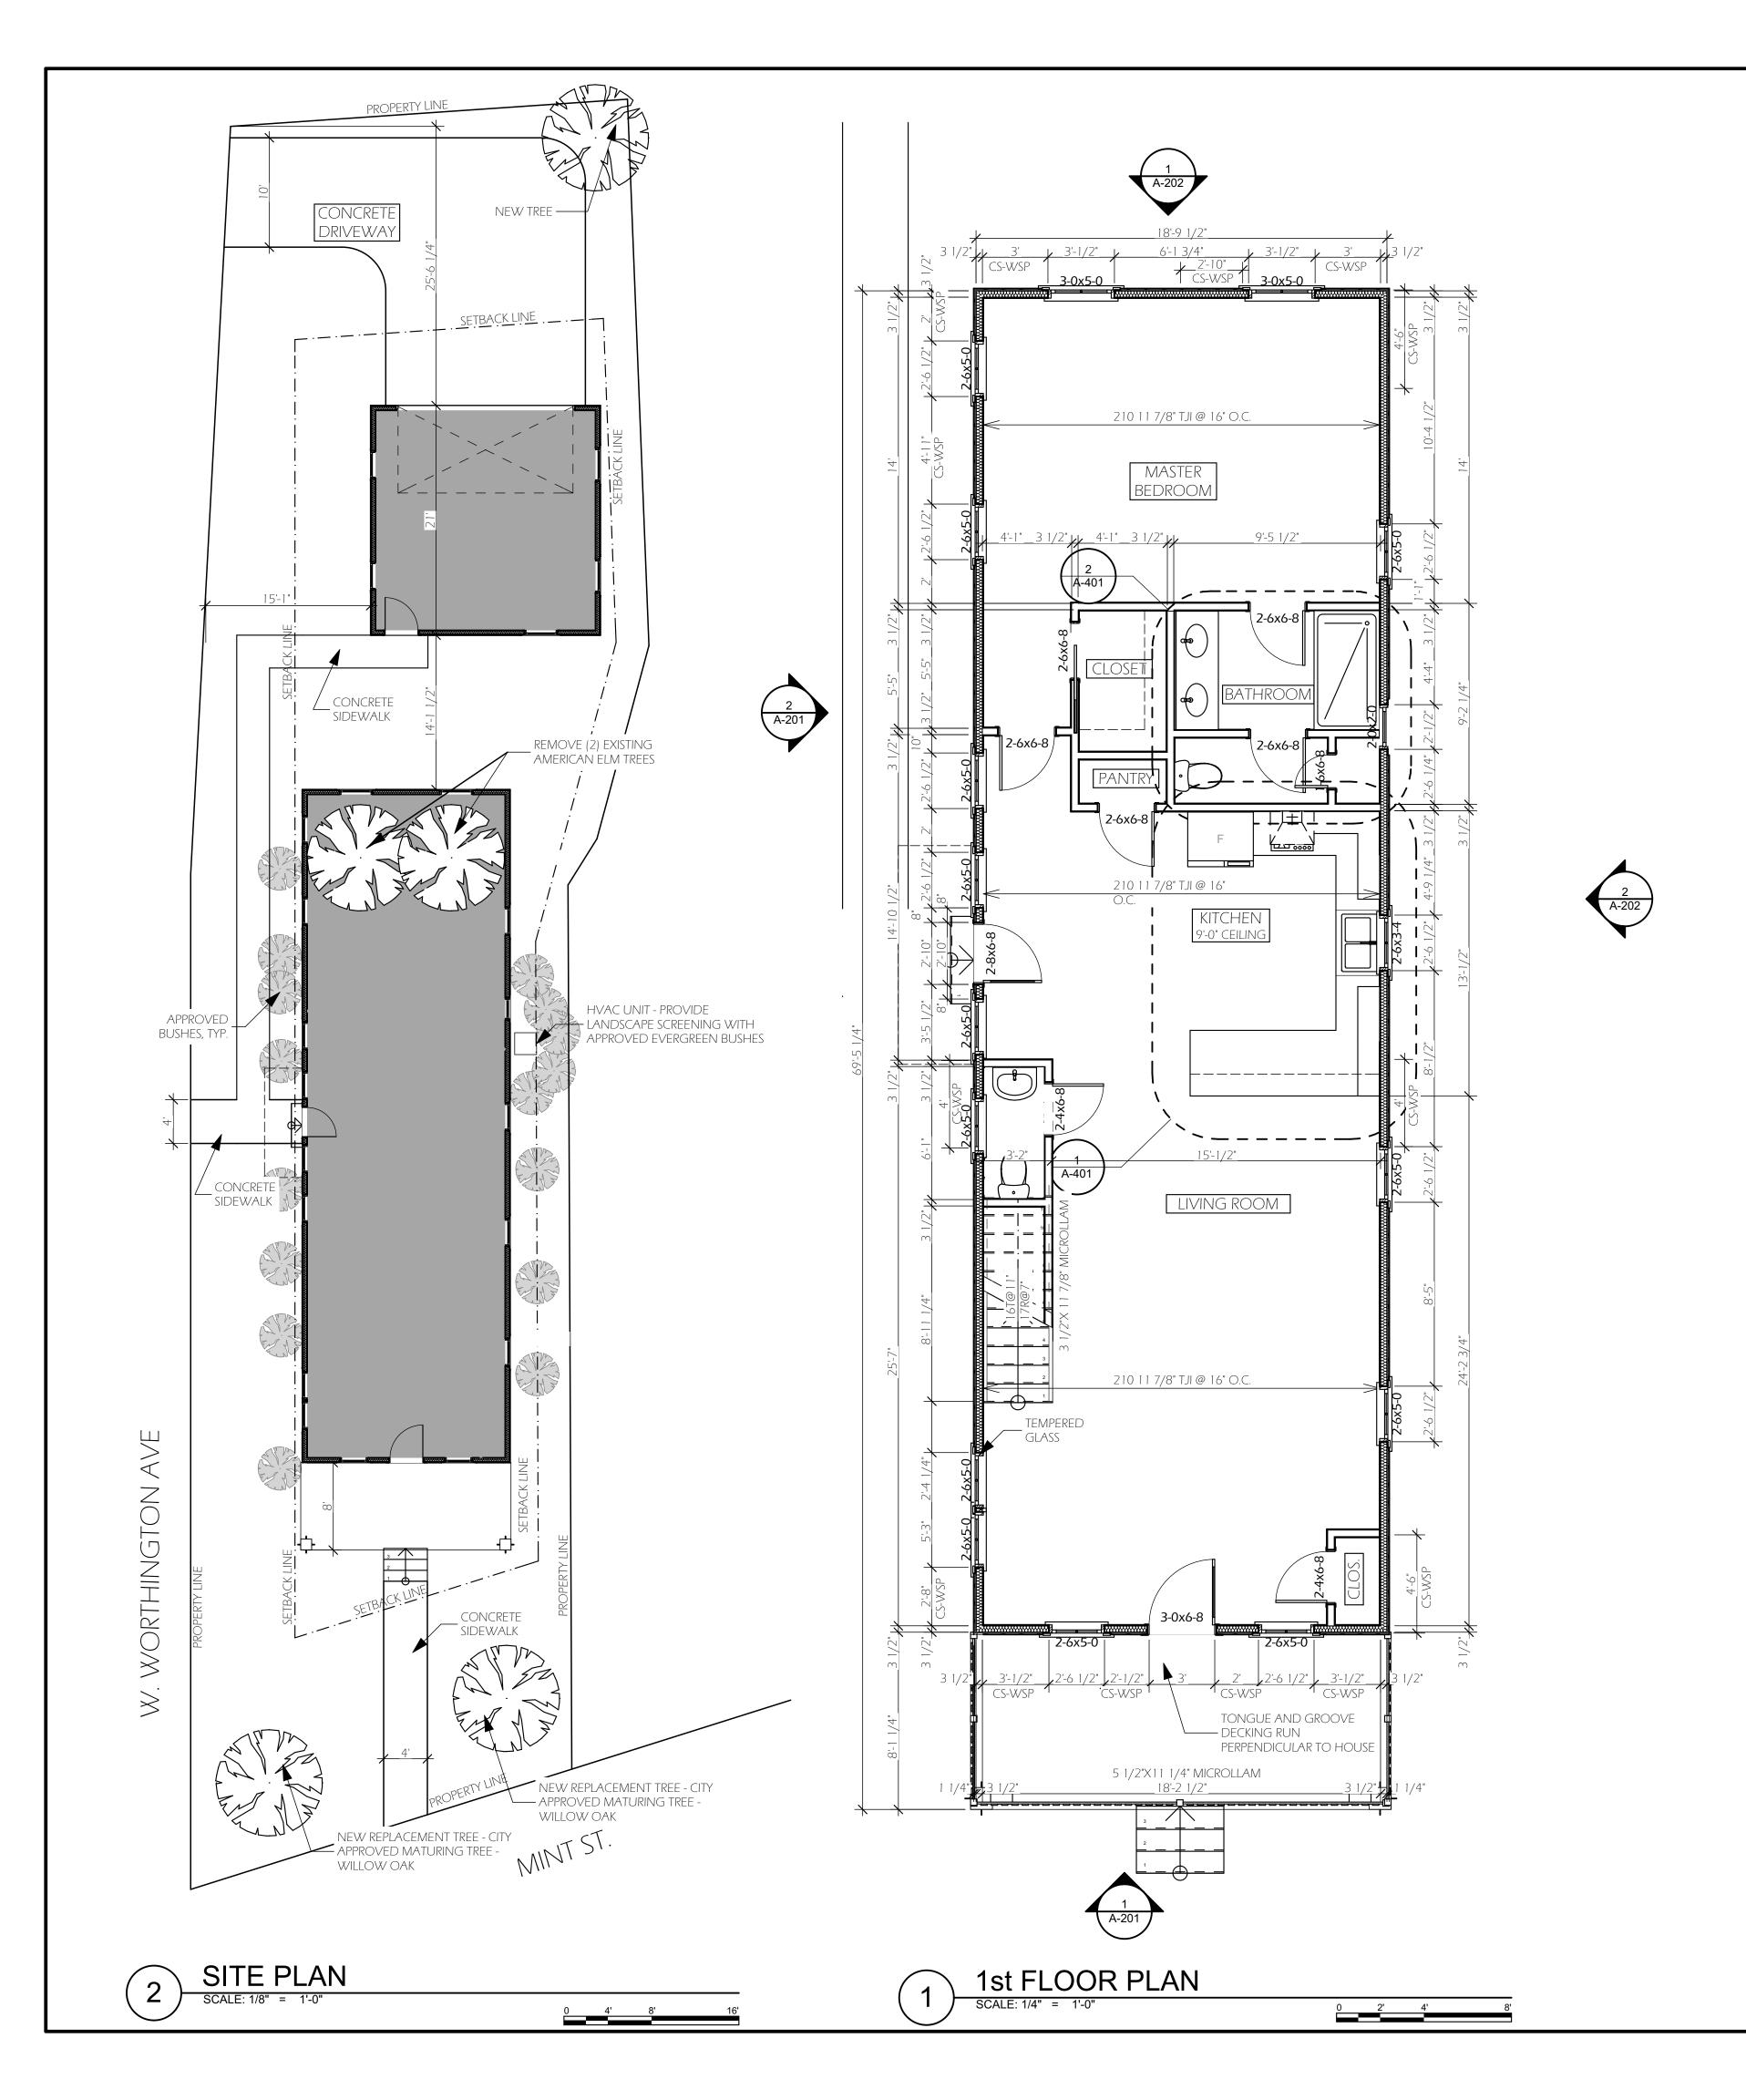
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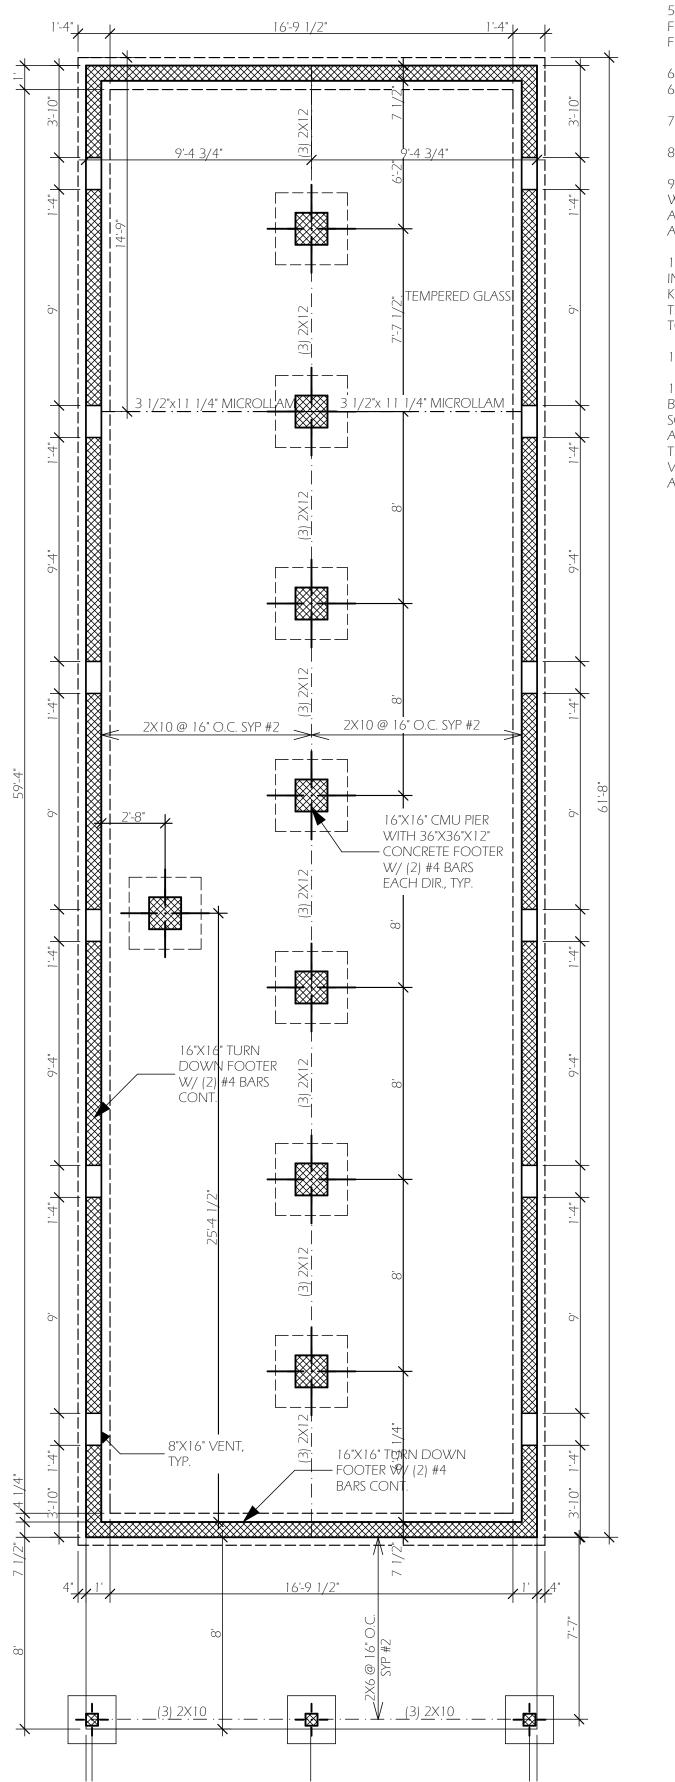
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SHEET TITLE:
SITE PLAN

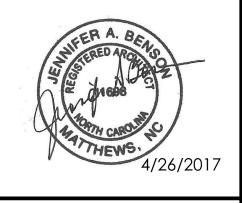SHEET NUMBER:





NOTES: 1. ALL DIMENSIONS ARE TO THE FACE OF STUD.

2. ALL INTERIOR WALLS TO BE 2X4 WOOD STUDS @ 16" O.C - S.Y.P. #2 W/ 1/2"

3.ALL EXTERIOR WALLS TO HAVE 7/16" CONTINUOUS OSB.

4. EXTERIOR WALLS TO BE 1/2" GWB, 2X4 WD STUDS @ 16" O.C. - SYP #2, R-15 BATT INSULATION, 7/16" OSB, TYVEK BUILDING WRAP OR SIM.AND EXTERIOR FINISH AS NOTED ON ELEVATIONS.

5. PROVIDE WOOD STRUCTURAL PANELS (CS-WSP) WHERE NOTED ON PLANS FOR WALL BRACING. PROVIDE 6d NAILS 6" FROM EDGED AND 12" O.C. IN FIFLD

6. PROVIDE (2) 2X8 HEADERS FOR ALL WINDOW AND DOOR OPENINGS TO 4'-6" AND (2) 2X10 HEADERS TO OPENINGS TO 6'-0"

7. PROVIDE (2) JACK STUDS EA. SIDE AT ALL WINDOW AND DOOR LOCATIONS.

8. PROVIDE DOUBLE JOISTS AT ALL WALL LOCATIONS ABOVE.

9. PROVIDE TEMPERED GLAZING IN THE WINDOW WITHIN 36" OF THE WALKING SURFACE OF A STAIR LESS THAN 60" ABOVE THE PLANE OF THE ADJACENT WALKING AREA. AND LESS THAN 60" FROM THE TUB OR SHOWER AND LESS THAN 60" ABOVE THE FLOOR.


10. JACK AND KING STUDS. THE NUMBER OF JACK AND KING STUDS INSTALLED ON EACH SIDE OF A HEADER SHAL COMPLY WITH TABLE R603.7(1). KING, JACK AND CRIPPLE STUDS SHALL BE THE SAME DIMENSION AND THICKNESS AS THE ADJACENT WALL STUDS. HEADERS SHALL BE CONNECTED TO KING STUDS IN ACCORDANCE WITH TABLE R603.7(2)


11. PROVIDE GRADE #1 FOR SYP GIRDERS AND HEADERS, TYP.

12. R703.11.3 WHERE THE PROPERTY LINE IS LESS THAN 10' FROM THE BUILDING FACE AND THE SOFFIT MATERIAL IS VINYL OR ALUMINUM, THE SOFFIT MATERIAL SHALL BE SECURELY ATTACHED TO THE FRAMING MEMBERS AND SHALL USE UNDERLAYMENT MATERIAL OR EITHER FIRE RETARDANT TREATED WOOD; 23/32" WOOD SHEATHING, OR 5/8" GYPSUM BOARD. VENTING REQUIREMENTS SHALL APPLY TO BOTH SOFFIT AND UNDERLAYMENT AND SHALL BE PER SECTION R806

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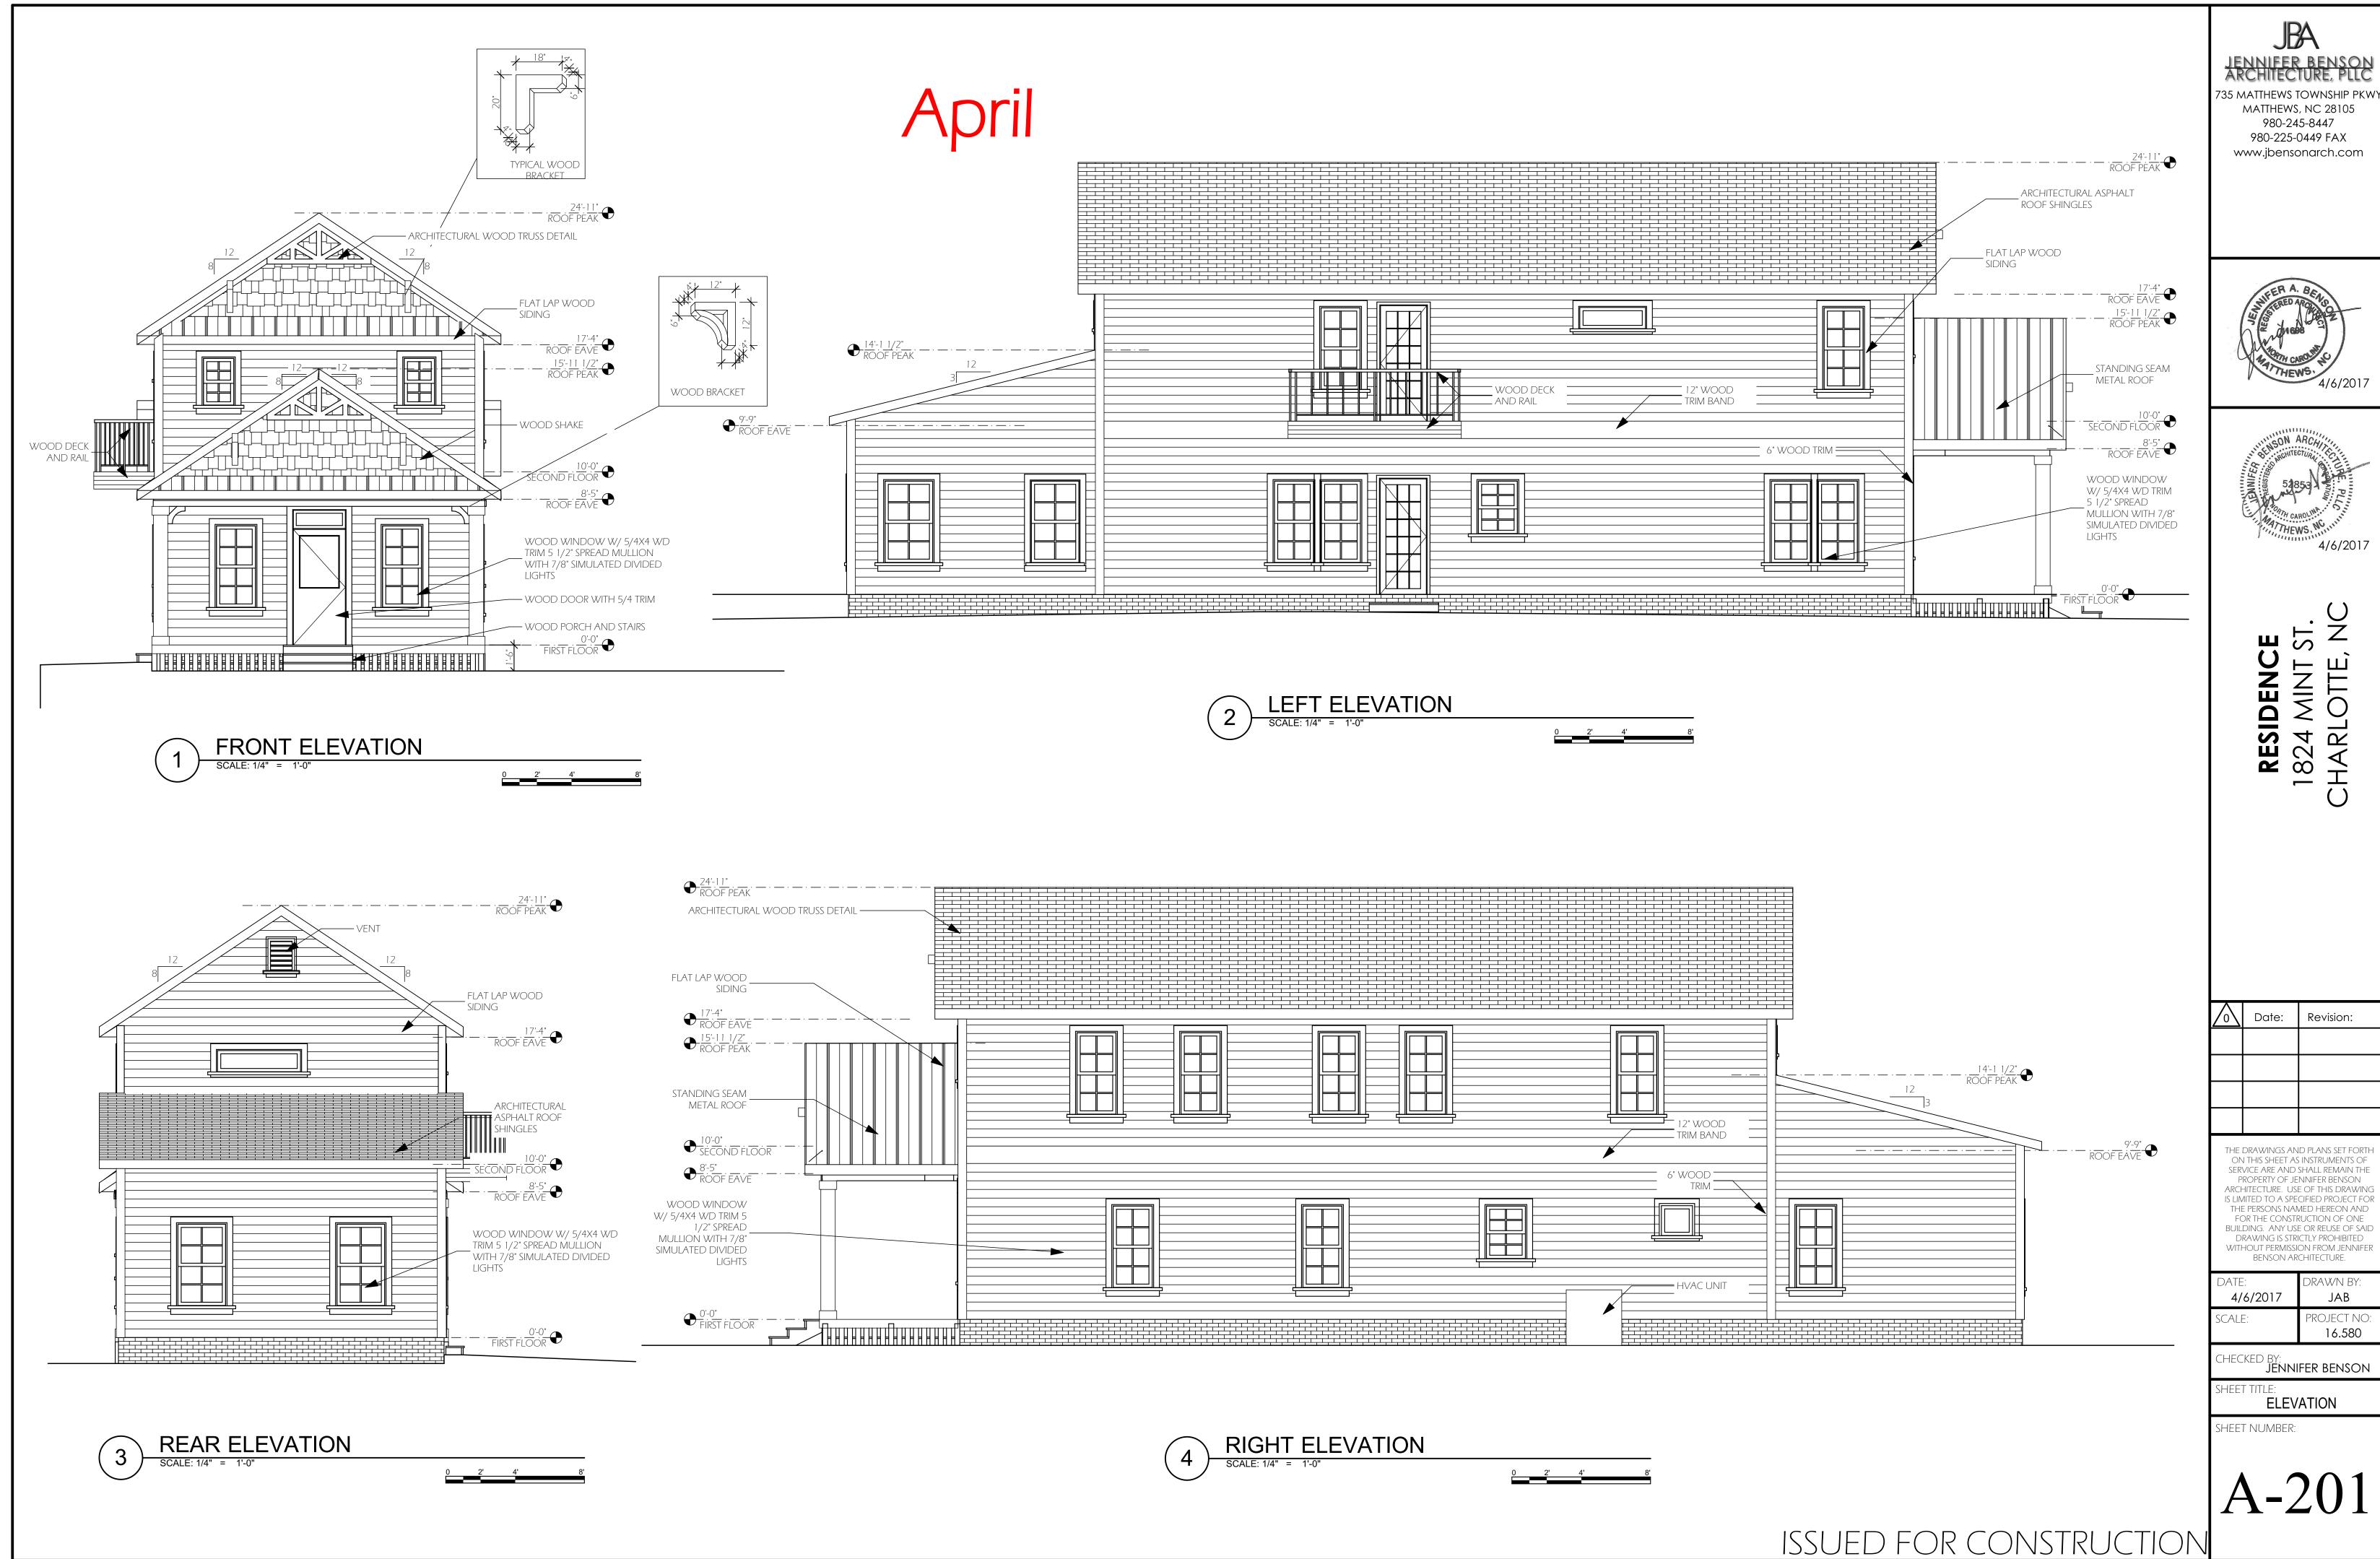
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1st FLOOR PLAN

SHEET NUMBER:

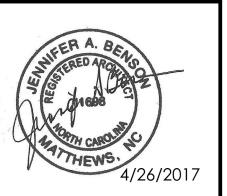A-102

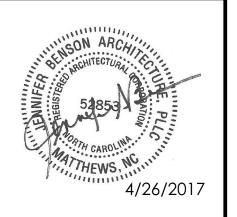ISSUED FOR CONSTRUCTION








PROJECT NO:

May

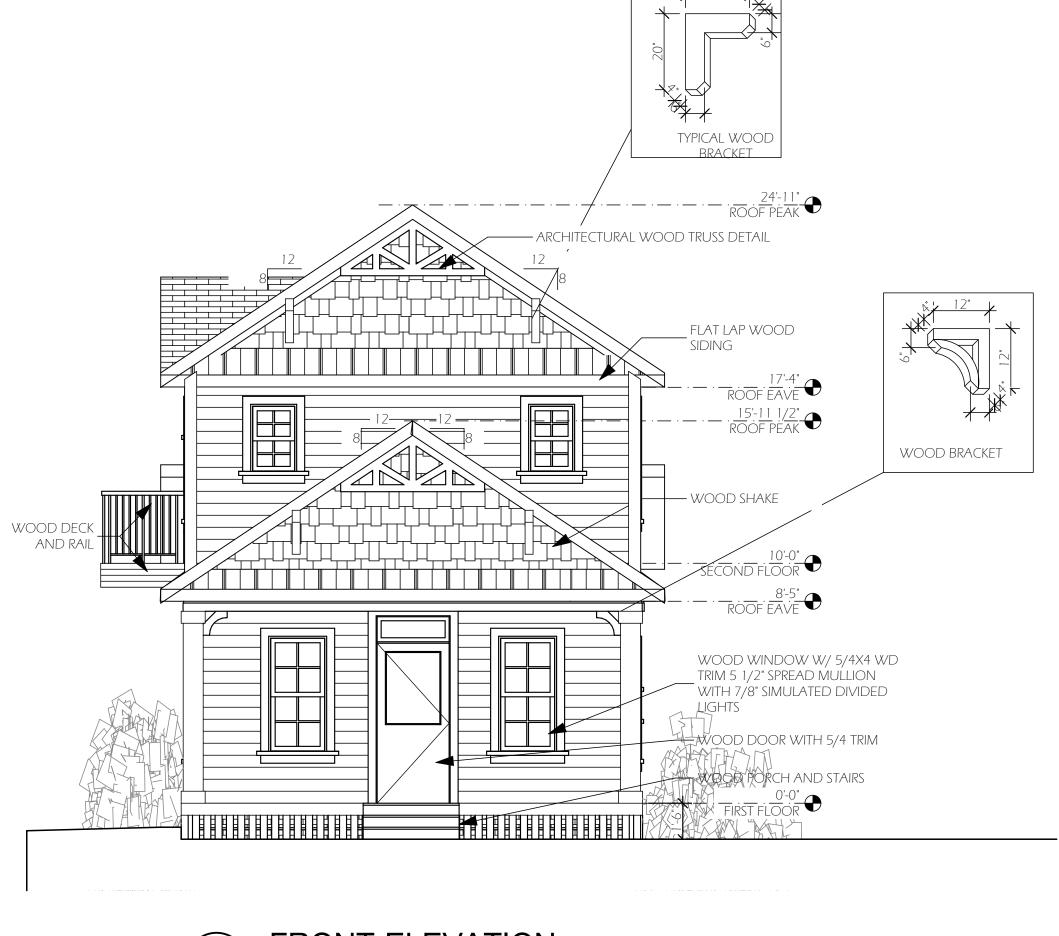

1 FRONT ELEVATION

SCALE: 1/4" = 1'-0"



LEFT ELEVATION


SCALE: 1/4" = 1'-0"

0 2' 4' 8'

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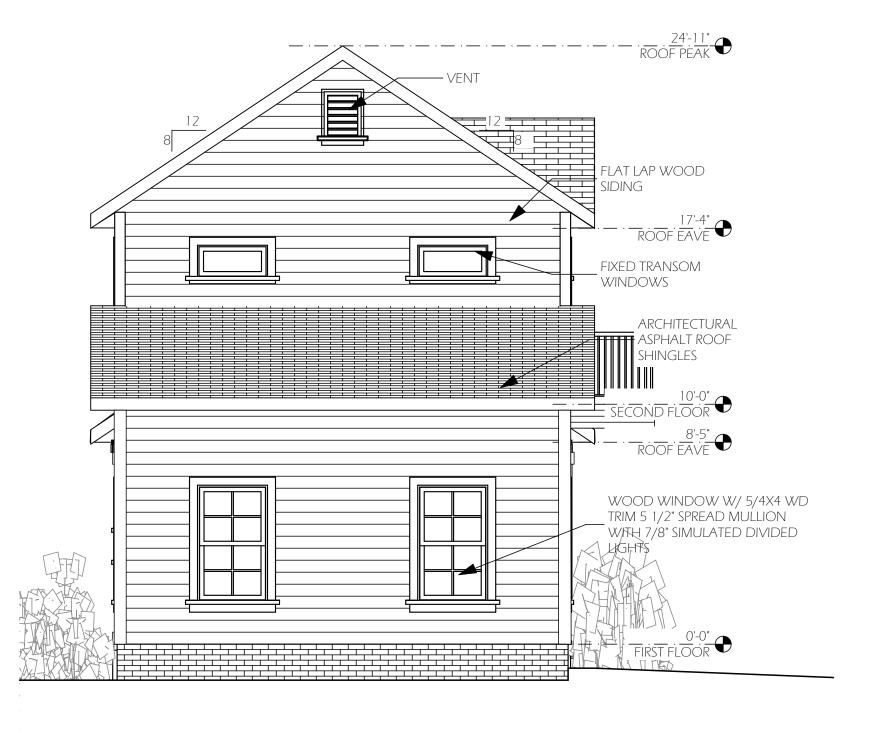
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ELEVATION

SHEET NUMBER:

 $1 \Lambda_{-}201$

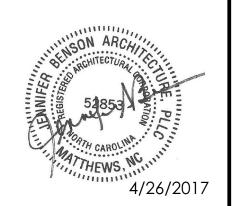May



REAR ELEVATION


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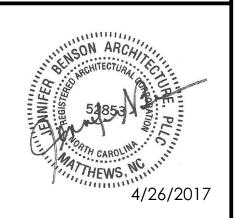
ARE DESCRIPTION OF THE STATE OF

— EVERGREEN BUSHES JBA

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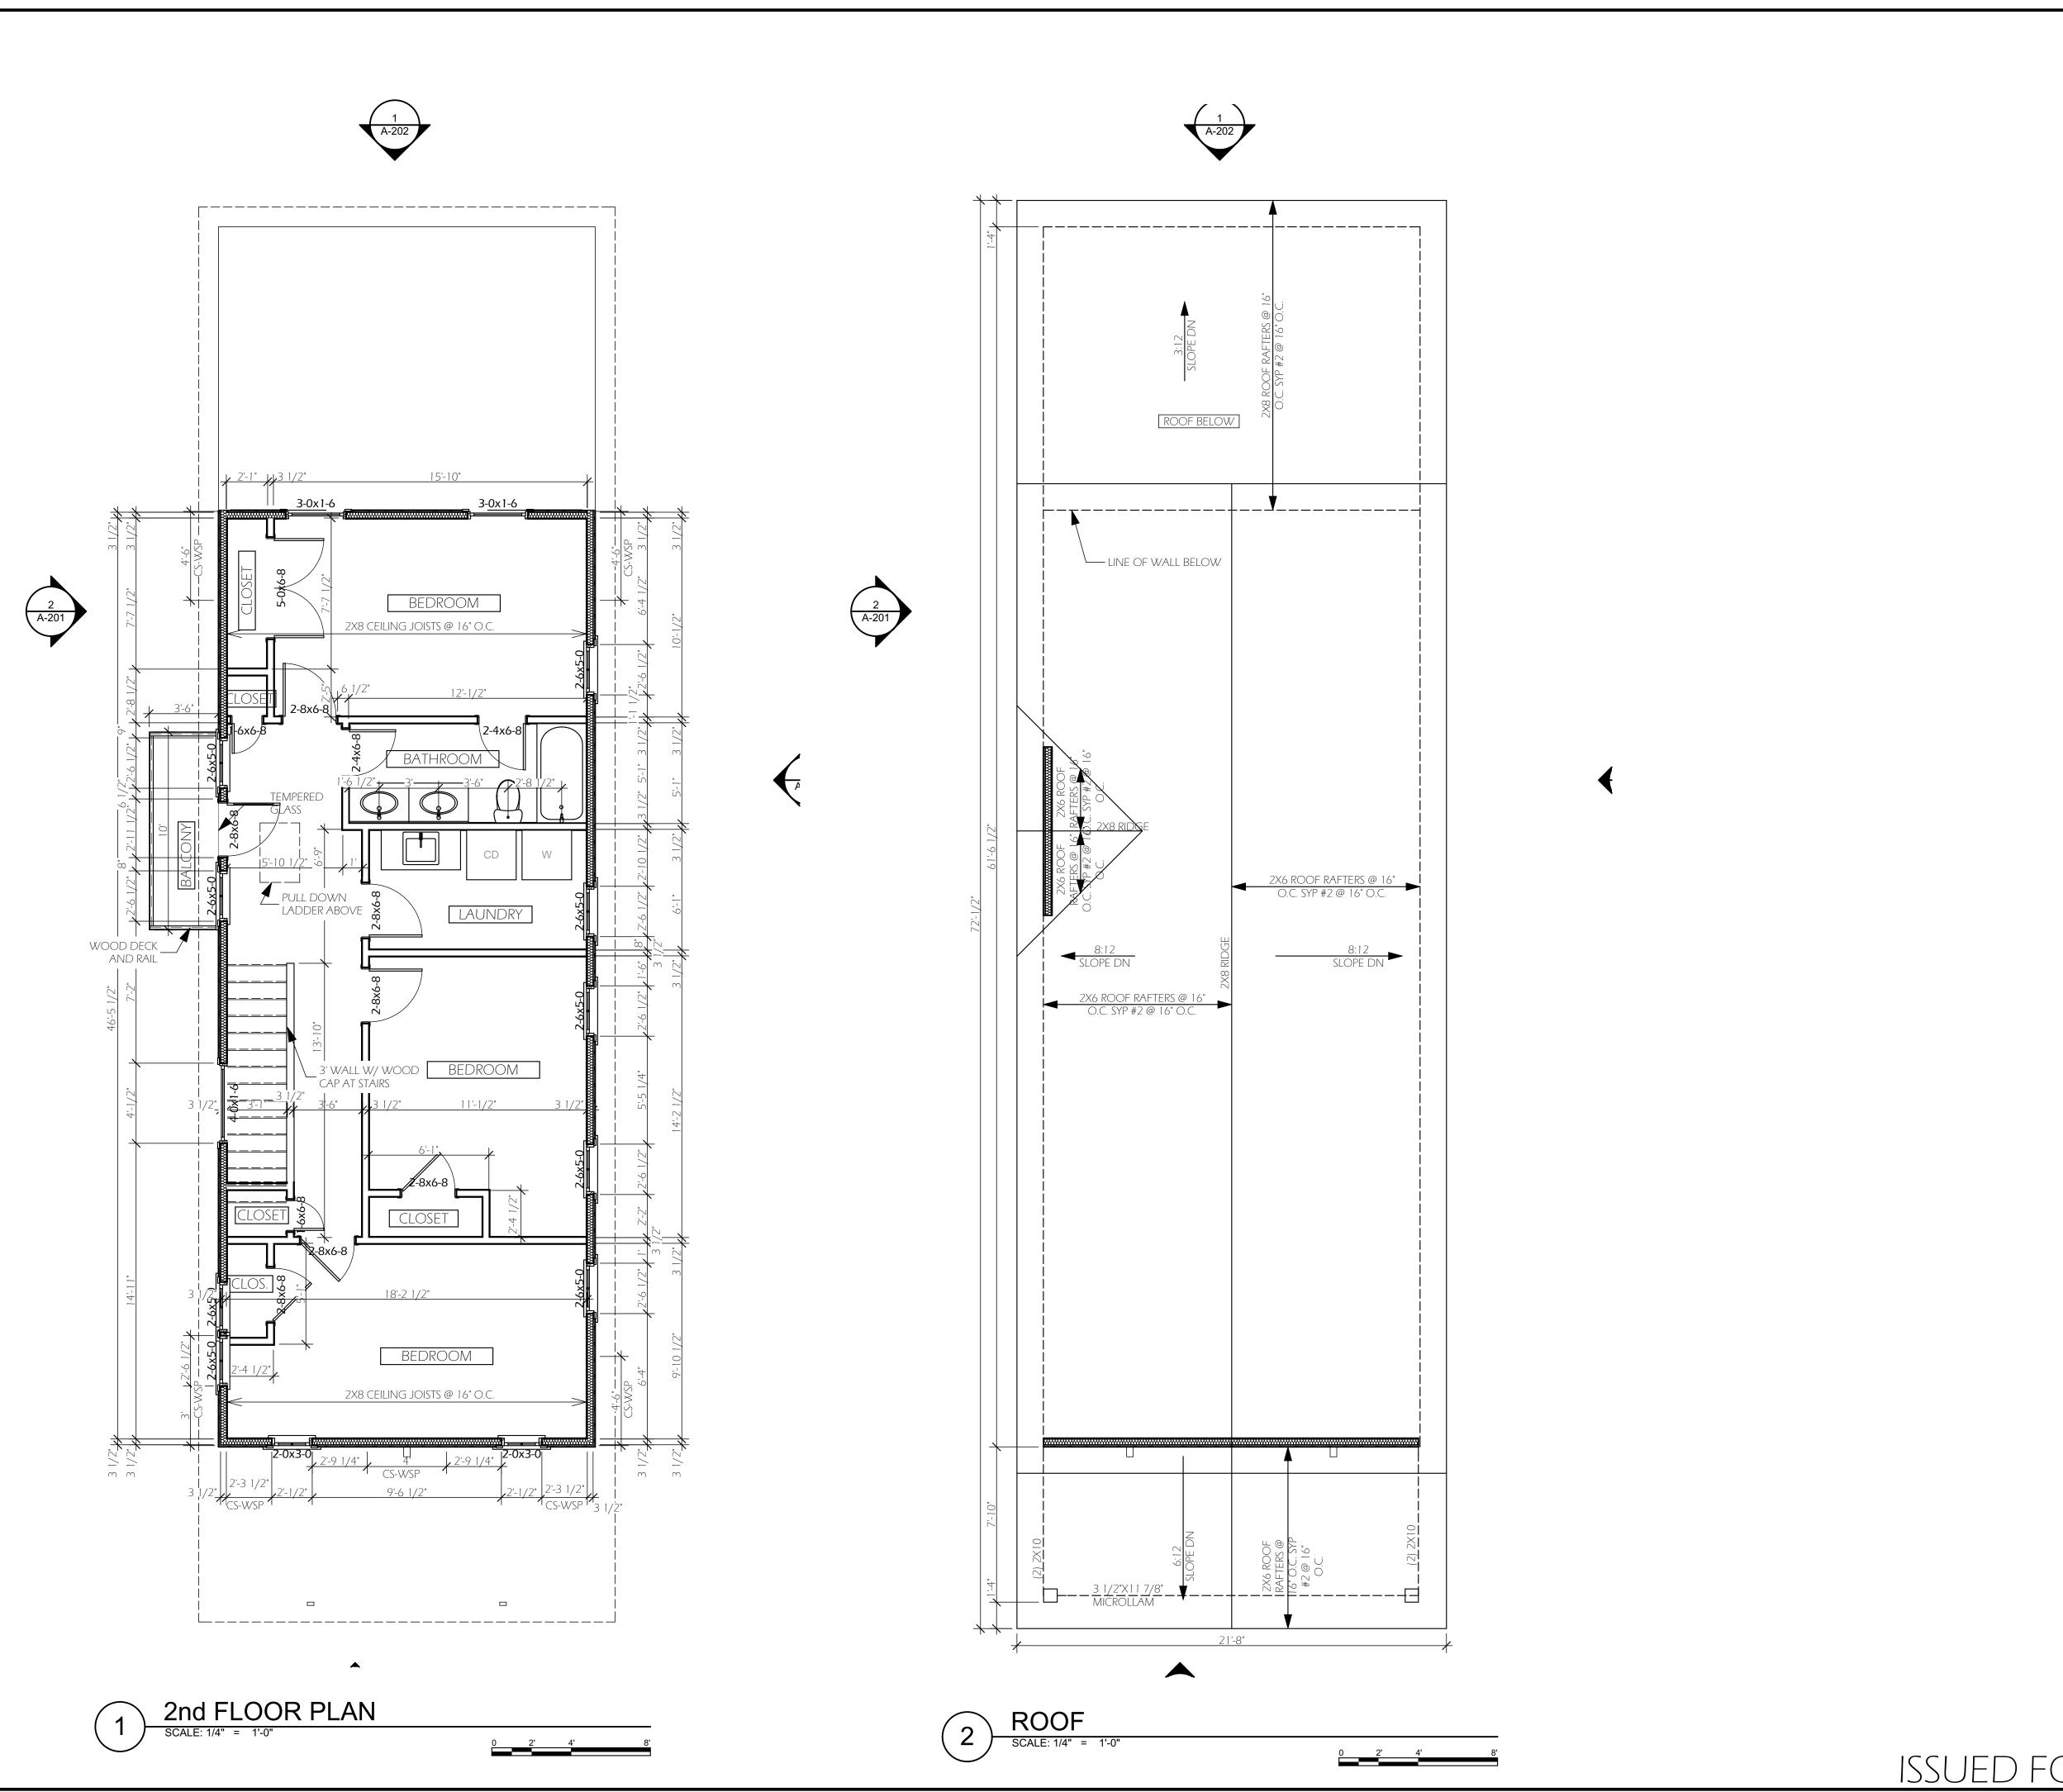
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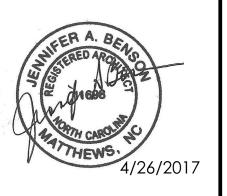
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ELEVATIONS

SHEET NUMBER:

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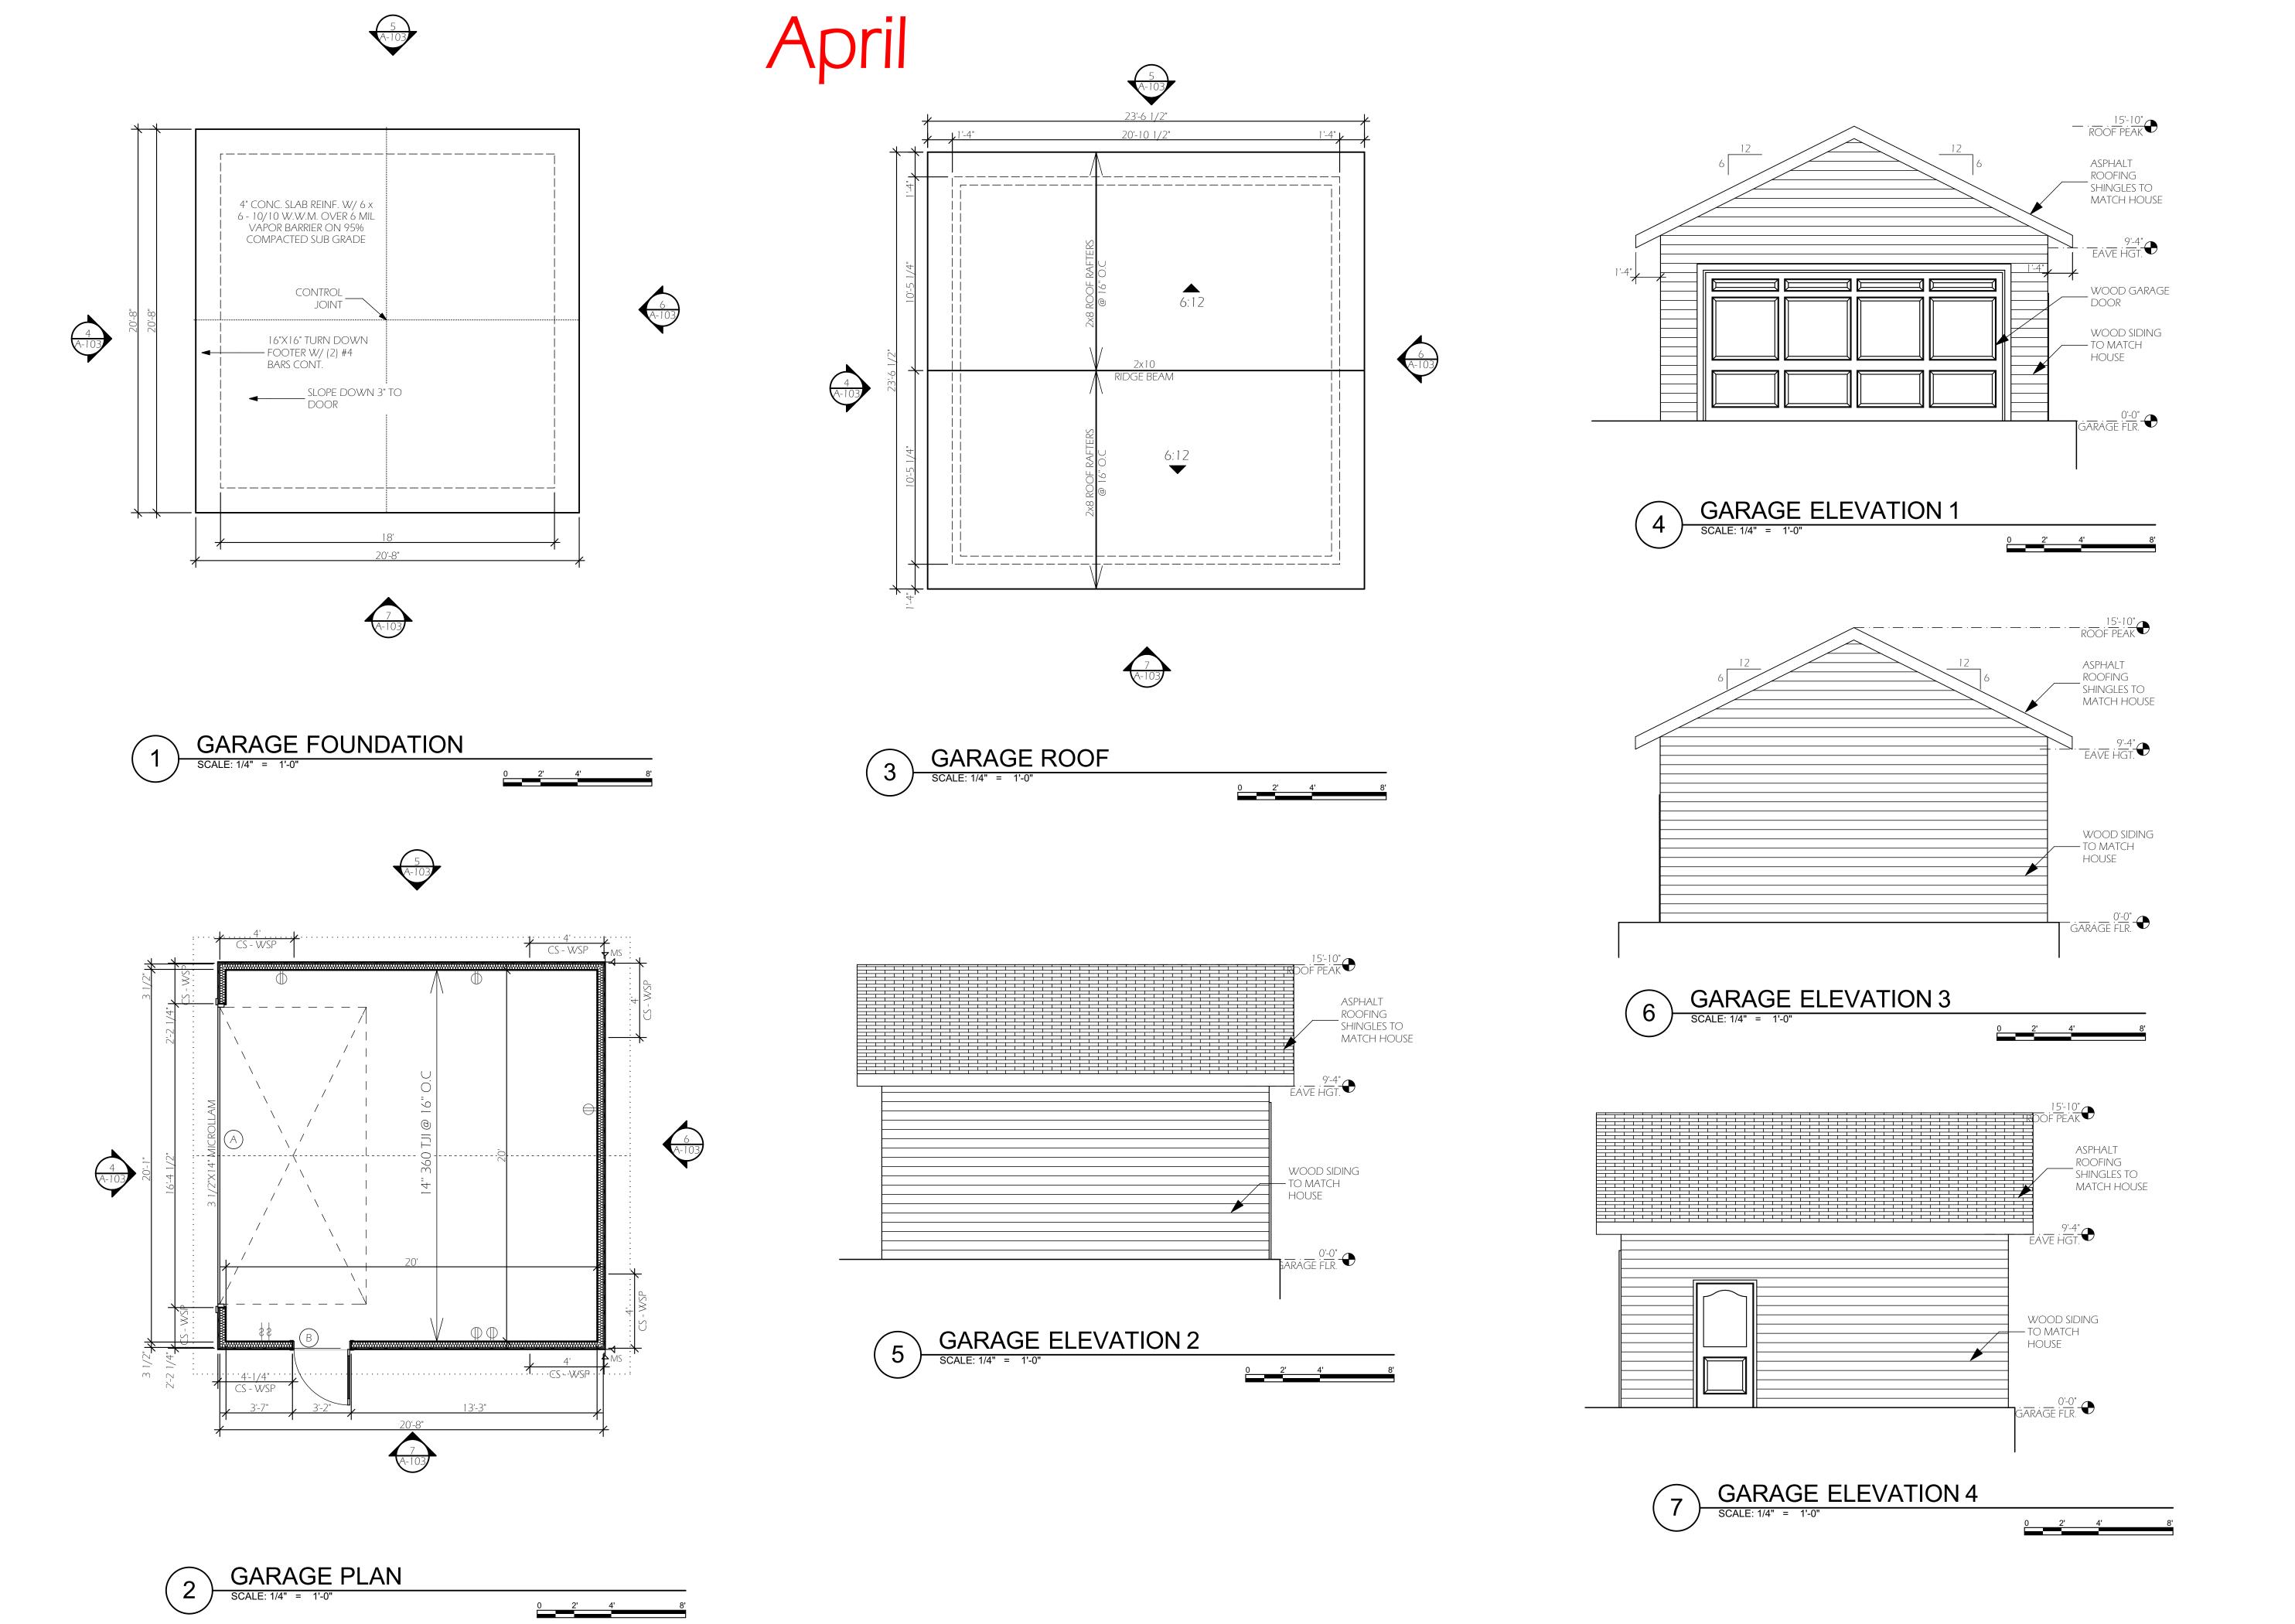
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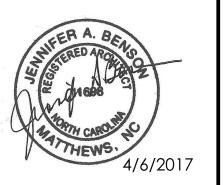
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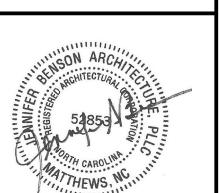
SHEET TITLE:
2ND FLOOR & ROOF PLAN

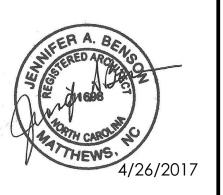SHEET NUMBER:



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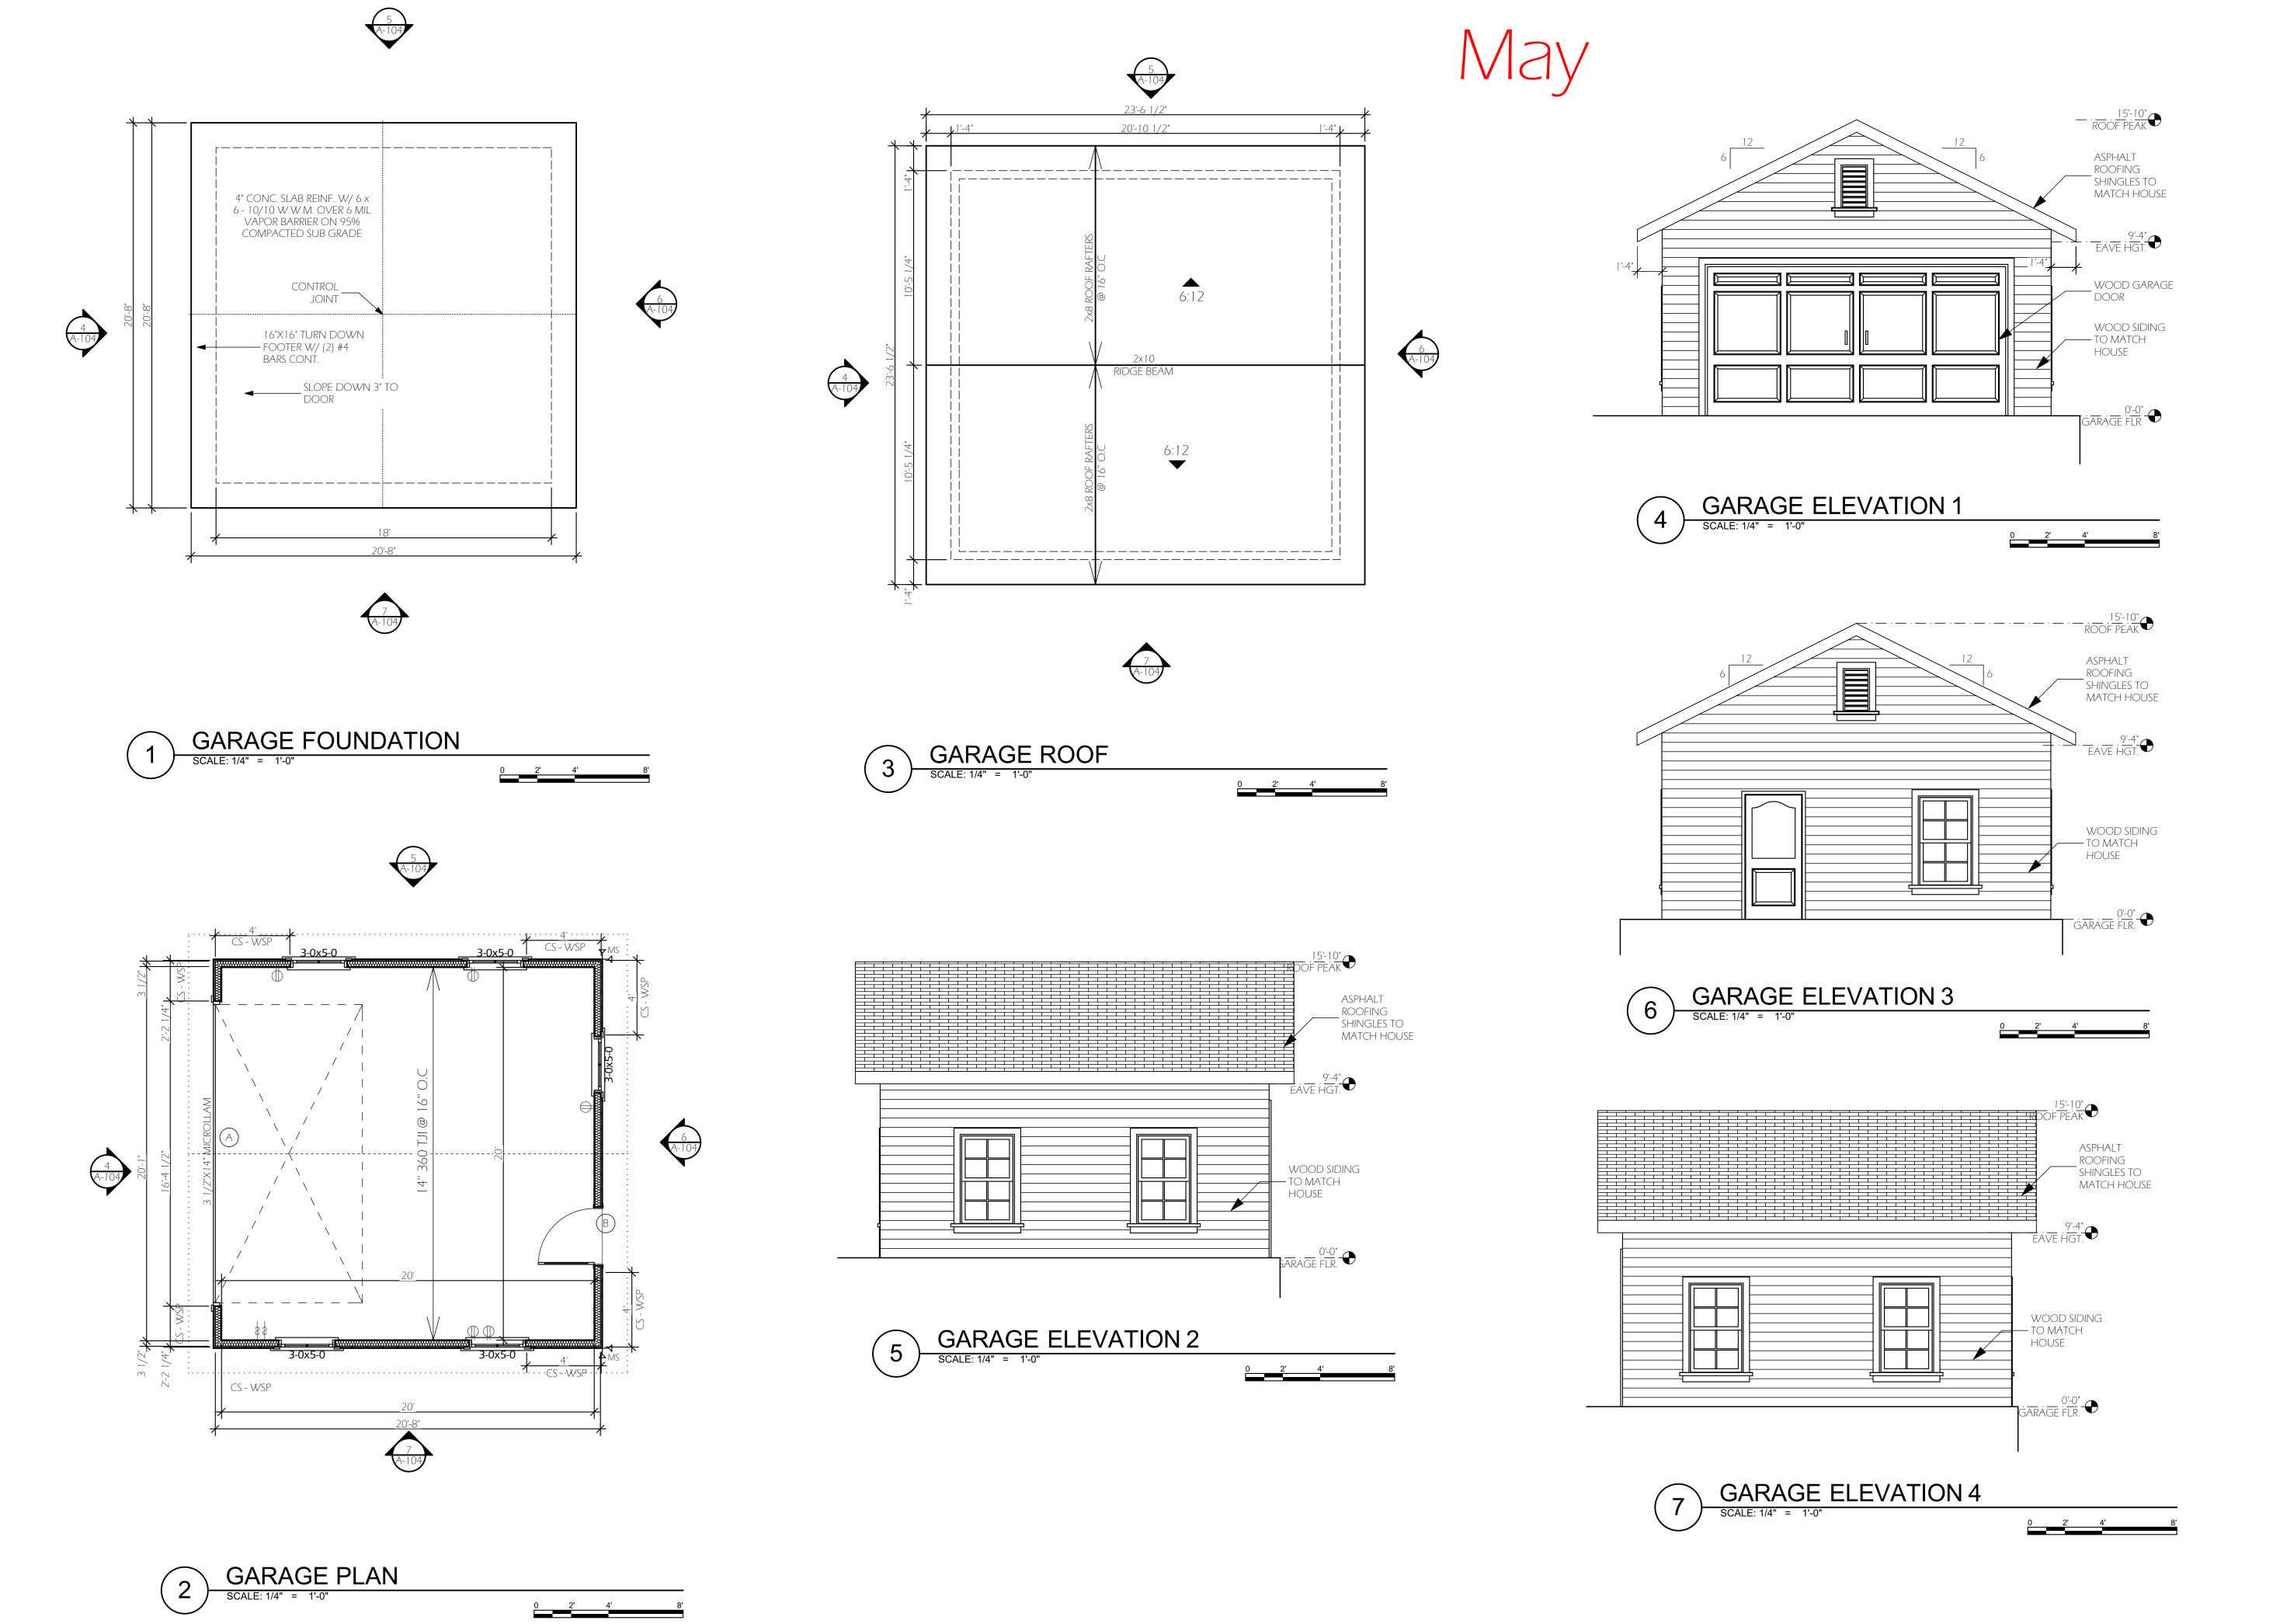
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4/6/2017 JAB

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16.580


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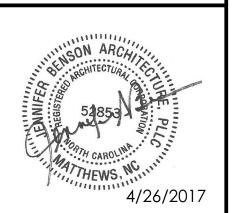
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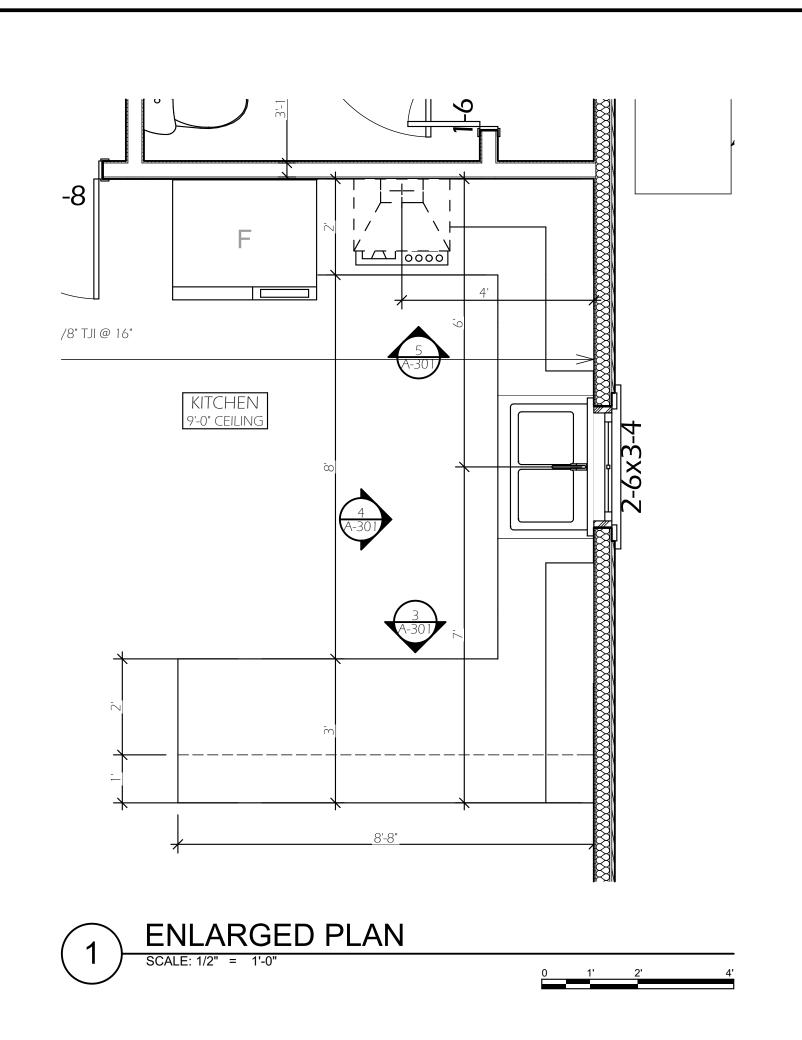
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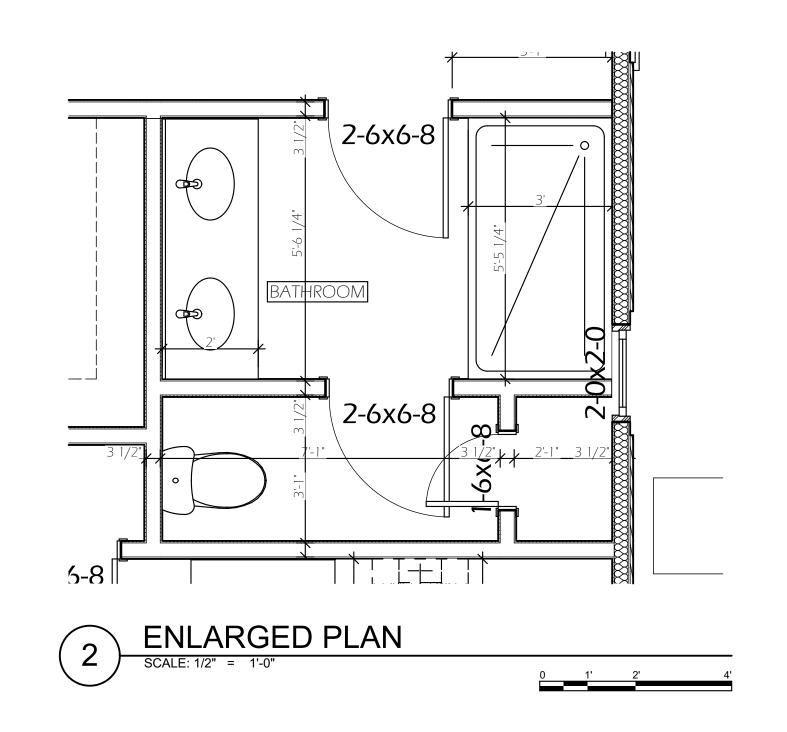
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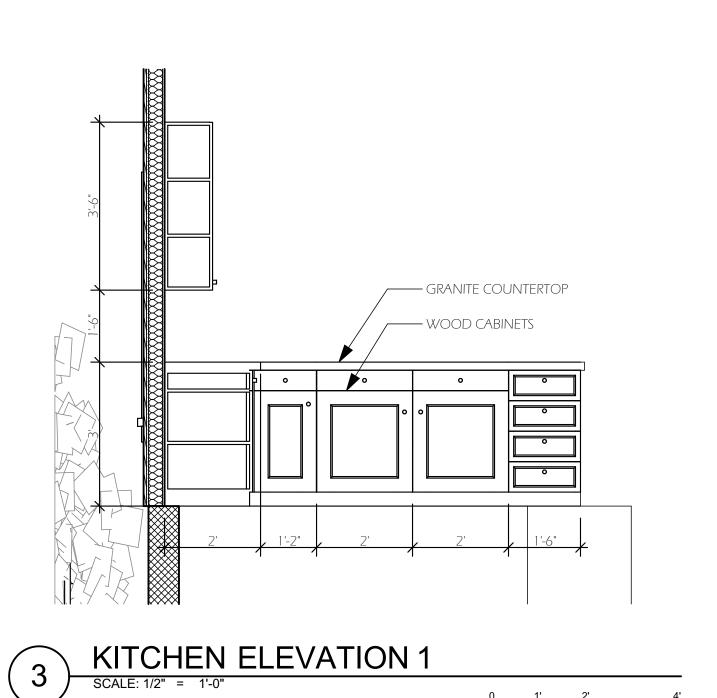
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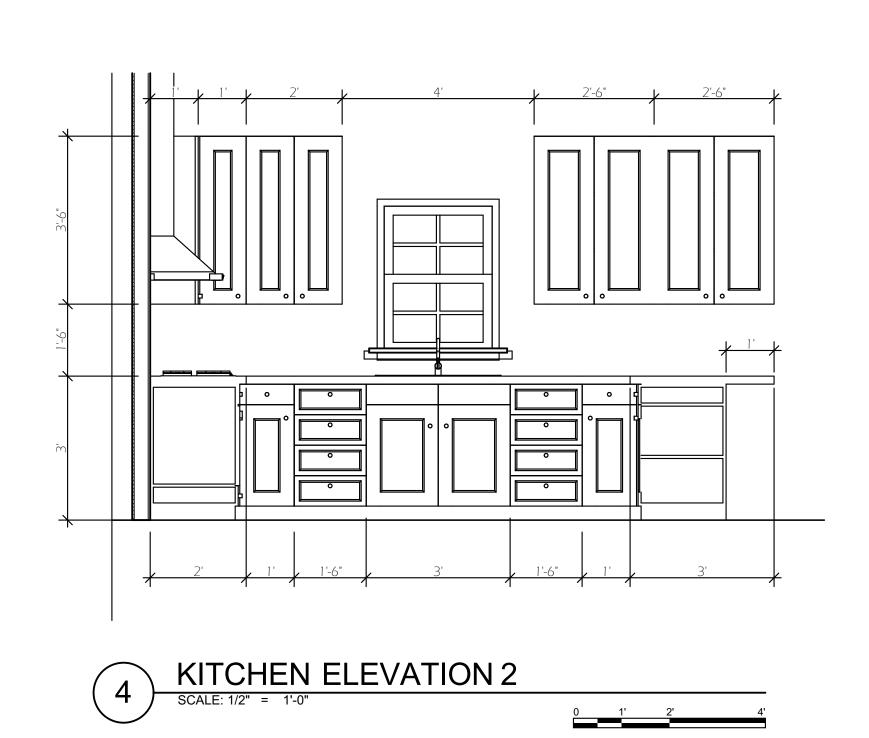
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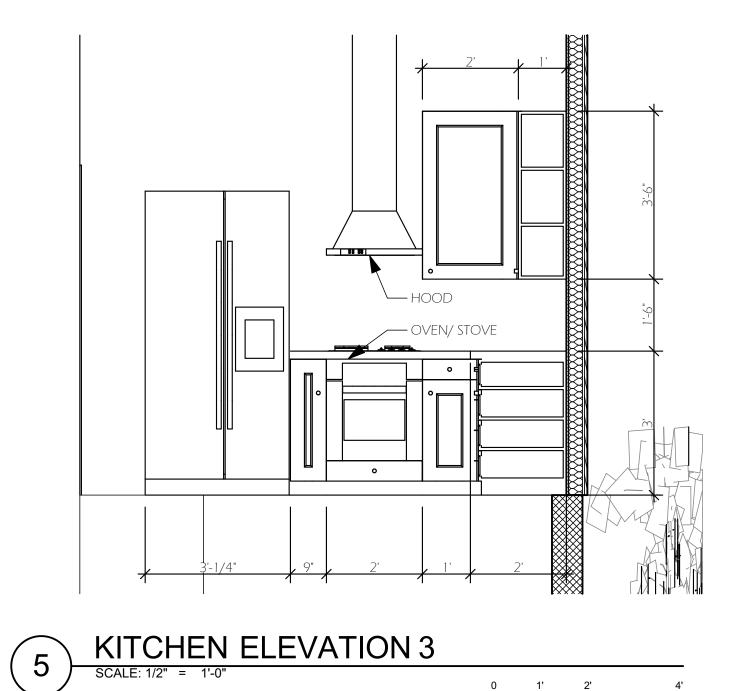
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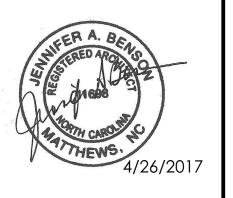








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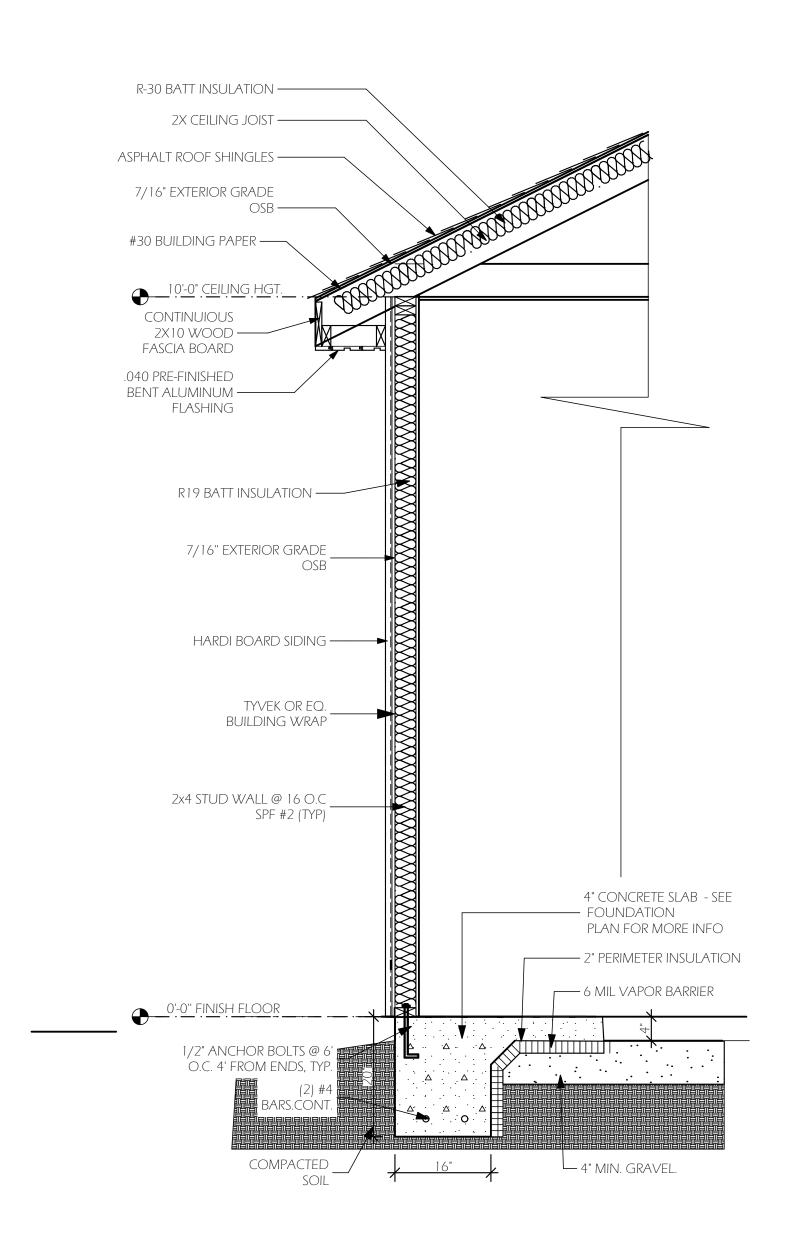
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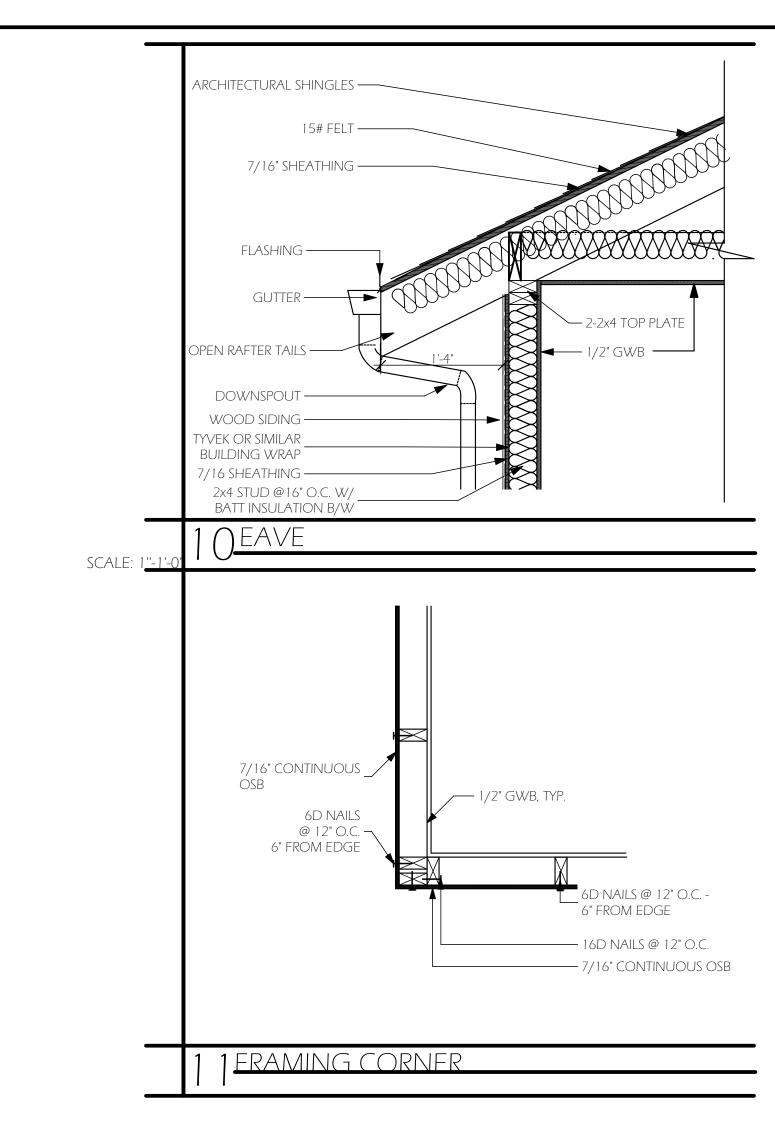
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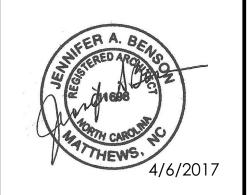
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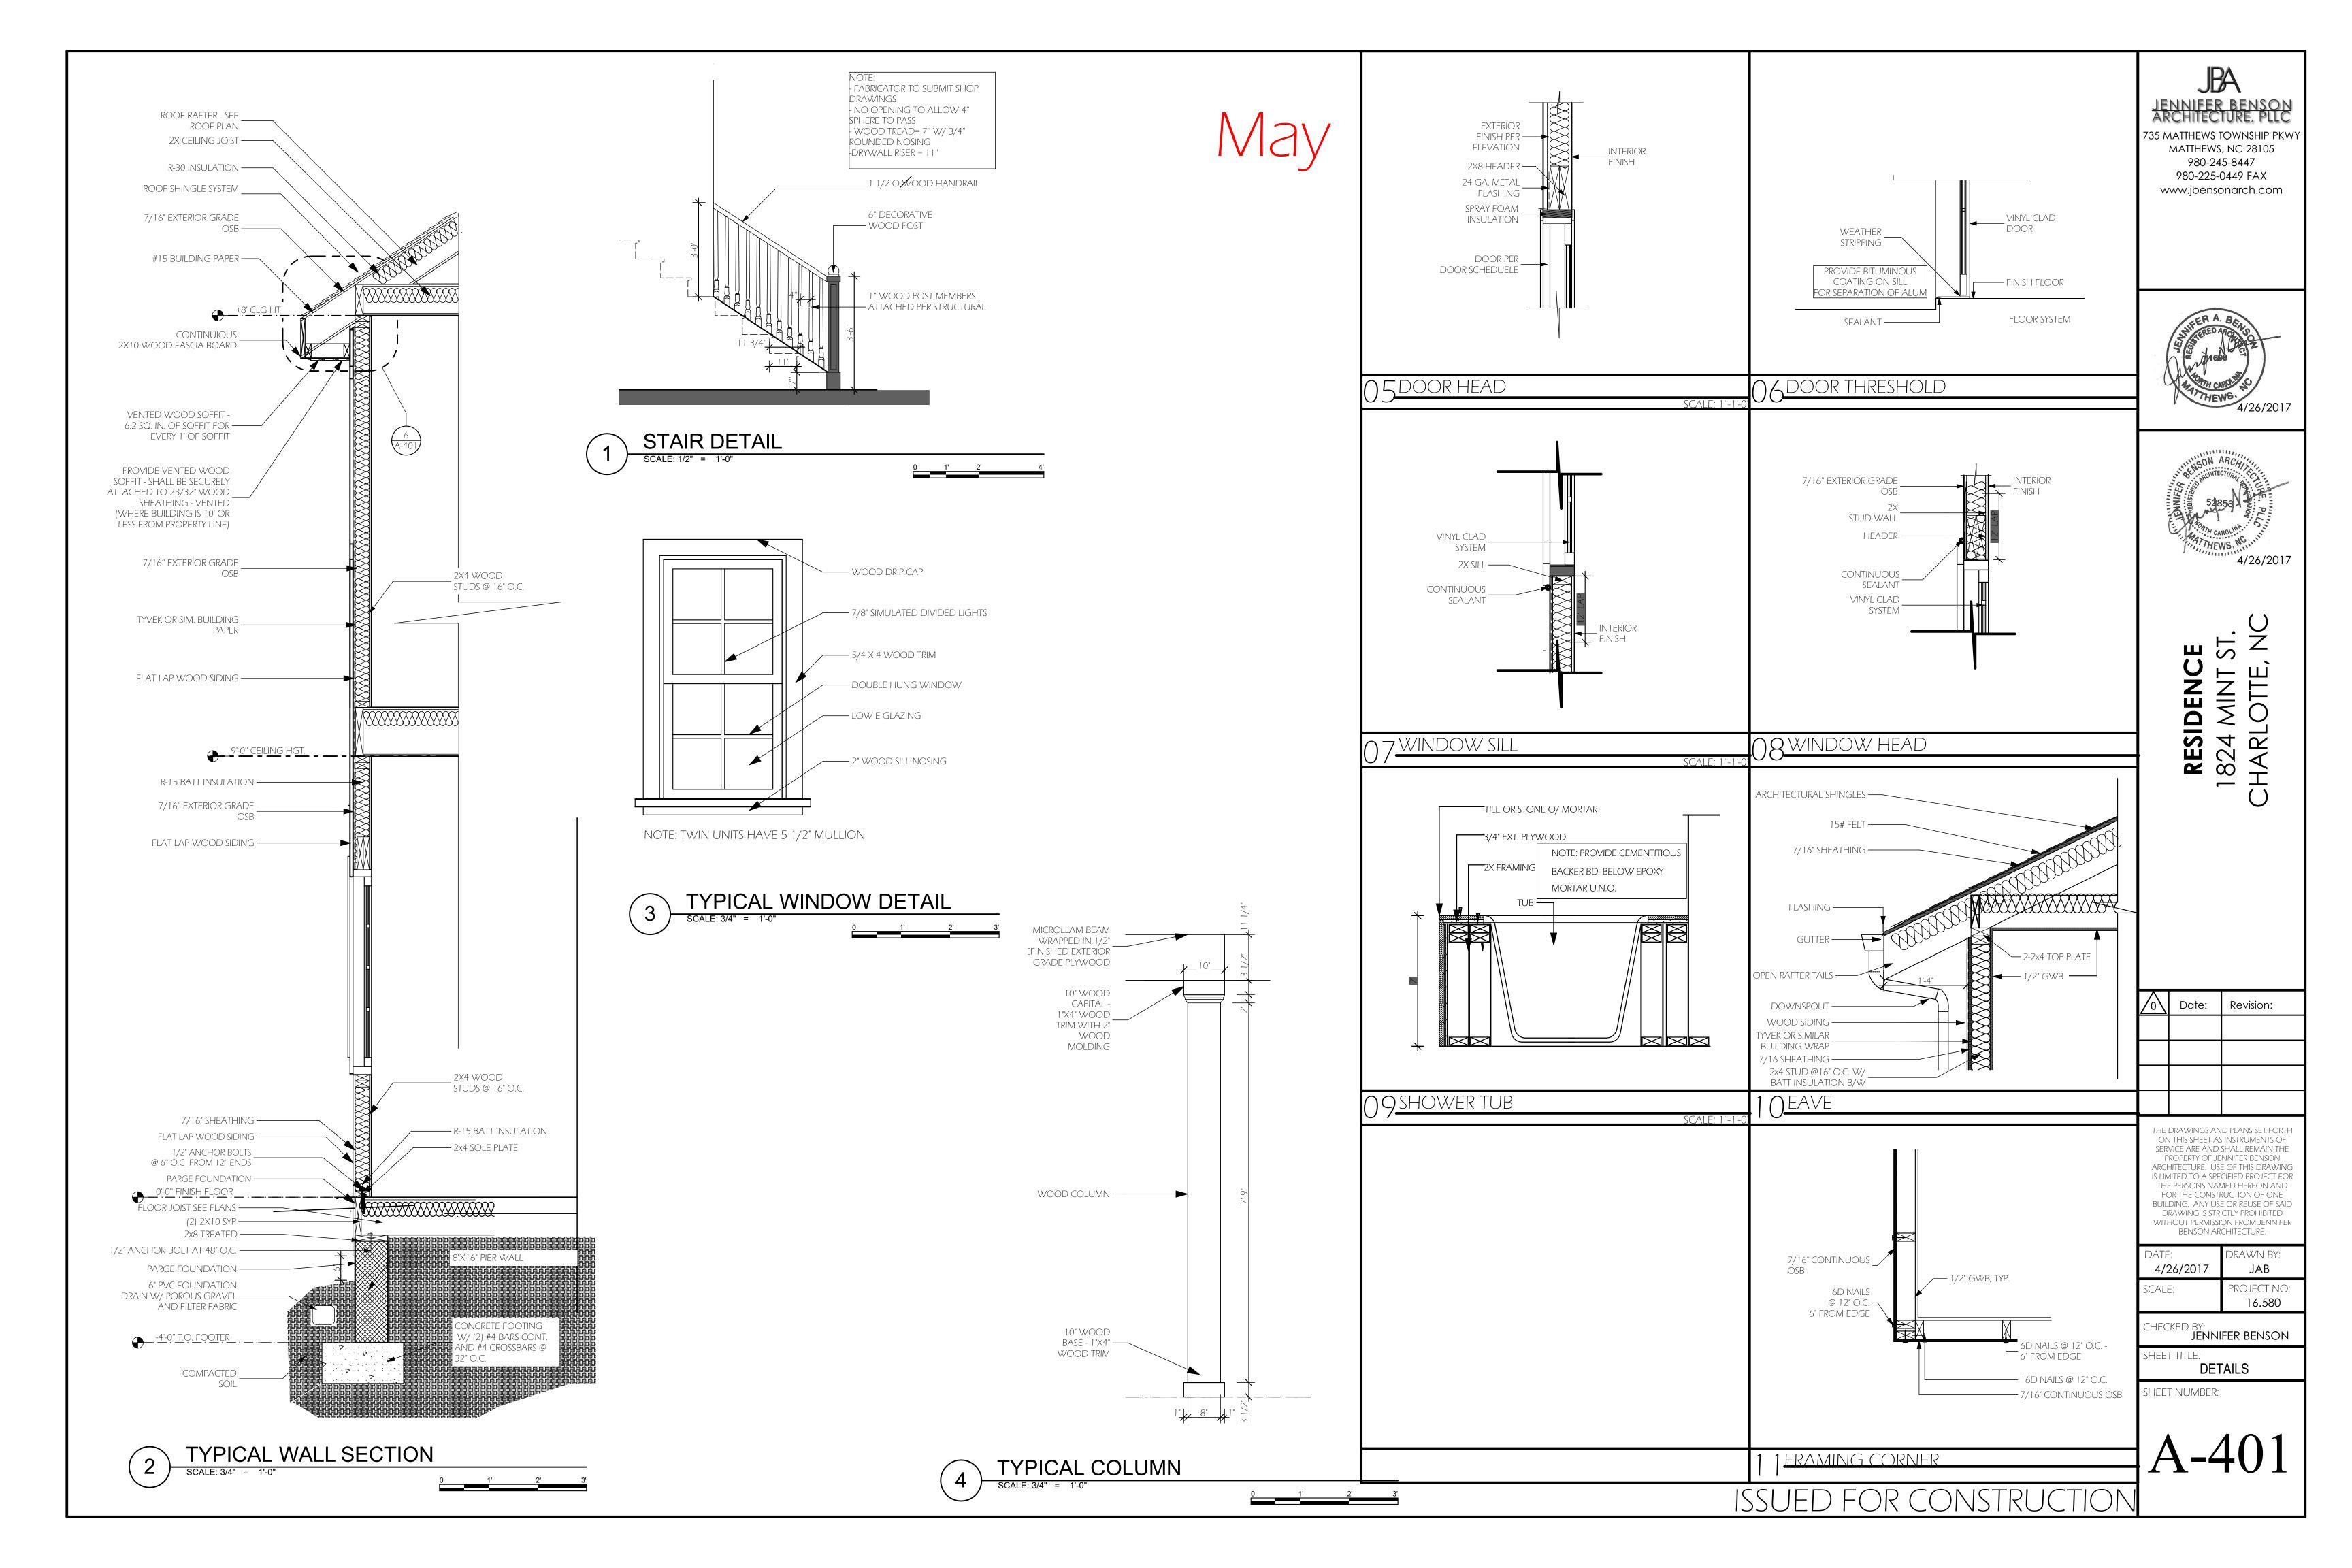
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DIVISION ONE GENERAL CONDITIONS

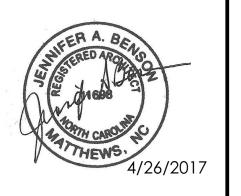- 1. THESE DRAWINGS ARE DESIGNED IN ACCORDANCE WITH CURRENT EDITION OF THE NORTH CAROLINA RESIDENTIAL CODE FOR ONE AND TWO FAMILY DWELLINGS. THE WORK SHALL COMPLY WITH ALL APPLICABLE LOCAL AND STATE CODES, ORDINANCES, REGULATIONS AND AMENDMENTS AND ALL OTHER AUTHORITIES HAVING JURISDICTION. THE WORK SHALL COMPLY WITH INTERPRETATIONS OF THE LOCAL BUILDING OFFICIAL. IF THE INTERPRETATION OF THE LOCAL BUILDING OFFICIAL IS AT VARIANCE WITH THESE DOCUMENTS, INFORM THE BUILDER PRIOR TO
- 2. FIELD CONDITIONS AND DIMENSIONS: ON-SITE VERIFICATION OF ALL DIMENSIONS AND CONDITIONS SHALL BE THE RESPONSIBILITY OF THE SUBCONTRACTORS. NOTED DIMENSIONS TAKE PRECEDENCE OVER SCALED DIMENSIONS. BUILDER SHALL BE NOTIFIED PROMPTLY OF ANY DISCREPANCIES IN INFORMATION AND OF ANY DISCREPANCIES BETWEEN FIELD CONDITIONS AND INFORMATION ON THE DRAWINGS PRIOR TO CONSTRUCTION. ALL WORK SHALL COMPLY WITH THE MANUFACTURER'S OR FABRICATOR'S INSTRUCTIONS OR RECOMMENDATIONS FOR THE PREPARATION OF SUBSTRATES AND INSTALLATION AND USE OF MATERIAL.
- 3. TEMPORARY BRACING: TEMPORARY BRACING SHALL BE USED AS REQUIRED TO STABLIZE FOUNDATION AND BASEMENT WALLS AND SUPERSTRUCTURE UNTIL PERMANENT CONSTRUCTION
- 4. DESIGN LIVE LOADS: ALL FRAMING MATERIAL SHALL BE DESIGNED IN ACCORDANCE WITH THE FOLLOWING LOADS:
- a. SLEEPING AREAS 30 PSF
- b. LIVING AREAS 40 PSF
- c. DECKS 60 PSF d. EXTERIOR BALCONIES - 60 PSF
- e. ROOF 30 PSF
- f. GARAGES 50 PSF
- g. STAIRS 40 PSF
- h. RAILINGS 200 PSF i. WIND LOADS - 15 PSF
- j. ATTIC FLOOR W/ STORAGE 20 PSF k. ATTIC FLOOR W/O STORAGE - 10 PSF
- I. BASEMENT WALLS 30 PCF EQUIVALENT FLUID PRESSURE
- m. CANTILEVERED WALLS 30 PCF EQUIVALENT FLUID PRESSURE 5. FIRE RATED ASSEMBLIES: ALL FIRE RATED ASSEMBLIES ARE CONTINUOUS UNLESS
- OTHERWISE NOTED. ASSEMBLY MATERIALS SHALL TAKE PRECEDENCE OVER MATERIALS SPECIFIED IN THESE DRAWINGS.
- a. SEAL ALL HORIZONTAL AND VERTICAL PENETRATIONS WITH APPROVED MATERIALS. b. ALL SHEATHING PENETRATIONS CAUSED BY CONSTRUCTION SHALL BE PATCHED AND REPAIRED WITH MATERIALS AND METHODS CONSISTENT WITH ORIGINAL CONSTRUCTION.
- 6. SOIL TREATMENT FOR TERMITE CONTROL IF APPLICABLE: APPLY TOXICANT TO SOIL IN ENTIRE AREA TO BE OCCUPIED BY STRUCTURE AND TO 2' BEYOND PERIMETER LINE OF STRUCTURE. USE APPROVED TOXICANT WITH A FIVE YEAR GUARANTEE. NOTE: THIS ITEM MAY BE WAIVED IF SITE CONDITIONS DO NOT WARRANT IT AND THE OWNER'S APPROVAL.
- 7. RADON CONTROL: AS REQUIRED, AND IN ACCORDANCE WITH LOCAL CODES.

DIVISION TWO - SITEWORK

1. THESE DRAWINGS DO NOT COVER SITE WORK, EXCAVATION, GRADING AND LANDSCAPING. REFER TO THE SITE DRAWINGS PREPARED BY THE CIVIL ENGINEER FOR THESE ITEMS.

- 2. EXCAVATION SHALL BE SUFFICIENT TO PROVIDE FULL DESIGN DIMENSIONS OR TO ALLOW FOR FORMING AS REQUIRED. NO FOOTINGS SHALL BE PLACED ON FROZEN EARTH.
- 3. BACKFILL AND COMPACTION USE CLEAN MATERIAL CONTAINING NO ORGANIC MATERIAL, TRASH, MUCK, ROOTS, LOGS, STUMPS, CONCRETE, ASPHALT OR OTHER DELETERIOUS SUBSTANCES. DO NOT BACKFILL AGAINST MASONRY WALLS UNTIL SUPERSTRUCTURE IS IN PLACE, OR ADEQUATE BRACING IS PROVIDED. PRIOR TO PLACING FILL, THE EXISTING SURFACE SHALL BE CLEARED OF ALL REFUSE OR ORGANIC MATERIALS. EQUIVALENT FLUID PRESSURE OF SOIL BACKFILL NOT TO EXCEED 30 PCF UNIFORM CLASS SM OR BETTER.
- 4. FOUNDATIONS COMPACTED SOIL NOT LESS THAN 1'-0" BELOW EXISTING GRADE OR PER MINIMUM FROST DEPTH FOR JURISDICTION BELOW ADJACENT FINISHED EXTERIOR GRADE UNLESS OTHERWISE NOTED ON DRAWINGS. SOIL BEARING VALUE ASSUMED TO BE 2,000 PSF MINIMUM UNLESS OTHERWISE NOTED ON DRAWINGS. BUILDER TO BE NOTIFIED IMMEDIATELY SHOULD BEARING CAPACITY OF LESS THAN 2,000 PSF OR HIGH WATER TABLE BE ENCOUNTERED. FOUNDATION WALLS OF MASONRY AND CONCRETE ARE TO BE CONSTRUCTED AS PER PLAN AND IN ACCORDANCE WITH THE APPLICABLE BUILDING CODES.
- 5. DAMPPROOFING AND WATERPROOFING FOR CONCRETE AND MASONRY FOUNDATIONS AS REQUIRED AND IN ACCORDANCE WITH LOCAL CODES. EXTERIOR FOUNDATION WALLS OF MASONRY CONSTRUCTION THAT RETAIN EARTH AND ENCLOSE HABITABLE OR USABLE SPECIES SHALL BE DAMPPROOFED BY APPLYING NOT LESS THAN 3/8" PORTLAND CEMENT PARGING TO THE WALL FROM FOOTING TO FINISHED GRADE. THE PARGING SHALL BE COVERED WITH A COAT OF APPROVED BITUMINOUS MATERIAL APPLIED AT THE RECOMMENDED RATE.
- 6. ANY PLUMBING PASSING UNDER A FOOTING OR THROUGH A FOUNDATION WALL SHALL BE PROVIDED WITH A RELIEVING ARCH OR SLEEVE TWO PIPE SIZES GREATER THAN THE PIPE PASSING THROUGH THE WALL.
- **DIVISION THREE CONCRETE**
- 1. CONCRETE SHALL REACH MINIMUM COMPRESSIVE STRENGTH OF (Fc) (SEE TABLE BELOW) ALL CONCRETE TO BE POURED IN ACCORDANCE WITH ACI 318 SPECIFICATION. CONCRETE EXPOSED TO WEATHER TO BE AIR ENTRAINED.

MINIMUM

- a. MINIMUM SPECIFIED COMPRESSIVE STRENGTH TO CONCRETE (1): i. TYPE OF LOCATION OF CONCRETE CONSTRUCTION
- SPECIFIED COMPRESSIVE STRENGTH (Fc) ii. BASEMENT SLABS AND INTERIOR SLABS ON GRADE 2,500
- EXCEPT GARAGE FLOOR SLABS
- iii. BASEMENT WALLS, FOUNDATION WALLS, EXTERIOR WALLS AND OTHER VERTICAL CONCRETE WORK EXPOSED
- TO THE WEATHER (1) AT 28 DAYS PSI
- (2) CONCRETE SHALL BE AIR-ENTRAINED. TOTAL AIR CONTENT (PERCENT BY VOLUME OF
- CONCRETE) SHALL BE NOT LESS THAN 5% OR MORE THAN 7%.
- NOTE: USE OF ADDITIVES SHALL NOT BE PERMITTED UNLESS SPECIFICALLY APPROVED BY
- THE STRUCTURAL ENGINEER. USE OF ADDITIVES CONTAINING CALCIUM CHLORIDE SHALL
- NOT BE PERMITTED.

2. REINFORCING RODS SHALL CONFORM TO ASTM A-615 GRADE 60. WWF SHALL CONFORM TO ASTM A-185 AND SHALL BE INSTALLED AS PER TABLE #1 BELOW.

NOTE: ALL REINFORCING STEEL MARKED "CONTINUOUS" SHALL BE LAPED 36 BAR DIAMETERS AT SPLICES AND AROUND CORNERS OR INTERSECTION WITH A STANDARD 90 DEGREE BEND ON CORNER BARS. LAP WELDED WIRE MESH ONE FULL MESH AT SIDE AND END LAPS.

3. SLABS ON GRADE - 4" NOMINAL THICK WITH FIBROUS REINFORCING FOR CRACK CONTROL AS PER MANUFACTURER'S SPECIFICATIONS. SLABS TO BE PLACED ON 6 MIL VAPOR BARRIER ON 4" GRAVEL. OVERLAP JOINTS BARRIER 12". SEAL OR TAPE PENETRATIONS BY PLUMBING AND AVOID PUNCTURING. SEAL EDGES OF FOUNDATION WALLS.

4. PROVIDE CONCRETE PROTECTION FOR REINFORCING AS FOLLOWS:

a. FOOTINGS b. WALLS 2" TO OUTSIDE FACE, 1 1/2" TO INSIDE FACE

DIVISION FIVE - METALS

1. FOUNDATION ANCHOR BOLTS - SHALL BE PROVIDED AT MAXIMUM 6'-0" o.c. INTERVALS AND PLACED 12" FROM END OF EACH SECTION WITH MINIMUM TOW ANCHOR BOLTS PER SECTION OF WALL. ANCHOR BOLT SHALL BE MINIMUM 1/2" DIAMETER AND SHALL BE EMBEDDED IN FOUNDATION IN DEPTH MINIMUM 7" OF POURED IN PLACE CONCRETE AND NOT LESS THAN 15" IN GROUTED UNIT MASONRY. ANCHOR BOLT CAN BE SUBSTITUTED WITH METAL STRAP PER MANUFACTURERS SPECIFICATIONS. ALL BEARING PLATES SHALL BE ON MINIMUM 8" DEEP SOLID

2. STEEL - ALL METAL ANCHORS, FASTENERS, JOIST HANGERS, etc. TO BE GALVANIZED. ALL STRUCTURAL STEEL TO CONFORM TO ASTM-36. PIPE TO BE A53. TUBE TO BE A500 OF A501. DETAILING TO BE IN ACCORDANCE WITH AISC STRUCTURAL STEEL DETAILING MANUAL CONNECTIONS SHALL BE CAPABLE OF SUPPORTING ALLOWABLE UNIFORM LOAD STRESS OF 24 KSI. STEEL COLUMNS AND BASES TO BE GIVEN A SHOP COAT OF RUST INHIBITIVE PAINT OR EQUIVALENT. BOTTOM OF STEEL COLUMNS SHALL BE ANCHORED IN CONCRETE.

3. NAILING SCHEDULE - AS PER CURRENT IRC AND OTHER APPLICABLE BUILDING CODES, OR MANUFACTURERS RECOMMENDED STANDARDS, BUT NOT LESS THAN THAT REQUIRED BY MANUFACTURER'S RECOMMENDED STANDARDS, AND NOT LESS THAN THAT REQUIRED BY CODE.

DIVISION SIX - WOOD 1. SILL PLATE - PLATE TREATED TO MEET AWPA STANDARDS WHERE INDICATED ON PLANS AND AS REQUIRED BY APPLICABLE CODE.

2. ALL EXPOSED EXTERIOR LUMBER OR LUMBER IN CONTACT WITH MASONRY OR CONCRETE SHALL BE PRESSURE PRESERVATIVE TREATED IN ACCORDANCE WITH AWPA STANDARDS. PROVIDE FIRE RETARDANT SHEATHING AND LUMBER WHERE INDICATED ON DRAWINGS. ALL WOOD SHALL BE A MINIMUM OF 8" ABOVE FINISH GRADE OR PRESSURE PRESERVATIVE TREATED LESS THAN 8" ABOVE FINISH GRADE.

3. MAXIMUM MOISTURE CONTENT OF ALL LUMBER SHALL BE 19%, KILN DRIED IN ACCORDANCE WITH AWPA STANDARDS.

4. STRENGTH OF FRAMING MATERIALS:

a. ALL FRAMING LUMBER EXCEPT WALL STUDS SHALL BE AF & PA/NDS (OR OTHER APPROVED AGENCY) RATED SOUTHERN YELLOW PINE, GRADE 2 OR BETTER HAVING THE FOLLOWING MINIMUM PROPERTIES:

- BENDING STRESS "Fb"= 2x8 = 1210
- BENDING STRESS "Fb"= 2x10 = 1105 - BENDING STRESS "Fb"= 2x12 = 1005
- HORIZONTAL SHEAR "Fv" = 70 PSI
- COMPRESSION PERPENDICULAR TO GRAIN "Fc" 425 PSI
- MODULUS OF ELASTICITY "E" 1,400,000 PSI b. ALL STRUCTURAL POSTS EXCEPT built UP TACK STUDS SHALL BE SOUTHERN YELLOW
- PINE. GRADE 2 OR BETTER. HAVING THE FOLLOWING MINIMUM PROPERTIES:
 - BENDING STRESS "Fb"= 1200 PSI FOR SINGLE MEMBER USE - BENDING STRESS "Fb"= 1400 PSI FOR FOR REPETITIVE MEMBER USE
 - HORIZONTAL SHEAR "Fv" = 90 PSI
 - COMPRESSION PERPENDICULAR TO GRAIN "Fc11" 565 PSI
- MODULUS OF ELASTICITY "E" 1,600,000 PSI c. BEAMS SHALL HAVE THE FOLLOWING MINIMUM PROPERTIES:
- LAMINATED BEAMS (LVL)
- SHALL BE 1 3/4" WIDE - BENDING STRESS "Fb"=2600 PSI
- HORIZONTAL SHEAR "Fv" = 285 PSI - COMPRESSION PERPENDICULAR TO GRAIN "Fc" - 750 PSI
- MODULUS OF ELASTICITY "E" 1,900,000 PSI
- COMPRESSION PARALLEL TO GRAIN = 2510 PSI
- SHALL BE 3 1/2" WIDE - BENDING STRESS "Fb"=2900 PSI
- HORIZONTAL SHEAR "Fv" = 290 PSI
- COMPRESSION PERPENDICULAR TO GRAIN "Fc" 750 PSI - MODULUS OF ELASTICITY "E" - 2,000,000 PSI
- COMPRESSION PARALLEL TO GRAIN = 2900 PSI
- NOTE: PREFABRICATED STRUCTURAL TIMBERS SHALL CONFORM TO ONE OF THE FOLLOWING SPECIFICATIONS:
 - NFR-481
 - ICBOES ER-4979 FHA/HUD - PARALAM - MR-1303
 - FHA/HUD MICROLAM HUD 925g
- d. WOOD STUDS TO BE SPF STUD GRADE OR BETTER, HAVING THE FOLLOWING MINIMUM PROPERTIES:
 - BENDING STRESS, Fb REP = 650 PSI
 - COMPRESSION PERPENDICULAR TO GRAIN "Fc" 425 PSI - MODULUS OF ELASTICITY "E" - 1,200,000 PSI
- i. STUDS AT BEARING WALLS TO BE 2x4'S AT 16" o.c. EXCEPT AS NOTED ON DRAWINGS. WHENEVER HEIGHT OF STUD WALL EXCEEDS 10'-0", STUDS SHALL EXTEND CONTINUOUSLY, IN ONE PIECE, TO FULL HEIGHT OF WALL, UNLESS OTHERWISE NOTED ON PLANS. ii. INTERIOR NON-BEARING STUDS TO BE 24" o.c. UNLESS OTHERWISE NOTED. INTERIOR
- NON-BEARING STUDS SUPPORTING CABINETRY TO BE 16" o.c.
- e. PRE-ENGINEERED WOOD FLOOR JOISTS AND FLOOR TRUSSES SHALL BE PER DEPTH SHOWN ON DRAWINGS AND SPACING AS PER MANUFACTURER. ALL PRE-ENGINEERED ROOF AND FLOOR TRUSSES AND WOOD I JOISTS SHALL BE DESIGNED FOR THE LIVE LOADS AS SHOWN IN THE GENERAL CONDITIONS SECTION AS WELL AS THE FOLLOWING: DEAD LOAD TOP CHORD - 7 PSF

DEAD LOAD BOTTOM CHORD - 10 PSF

- i. PREFABRICATED TRUSS I JOISTS SHALL BE DESIGNED TO RESIST THE LOADINGS SHOWN WITH A MAXIMUM LIVE LOAD DEFLECTION OF L/480 OF THE SPAN.
- 5. INSTALLATION a. WHERE DOUBLE MEMBERS ARE INDICATED ON THE DRAWINGS, MECHANICALLY FASTEN BOTH MEMBERS IN A MANNER SUCH THAT BOTH MEMBERS SHARE THE SUPERIMPOSED LOADS,
- INCLUDING LOADS FROM HEADERS. b. WOOD JOISTS SHALL HAVE A MINIMUM BEARING OF 1 1/2". WOOD FLOOR TRUSSES TO HAVE MINIMUM BEARING AS PER MANUFACTURER'S RECOMMENDATIONS.
- c. PRE-ENGINEERED JOISTS AND BEAM HANGERS SHALL BE SIZED AND ATTACHED PER MANUFACTURER'S RECOMMENDATIONS. HOLES THROUGH WOOD I BEAMS SHALL NOT EXCEED MANUFACTURER'S RECOMMENDATIONS. NO HOLES OR CUTS ARE ALLOWED THROUGH TOP OR
- d. WOOD FLOOR AND ROOF TRUSSES SHALL BE DESIGNED AND FABRICATED BY THE TRUSS MANUFACTURER AND SHALL COMPLY WITH THE NATIONAL DESIGN SPECIFICATIONS FOR STRESS GRADE LUMBER AND ITS FASTENINGS. SUBMIT SHOP DRAWINGS AND CALCULATIONS SEALED BY A P.E. TO THE PLAN REVIEWER AS REQUIRED. METAL PLATE CONNECTED WOOD TRUSSES SHALL COMPLY WITH ANSI/TPI HIB.
- ii. THE DESIGN AND DETAIL OF ALL TRUSSES WILL MEET THE REQUIREMENTS OF FHA G4541.1 DESIGN CRITERIA FOR TRUSSED RATERS, THE "NATIONAL SPECIFICATION FOR STRESS GRADE LUMBER AND ITS FASTENINGS". AND ALL APPLICABLE BUILDING CODES.

- e. PROVIDE CONTINUOUS BAND JOINTS AND REINFORCING AT CONCENTRATED LOADS PER MANUFACTURER'S INSTRUCTIONS.
- f. BEARING STUDS SHOULD BE AT 16: O.C. WITH 2 TOP PLATES, AND CARE SHOULD BE EXERCISED TO ENSURE LOCATING SUPPORTED FLOOR JOISTS OR ROOF TRUSSES WITHIN 5 INCHES OF THE STUDS BENEATH.
- 6. HEADERS ALL HEADERS OVER ALL FRAMED OPENINGS TO BE AS SHOWN ON THE
- DRAWINGS. IF NO HEADER SIZE IS INDICATED, THE FOLLOWING SHALL APPLY: a. 2 - 2x8 - OPENINGS UP TO 4'-6"
- b. 2 2x10 OPENINGS UP TO 5'-6" c. 2 - 2x12 - OPENINGS UP TO 6'-5"
- 7. PLYWOOD AND O.S.B. USED STRUCTURALLY SHALL MEET THE PERFORMANCE STANDARDS AND ALL OTHER REQUIREMENTS OF APPLICABLE US COMMERCIAL STANDARDS FOR THE TYPE, GRADE AND SPECIES OF PLYWOOD AND SHALL BE SO IDENTIFIED BY AN APPROVED TESTING AGENCY.
- 8. SHEATHING SUBFLOOR TO BE 5/8" OR 3/4" TONGUE AND GROOVE PLYWOOD OR OSB STURD-I-FLOOR AS SHOWN ON THE DRAWINGS. DIRECT BEARING AT ALL ENDS, GLUED AND NAILED. ROOF SHEATHING SHALL BE 1/2" CDX PLYWOOD OR 7/16" OSB. ALL END JOIST SHALL BE STAGGERED. THE FACE GRAIN SHALL BE LAID AT RIGHT ANGLES TO THE JOIST AND TRUSSES AND PARALLEL TO THE STUDS. EXTERIOR SHEATHING SHALL BE OSB OR PLYWOOD SHEATHING (APA rated STRUC. 1 24/16) INSTALL PER MANUFACTURERS SPECIFICATIONS UNLESS NOTED OTHERWISE
- 9. ALL STRUCTURAL WOOD BLOCKING, NAILERS, ETC., SHALL BE ATTACHED TO STEEL OR CONCRETE FRAMING WITH POWER ACTUATED FASTENERS OR 3/8" DIAMETER BOLTS UNLESS NOTED OTHERWISE. FASTENERS SHALL BE SPACED AT 24" MAXIMUM o.c. AND SHALL BE STAGGERED., FASTENERS SHALL HAVE A MINIMUM CAPACITY OF 100 POUNDS IN SHEAR AND PULLOUT UNLESS NOTED OTHERWISE.
- 10. PANEL BUTT JOINTS, PLATES AT FLOOR AND CEILING AND ALL WINDOW, DOOR FLANGES/ JAMBS SHALL BE GLUED AND SEALED PRIOR TO AND DURING ERECTION.

DIVISION 7 - THERMAL AND MOISTURE PROTECTION

- 1. SILL SEAL INSTALL COMPRESSIBLE SEAL BENEATH ALL EXTERIOR SILL PLATES.
- a. WALLS R-15, 3 1/2" BATT INSULATION WITH KRAFT PAPER FACE VAPOR BARRIER, MIN. UNLESS OTHERWISE NOTED. b. CEILINGS AT ROOF - R-30 FIBERGLASS BATT WITH KRAFT PAPER FACE VAPOR BARRIER,
- OR BLOWN INSULATION, R-30 MIN. OR PER LOCAL CODE. c. PERIMETER SLAB INSULATION TO BE RIGID, EXTERIOR GRADE, MIN. R-7 EXTENDING 2'-0" VERTICALLY AND 2'-0" HORIZONTALLY, MIN. PERIMETER INSULATION TO BE EXTRUDED POLYSTYRENE CLOSED CELL.
- d. VAPOR BARRIERS TO FACE WARM SIDE OF SPACE (INTERIOR) UNLESS OTHERWISE NOTED ON DRAWINGS.
- a. SHINGLES COMPOSITE SHINGLES ON 15# ROOFING FELT ON SLOPES OF 4" OR 12" OR GREATER. ON SLOPES 2" TO 12" UP TO 4" TO 12" PROVIDE DOUBLE LAYERS OF UNDERLAYMENT FELT PROTECTION IN ACCORDANCE WITH BUILDING CODE. SHINGLES SHALL BE INSTALLED PER MANUFACTURER'S SPECIFICATIONS AND APPLICABLE BUILDING CODES.
- b. ROOF VALLEY LINING SHALL BE OF APPROVED MATERIAL AND INSTALLED PER MANUFACTURER'S SPECIFICATIONS.
- 4. EXTERIOR WALLS:
- a. FLASHING FLASH AND COUNTERFLASH AT ROOF AND WALL INTERSECTIONS, VALLEYS, CRICKETS AND SADDLES, AND SIDEWALLS PER CODE. FLASHING AT VENT PIPERS, SOIL STACKS, VERTICAL FRONT WALLS TO BE APPLIED IN ACCORDANCE WITH MANUFACTURER'S PRINTED INSTRUCTIONS. FLASHING MATERIAL TO BE MIN. .019 CORROSION RESISTANT METAL, MINERAL SURFACED ROLL ROOFING, OR APPROVED EQUAL
- b. FLASH ALL EXTERIOR OPENINGS AND ALL BUILDING CORNERS AS REQUIRED. FLASH AND CAULK WOOD BEAMS AND OTHER PROJECTIONS THROUGH EXTERIOR WALLS AND ROOF
- c. CAULKING CAULKING SEALANTS AS SELECTED BY BUILDER (OWNER). FILL ALL JOINTS OF DIFFERENT MATERIALS AND ALL PENETRATIONS AS REQUIRED. d. SIDING - TO BE AS CALLED FOR ON DRAWINGS AND INSTALLED PER MANUFACTURER'S SPECIFICATIONS.

DIVISION 8 OPENINGS

- 1. EXTERIOR ENTRANCE DOORS SIDE HINGED DOOR NOT LESS THAN 3 FEET IN WIDTH AND 6'-8" IN HEIGHT. 1 3/4" SOLID CORE WOOD DOORS OR HOLLOW METAL MIN. 20 GAUGE FILLED WITH SOLID SLAB POLYSTYRENE INSULATION PERMANENTLY BONDED TO PANELS. PROVIDE 1 1/2 PAIR HINGES FOR DOORS UP TO 7'-2" AND 2 PAIR FOR DOORS TO 8'-0" IN HEIGHT. PROVIDE COMPLETE WEATHER STRIPPING AND METAL THRESHOLD.
- 3. WINDOWS AND GLASS DOORS:
- a. GENERAL TEMPERED GLASS SHALL BE USED IN ALL AREAS AS REQUIRED BY IRC. PROVIDE WINDOWS CONFORMING TO REQUIREMENTS OF BUILDING CODE FOR PERFORMANCE, TESTING AND LABELING. ANCHORAGE METHODS AND STRUCTURAL REQUIREMENTS. b. ALL OPERABLE WINDOWS - SHALL HAVE NONCORROSIVE SCREENS AND SASH LOCKS. SCREENS ARE PROVIDED TO PREVENT THE ENTRY OF INSECTS AND ARE NOT INTENDED TO PREVENT CHILDREN FOR FALLING OUT OF OPEN WINDOWS.
- 4. WEATHER PROOFING ALL SLIDING, SWINGING DOORS AND WINDOW OPENINGS TO THE EXTERIOR SHALL BE FULLY WEATHERSTRIPPED, CAULKED, GASKETED OR OTHERWISE TREATED TO LIMIT AIR INFILTRATION. DOORS AND WINDOWS SHALL MEET AIR INFILTRATION AND OTHER PERFORMANCE FACTORS AS REQUIRED BY THE CURRENT EDITION OF THE INTERNATIONAL ENERGY CONSERVATION CODE AND INTERNATIONAL RESIDENTIAL CODE.

DIVISION 9 FINISHES

- 1. GYPSUM, WALLBOARD SHALL BE INSTALLED IN ACCORDANCE WITH MANUFACTURER'S RECOMMENDATIONS AND SHALL MEET THE REQUIREMENTS OF ICC AND OTHER APPLICABLE CODES. TYPICAL INTERIOR PARTITIONS TO HAVE 1/2" TAPERED EDGE TAPED AND FINISHED.
- 2. CERAMIC TILE CERAMIC WALL TILES SHALL BE 4 1/4" x 4 1/4" GLAZED TILE, THIN SET APPLICATION ON WATER-RESISTANT GYPSUM BOARD AS REQUIRED BY CODE. CERAMIC FLOOR TILE SHALL BE 4 1/4" x 4 1/4" SLIP RESISTANT TILE. TILE COLOR AS SELECTED BY OWNER.
- 3. UNDERLAYMENT PROVIDE SUITABLE UNDERLAYMENT FOR CERAMIC TILE FLOORS PER MANUFACTURER'S INSTRUCTIONS.

DIVISION 22 PLUMBING

1. THE CURRENT NORTH CAROLINA PLUMBING CODE SHALL COVERN THE ERECTION, INSTALLATION, ALTERATION, REPAIRS, RELOCATION, REPLACEMENT, ADDITION TO, USE OR MAINTENANCE OF ELECTRICAL EQUIPMENT AND SYSTEMS. ELECTRICAL SYSTEMS AND EQUIPMENT SHALL BE CONSTRUCTED, INTSTALLED AND MAINTAINED IN ACCORDANCE WITH THE CURRENT VERSION OF THE NORTH CAROLINA PLUMBING CODE.

DIVISION 23 MECHANICAL


1. THE CURRENT NORTH CAROLINA MECHANICAL CODE SHALL COVERN THE ERECTION, INSTALLATION, ALTERATION, REPAIRS, RELOCATION, REPLACEMENT, ADDITION TO, USE OR MAINTENANCE OF ELECTRICAL EQUIPMENT AND SYSTEMS. ELECTRICAL SYSTEMS AND EQUIPMENT SHALL BE CONSTRUCTED, INTSTALLED AND MAINTAINED IN ACCORDANCE WITH THE CURRENT VERSION OF THE NORTH CAROLINA MECHANICAL CODE.

DIVISION 26 ELECTRICAL

1. THE CURRENT NORTH CAROLINA ELECTRICAL CODE SHALL COVERN THE ERECTION, INSTALLATION, ALTERATION, REPAIRS, RELOCATION, REPLACEMENT, ADDITION TO, USE OR MAINTENANCE OF ELECTRICAL EQUIPMENT AND SYSTEMS. ELECTRICAL SYSTEMS AND EQUIPMENT SHALL BE CONSTRUCTED, INTSTALLED AND MAINTAINED IN ACCORDANCE WITH THE CURRENT VERSION OF THE NORTH CAROLINA ELECTRICAL CODE.

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Date: Revision:

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DATE:	DRAWN BY:
4/26/2017	JAB
CALE:	PROJECT NO
	16.580
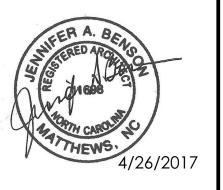
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SPECIFICATIONS

SHEET NUMBER: