

CHARLOTTE HISTORIC DISTRICT COMMISSION

CERTIFICATE OF APPROPRIATENESS

CERTIFICATE NUMBER: 2016-062

DATE: May 12, 2016

ADDRESS OF PROPERTY: 823 Lexington Avenue

TAX PARCEL NUMBER: 12305306

HISTORIC DISTRICT: Dilworth

OWNER(S): Geoffrey and Sarah Crume

DETAILS OF APPROVED PROJECT: The project is a second floor addition that includes a new gabled roof from front to rear, enlarged side gables and dormers on the side and rear elevations. New building height is approximately 21'-8" measured from finished floor. New siding material is wood lap, other trim details and windows will match existing.

The project was approved by the HDC May 11, 2016.

- > This Certificate of Appropriateness (COA) indicates that this project proposal has been determined to comply with the standards and policies of the Charlotte Historic District Commission.
- > Display the blue COA placard in a visible location along with any required permits.
- > No other approvals are to be inferred.
- > No demolition other than that specifically indicated on any attached plans is authorized under this approval.
- > All work must be completed in accordance with all other applicable state and local codes.
- > Any changes from or additions or deletions to the plans referenced herein will void this Certificate, and a new application must be filed with the Historic District Commission.

This Certificate is valid for a period of twelve (12) months from the date of issuance. Failure to obtain a building permit in that time will be considered as a failure to comply with the Certificate and the Certificate will become invalid. If a building permit is not required, then the approved work must be completed within twelve (12) months of the date of issuance of this Certificate. In either situation, the Certificate can be renewed for an additional twelve (12) months by Historic District Commission staff by written request within the first twelve (12) months from the date of issuance.

Ton Equ	John Gonal
Chairman	Staff

CHARLOTTE-MECKLENBURG PLANNING DEPARTMENT

www.charlotteplanning.org

600 East Fourth Street Charlotte, NC 28202-2853 PH: (704)-336-2205 FAX: (704)-336-5123





MODEROVIE


Cherlotte Historic District Commission

Conflicted of Appropriateness


2016-062

I hereby certify that this schematic drawing was prepared based on field—surveyed elevation measurements of the points shown hereon. This map is not intended to meet G.S. 47—30 recording requirements.

This _____, day of _____, 2016.

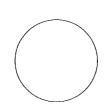

NON-CERTIFIED
REFER TO SIGNED & SEALED COPY
DATED April 6, 2016
Andrew G. Zoutewelle
Professional Land Surveyor
NC License No. L-3098

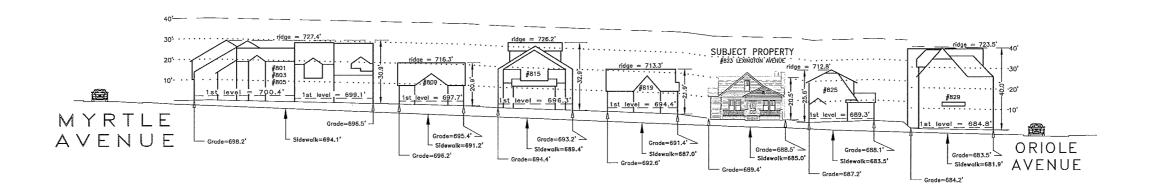

LEXINGTON AVENUE

A.G. ZOUTEWELLE SURVEYORS

1418 East Fifth St. Charlotte, NC 28204 Phone: 704-372-9444 Fax: 704-372-9555 Firm Licensure Number C-1054

Building Heights Sketch of 800 BLOCK of LEXINGTON AVENUE ODD SIDE-FACING NORTHEAST CHARLOTTE, MECKLENBURG COUNTY, N.C. for Charlotte-Mecklenburg Planning Department April 04, 2016

Scale 1" = 20'
0' 20' 40' 60' 80

General Notes:

1. The purpose of this Building Heights Sketch is to show existing building facade heights relative to the elevation points at the public sidewalk or top of curb, front yard grade ("Grade"), 1st level, and ridgeline of the houses depicted hereon. No rearyard or sideyard measurements were made. The heights shown hereon were derived from indirect measurements and are not intended for structural design.

2. The vertical datum for these elevation measurements is the North American Vertical Datum of 1988 (i.e., sea level). All other information and graphics are conceptual in nature and are not intended to represent accurate architectural or landscape features.

AN ADDITION AND RENOVATION FOR SARAH CURME
823 LEXINGTON AVE. CHARLOTTE, NC 28

NC 28203

SHEET NO

CE Studio,

ELEVATIONS

DATE: 05-02-16

A2


Certificate of Appropriateness 2016-062 9'-VE CLG HT 2ND FLOOR NEW MINDOW 0'-0' 1.0.5.F. 9'-1/2' TOP PLATE NEW NOON NEW MEMORS NEW WINDOW EXISTING MINDOWS EXISTING WINDOWS

> RIGHT SIDE ELEVATION SCALE : 1/4" = 1'-0"

FRONT ELEVATION SCALE : 1/4" = 1'-0"

REAR ELEVATION

SCALE : 1/4" = 1'-0"

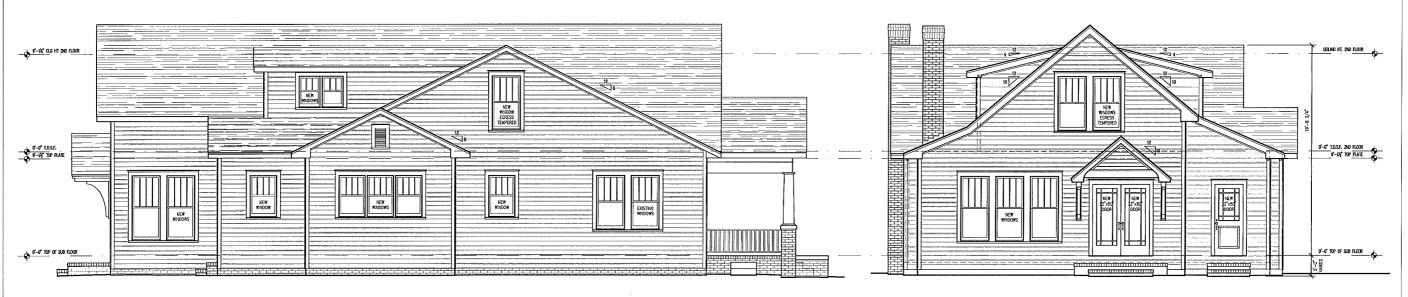

LEFT SIDE ELEVATION

SCALE : 1/4" = 1'-0"

