Charlotte Historic District Commission

Staff Review

HDC 2016-149

Application for a Certificate of Appropriateness

Date: August 10, 2016

PID# 11909814

LOCAL HISTORIC DISTRICT: Wilmore

PROPERTY ADDRESS: 300 West Park Avenue

SUMMARY OF REQUEST: New Construction and garage

APPLICANT: Robert and Kelly St. Louis/Liz Sheik

Details of Proposed Request

Existing Conditions

The existing site is a vacant corner parcel in an area with one and two story homes. The site is approximately 3 feet above the sidewalk, the lot size is 50' x 200'. Setbacks are consistent along the block. An alley exists behind the property. Houses on the block range in height from approximately 20'-5" to 30'-5".

Proposal

The proposal is a new single family house and detached garage. The height from grade is approximately 33'-3". Design features include cedar siding in the gables and brick foundation. The front porch is full width. The applicant is requesting the use of cementitious lap siding.

The detached garage is one story and will be accessed from the alley. Exterior materials will match the house.

Policy & Design Guidelines for New Construction, page 34

New construction in Local Historic Districts has an obligation to blend in with the historic character and scale of the Local Historic District in which it is located. Designs for infill projects and other new construction within designated Local Historic Districts must be designed with the surroundings in mind. The Historic District Commission will not specify a particular architectural style or design for new construction projects. The scale, mass and size of a building are often far more important than the decorative details applied. However, well designed stylistic and decorative elements, as well as building materials and landscaping, can give new construction projects the attributes necessary to blend in with the district, while creating a distinctive character for the building. New construction projects in Local Historic Districts must be appropriate to their surroundings.

The Historic District Commission will review the building details for all new construction as part of their evaluation of new construction project proposals.

<u>Staff Analysis</u> - The Commission will determine if the proposal meets the guidelines for garages/new construction.



Charlotte Historic District Commission


August 10, 2016

Application for Certificate of Appropriateness

300 W. Park Ave, Charlotte, NC 28203

The site is a vacant lot located on the corner of W. Park Avenue and Southwood Avenue. The lot is a rectangular lot that measures 50' across the front and back and is 200' deep. Adjacent properties are approximately 30' back from the sidewalk, and are a mix of 1.5 and 2 story craftsman style homes. The materials on the homes in the vicinity of the proposed property are Wood, Cement Fiberboard, and Vinyl.

We are proposing a two story home, with a bonus room in the attic. Placing the bonus room in the attic will add no additional height to the house and will look as if it is only a 2 story home. The home is 32′ 7″ tall and is comparable to 5 homes on W. Park Avenue. On the rear of the house will be a detached garage that will complement the craftsmen style of the home. The homeowners will use the existing ally drive to access the garage in order to preserve the natural yard-space between the home and the garage. Project details include; Wood windows and trim, Cement fiberboard siding, brick foundation, and brick bases for tapered columns.

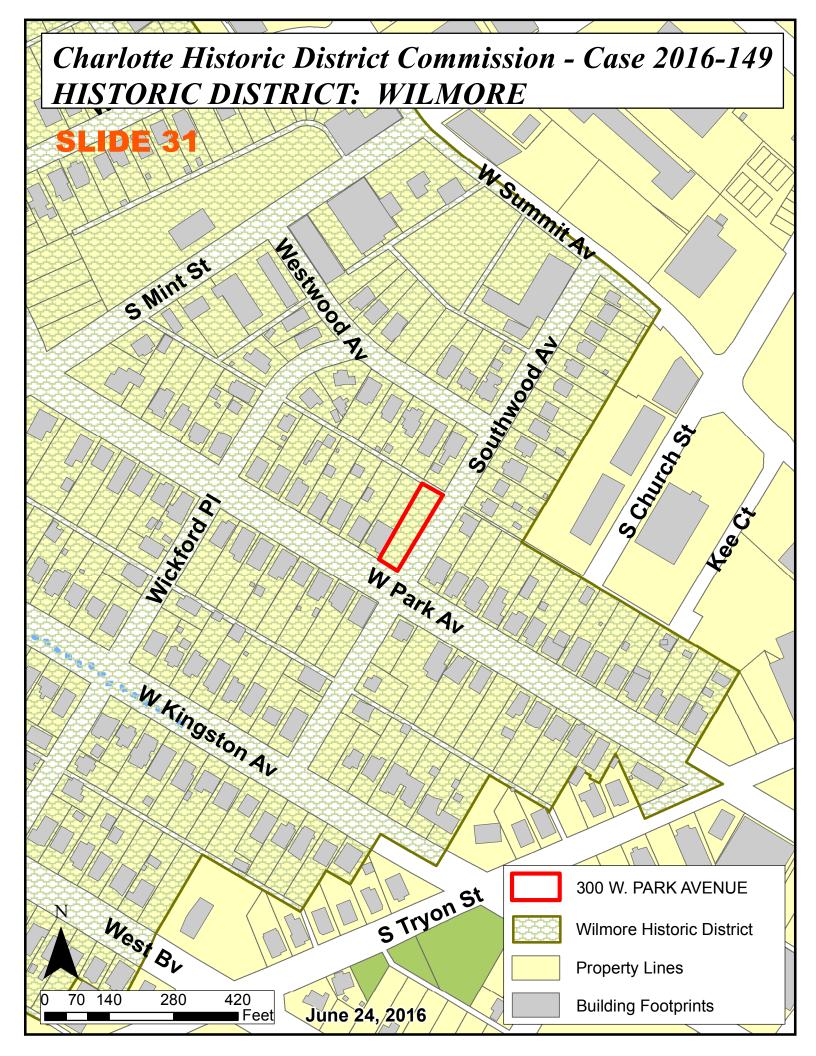



Side View of Lot – 200'




Corner View – Existing Stairs will be kept to maintain historic integrity

Stand at the top of the
Stairs looking towards
Back of the Property.



Standing on W Park Ave looking at Front of the lot.



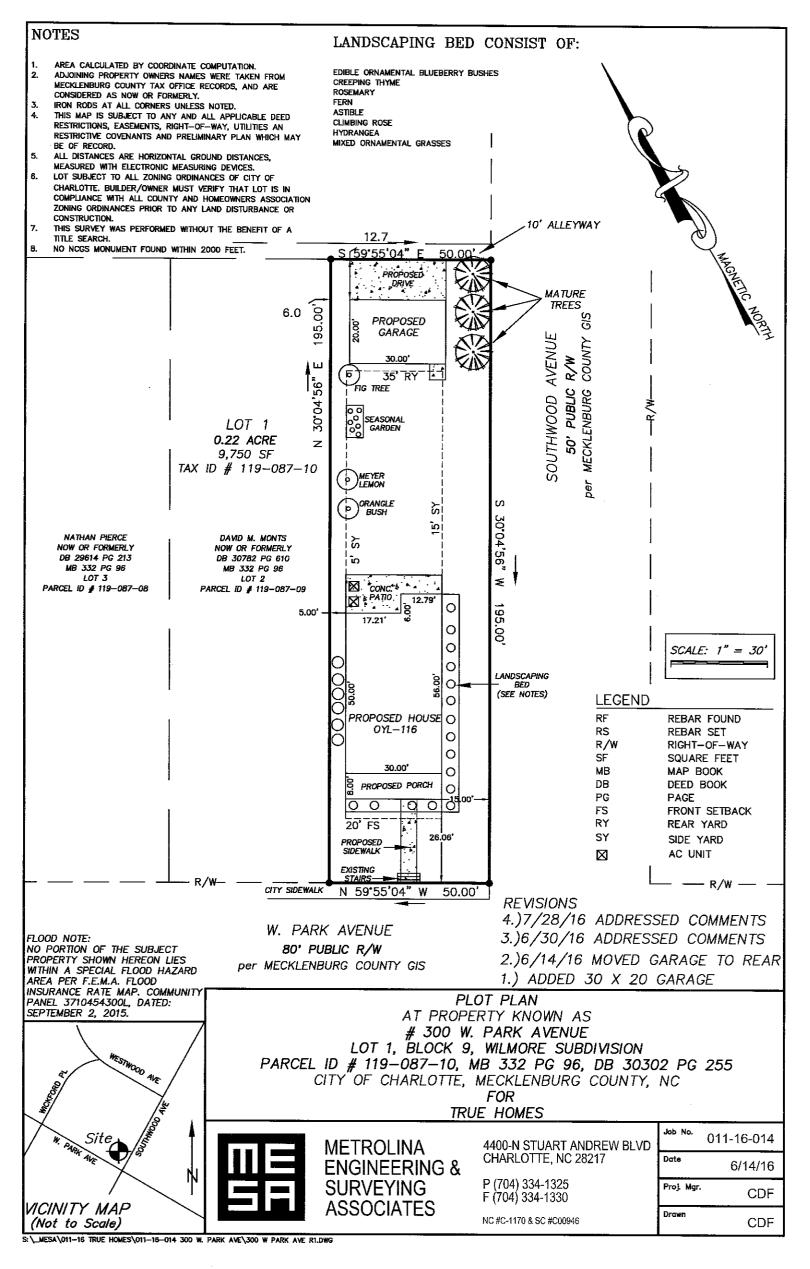





1) 1557 Wilmore Dr. Wood



3) 420 W Park Ave. Wood



2) 1600 Wilmore Dr. Wood



4) 421 W Park Ave. CFB



5) 412 W Park Ave. Wood 6) 255 W Park Ave. Wood






7) 235 W Park Ave. Wood



8) 245 W Park Ave. Wood

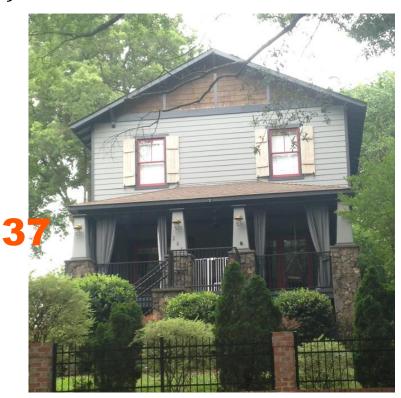

9) 401 W Kingston Ave. CFB



11) 417 W Kingston Ave. Wood



10) 409 W Kingston Ave. CFB





421 W Park Ave. CFB

420 W Park Ave. Wood

412 W Park Ave. Wood



417 W Kingston Ave. Wood




409 W Kingston Ave. CFB



Please see additional sheets for larger images

245 W Kingston Ave.

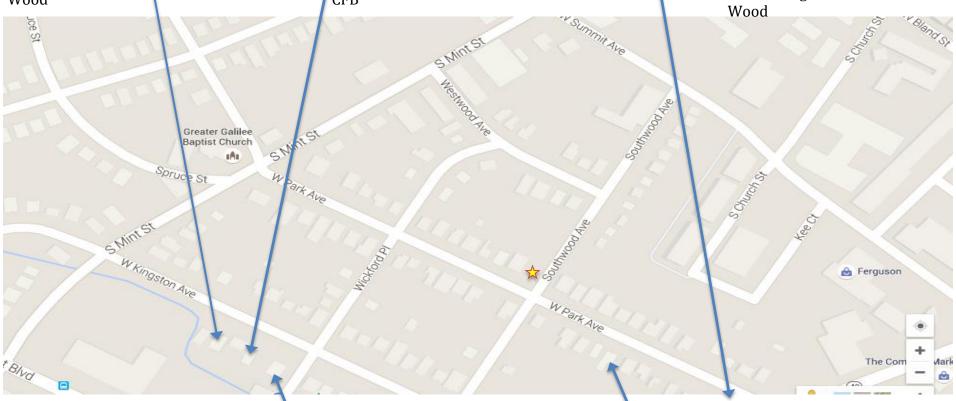





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TRADITIONS COLLECTION

ELECTRICAL LEGEND		GENERA	KEY NOTES	TABLE OF CONTENTS		
P EXT. CARRIAGE LIGHT	PLANS PERMITTED IN NORTH CAROLINA ARE DESIGNED TO MEET THE 2012	RATED. 6. ALL EXTERIOR WALLS # INTERIOR WALLS	13. WALLS TO BE FRAMED WITH STUDS AT	MEETING THE REQUIREMENTS OF ALL GOVERNING CODES AND PER	ELEVATIONS	CS COVER SHEET
OUTLET 220V	NORTH CAROLINA RESIDENTIAL BUILDING CODE, LATEST EDITION W/SEPT 2013	TO BE 2X4 STUDS 16" O.C. UNLESS NOTED OTHERWISE.	I 6" O.C. AT KITCHEN WALLS WITH CABINETS.	MANUFACTURER SPECS. 18. STAIR TREAD DESIGN TO BE VERIFIED	(0) CORNER TRIM (03) FLUSH RAKE	A2.1 FIRST FLOOR PLAN
OUTLET I I OV	AMENDMENTS, AS ISSUED BY THE STATE OF NORTH CAROLINA, AND PLANS	EXPOSED DIRECTLY TO THE WEATHER OR	14. ALL COMMON CEILING BETWEEN GARAGE TO HOUSE PROVIDE 5/8" TYPE X GWB	19. PROVIDE I 1/2" FLAT WALL FRAMING FOR	05 HORIZONTAL SIDING	A2.2 SECOND FLOOR PLAN
OUTLET 110V WATER PROOF	PERMITTED IN SOUTH CAROLINA DESIGNED TO MEET 2015 INTERNATIONAL RESIDENTIAL BUILDING	BEARING DIRECTLY ON MASONRY OR CONCRETE SHALL BE TREATED. ALL WOOD IN CONTACT WITH THE GROUND	PER GARAGE SEPARATION REQUIREMENTS PER IRC. ALL JOINTS TO BE TAPED \$ MUDDED FOR FIRE	ALL HVAC CHASES UNLESS NOTED OTHERWISE. SEE FRAMING SHEETS/CS2 FOR ADDITIONAL NOTES PER LOCAL	(0) BOARD-N-BATTEN SIDING (08) SCALLOPED SIDING	A3.1 FRONT \$ REAR ELEVATIONS A3.2 LEFT \$ RIGHT ELEVATIONS
OUTLET 1 1 OV GFI	CODE AS ISSUED BY THE STATE OF SOUTH CAROLINA, WITH MODIFICATIONS	MUST BE GROUND-CONTACT APPROVED. ALL WOOD EXPOSED DIRECTLY TO THE	SEPARATION. ALL STRUCTURES SUPPORTING FLOOR/CEILING	CODES. 20. FOR TRADITIONS, ELEMENTS, INTEGRITY,	(11) COMPOSITE SHINGLES	A4.1 STAIR SECTIONS
SWITCHED RECEPTACLE	AS REQUIRED TO MEET LOCAL BUILDING CODES FOR EACH APPLICABLE	WEATHER SHALL BE PROTECTED TO PREVENT THE OCCURRENCE OF ROT.	ASSEMBLIES USED FOR SEPARATION REQUIRE NOT LESS THAN \$\frac{1}{2}" GYP OR EQ.	AND TRIBUTE SERIES, DOORS SHOULD BE LOCATED 4" OFF ADJACENT WALLS	METAL ROOFING	EI.I FIRST FLOOR ELECTRICAL PLAN
PHONE	JURISDICTION. 2. DO NOT SCALE DIMENSIONS FROM	8. ALL ANGLED WALLS ARE AT 45 DEGREES UNLESS NOTED OTHERWISE.	S PER SECTION R302.6 OR CE 15. SEPARATE GARAGE FROM ATTIC WITH NOTED	OR CENTERED IN THE WALL UNLESS NOTED OTHERWISE. DESIGNER SERIES	(1) VINYL SHUTTER (1) TRIM BOARD AT OVERHEAD DOOR JAMB (20) BRICKMOLD TRIM (2) IX4 TRIM BOARD	E1.2 SECOND FLOOR ELECTRICAL PLAN
CO CO DETECTOR	PRINTS. USE DIMENSIONS GIVEN OR CONSULT PRODUCTION CAD DEPARTMENT FOR FURTHER	9. WINDOWS ARE LABELED AS NOMINAL SIZES. SEE SELECTIONS AND ROUGH	5/8" TYPE X GWB SCUTTLE MINIMUM AND 2X SCUTTLE FRAMING MATERIAL.	UNLESS NOTED OTHERWISE. 21. ALL HOMES TREATED WITH BORA-CARE TERMITE TREATMENT.		SI FOUNDATION PLAN
SMOKE DETECTOR	CLARIFICATION.	OPENING SCHEDULES FOR FRAMING SIZES. SEE ELEVATION PLAN FOR WINDOW HEADER HEIGHTS. 10. DIMENSIONS ARE FROM FACE OF STUDS. 11. PROVIDE BLOCKING ABOVE WINDOWS	16. HEEL HEIGHTS: SEE ELEVATIONS SHEETS FOR TOP OF FASCIA DIMENSIONS TO GATHER PROPER HEEL HEIGHT REQUIREMENTS. 17. PROVIDE AND INSTALL LOCALLY CERTIFIED SMOKE DETECTORS AND			52.1 FIRST FLOOR FRAMING
	ALL DIMENSIONS ARE FROM WALL FRAMING, NO FINISHED DIMENSIONS					52.2 FIRST FLOOR BRACED WALLS
\$ SWITCH	ARE GIVEN. 4. PROVIDE 2 STUDS BETWEEN ALL					53.1 ROOF FRAMING PLAN
\$ 3-way switch	WINDOWS. 5. ACCESS DOORS BETWEEN HOUSE AND	AND DOORS 16" O.C. 12. PROVIDE EXTRA STUDS AS INDICATED AT	CARBON MONOXIDE DETECTORS AS REQUIRED BY NATIONAL FIRE		123 IXG TRIM BOARD	53.2 SECOND FLOOR BRACED WALLS
\$ 4-WAY SWITCH	GARAGE AREAS TO BE 20-MINUTE FIRE	BEAM BEARING LOCATIONS.	PROTECTION ASSOCIATION AND		(25) I X8 TRIM BOARD (26) SYNTHETIC CROSS HEAD	GN GENERAL STRUCTURAL NOTES
\$ SPEAKER SWITCH	INTERIOR HINGED	KING / JACK	HEADER		27 I X4 FRIEZE TRIM BOARD	AN AREA NOTES
THERMOSTAT	DOOR SCHEDULE DOOR WIDTH DOOR HEIGHT R.O.	SCHEDULE	SCHEDULE	SQUARE FOOTAGE	IXG" SPRUCE FASCIA W/ COIL WRAP \$ VINYL SOFFIT	DI TYP. FOUNDATION DETAILS
□ CABLE TV	PLAN R.O. 8FT 9FT LOFT I.D. WIDTH CEILING CEILING CEILING	(2) JACK STUDS (1) JACK STUD \$ (1) KING STUD	HEADERS SHALL BE AS SHOWN UNLESS NOTED DIFFERENTLY ON PLANS:	FIRST FLOOR 1578 SQ.FT. SECOND FLOOR 1578 SQ.FT.	(3) I - I/2" THICK STONE CAP (33) 5" FACE BRICK VENEER	D1.1 TYP. HOLDOWN DETAILS D2 TYP FRAMING DETAILS
CEILING LIGHT	1/4 1'-6" (2/1	(1) JACK STUD \$ (2) KING STUDS	A. INTERIOR BEARING AND ALL EXTERIOR WALLS.	THIRD FLOOR 438 SQ.FT.	(135) ROWLOCK SILL (137) BRICK JACK ARCH	D2.2 TYP FRAMING DETAILS
CFT COMPACT FLUORESCENT LIGHT	1/8 1-10" 4 4 4	(1) JACK STUD # (2) KING STUDS	I. SPANS UP TO 2'6" (2)2X6'S 2. SPANS 2'6" TO 3'6" (2)2X8'S	TOTAL LIVABLE 3718 SQ.FT.	39 SOLDIER COURSE	D2.3 TYP FRAMING DETAILS
GU24 SOCKET	2/O 2'-2"	(2) JACK STUDS \$ (1) KING STUD	3. SPANS 3'6" TO 6'6" (2)2X I 0'5 4. SPANS 6'6" OR MORE SEE PLAN		(14) PRECAST KEYSTONE (143) THIN-SET STONE VENEER	D2.4 TYP FRAMING DETAILS
(J) JUNCTION LIGHT	2/4 2'-6" 2/6 2'-10" 2/8 2'-	(2) JACK STUDS \$ (2) KING STUDS				D3 TYP FLASHING DETAIL
(5) SPEAKER	2/8 2,10, 200 H H SOOR H H SOO	(2) JACK STUDS \$ (3) KING STUDS			1	D4 TYP. PORTAL FRAME DETAIL - PFH
EXHAUST FAN	2/10 3'-0"	(3) JACK STUDS \$ (3) KING STUDS				D4.1 TYP. UL RATED WALL @ PROPERTY LINE
EXHAUST FAN / LIGHT	2/10 3'-0"	(4) JACK STUDS \$ (4) KING STUDS				D5 TYP FIREPLACE DETAILS
FLOOD LIGHT	5/0 5'-2"					D5.1 TYP STAIR DETAILS
► UNDER CABINET LIGHT	G/O G'-2" S S S S S S S S S					DG TYP SCREEN PORCH DETAILS
Ризн виттом	<u> </u>					D7 TYP. DECK DETAILS
	INTERIOR PASS THRU SCHEDULE	POST SCHEDULE				D8 TYP WALL FRAMING DETAILS
ELECTRIC PANEL	FRAMED OPENING DIMENSIONS	2x4 STUDS 2x6 STUDS				D9 TYP CORNICE DETAILS
CAN LIGHT	WALL HEIGHT R.O. WIDTH R.O. HEIGHT	EX: (2) 2X4 2 EX: (2) 2X6				DIO TRIM DETAILS
MINI-CAN LIGHT	8'-1 1/8" PLAN I.D. +2" 82-1/2"				1	REVISION LOG
PENDANT LIGHT	9'-1 1/8" PLAN I.D. +2" 94-1/2" - 10'-1 1/8" PLAN I.D. +2" 98-1/2"	NUMBER INSIDE CALLOUT INDICATES TOTAL NUMBER OF STUDS.	SLIDE 41			I. DATE: DRAWN BY:
CEILING FAN PRE-WIRE	ROUGH OPENING HEIGHTS ARE FOR DO, CO, \$ AO OPENINGS. SHIM HEIGHTS AS NEEDED TO MATCH INTERIOR HINGED DOOR CASING INTERIOR DOORWAY OPENINGS: DO = DRYWALL OPENING	4X4 POST P GX6 POST		_		2. DATE: DRAWN BY: 3. DATE: DRAWN BY:
ELECTRICAL TO BE PLACED PER CODE IN THE FIELD.	CO = CASED OPENING AO = ARCHED OPENING	LETTER 'P' INSIDE CALLOUT INDICATES A SOLID 4x4 or 6x6 POST				


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07-4-16 SCALE: NOT TO SCALE

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RIGHT ELEVATION

TOP OF WALL

FINISH FLOOR TOP OF WALL

FINISH FLOOR

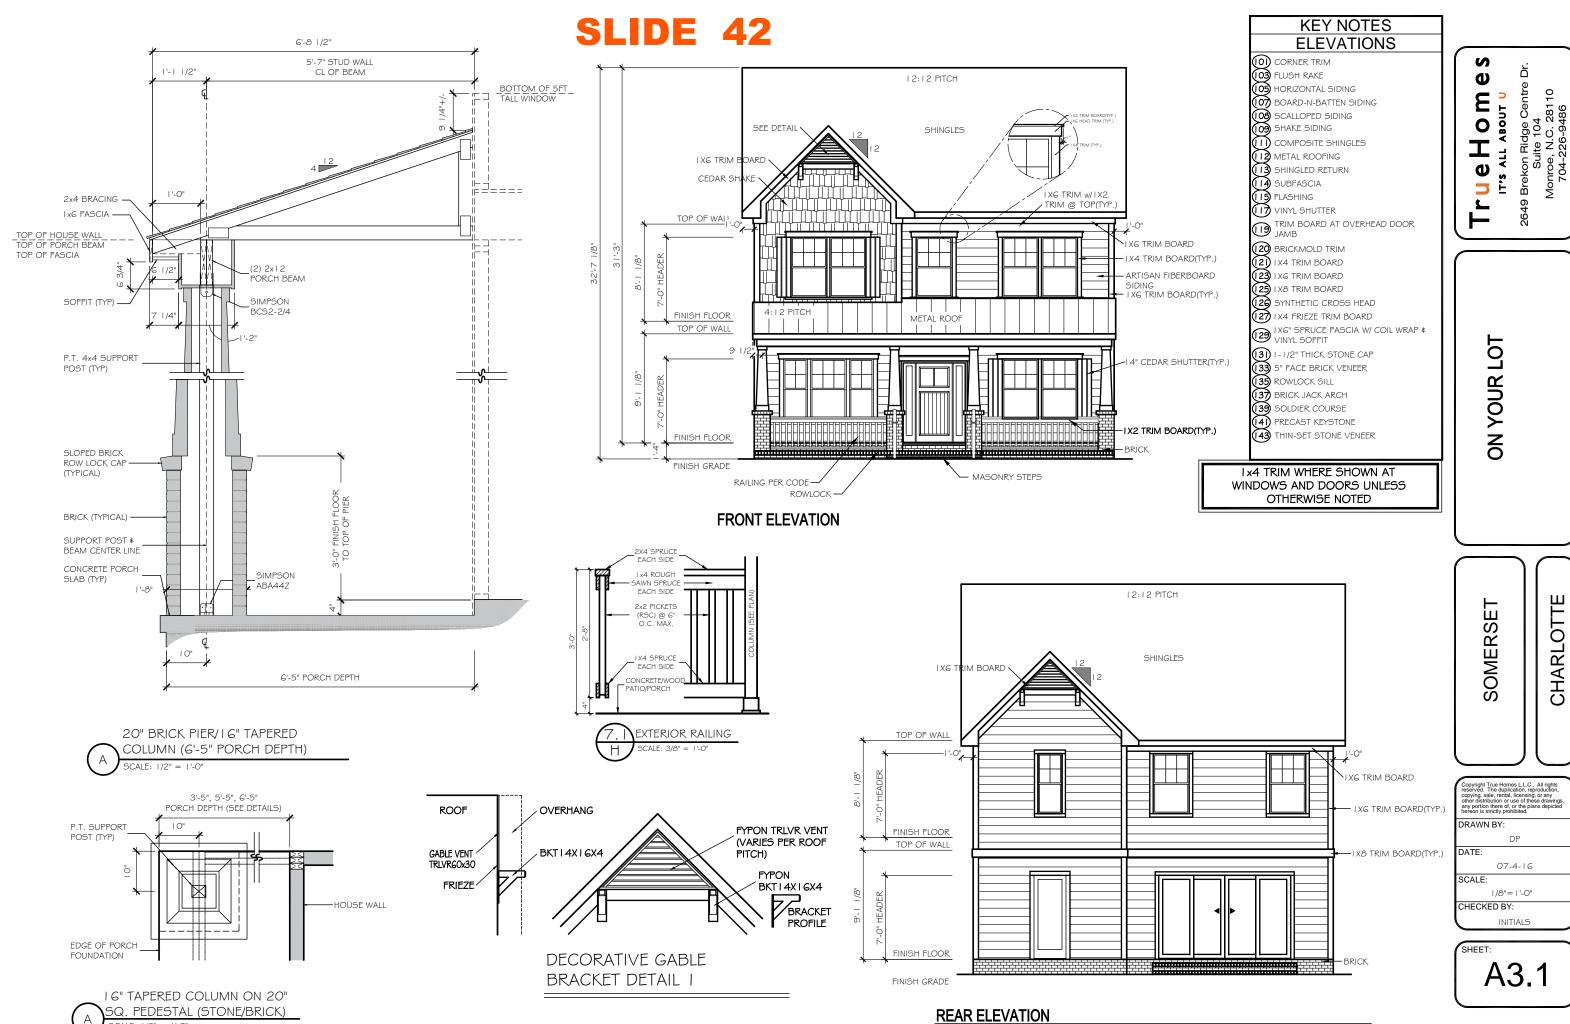FINISH GRADE

IX8 TRIM BOARD(TYP.) -

IX6 TRIM BOARD IXG TRIM -

BOARD(TYP.)

SCALE: 1/8" = 1'-0"



BRICK-

BRICK —

12:12 PITCH

SHINGLES

LEFT ELEVATION SCALE: 1/8" = 1'-0"

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KEY NOTES

12:12 PITCH

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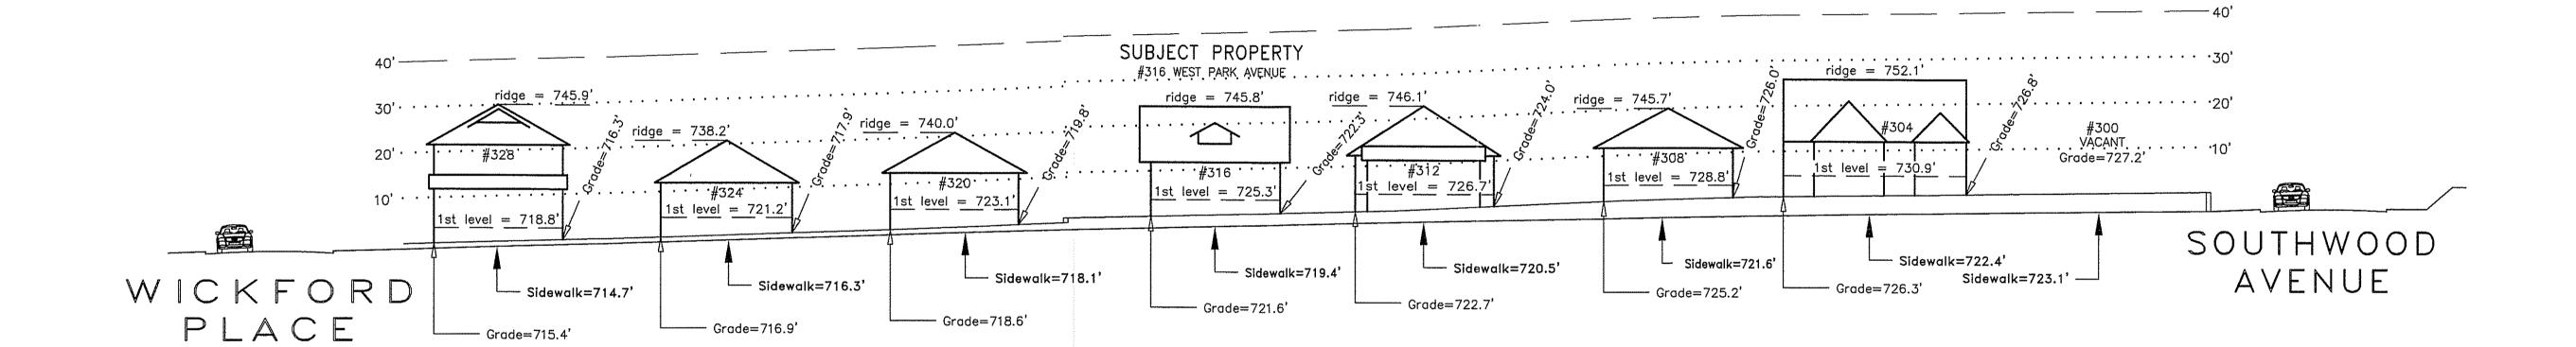
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I hereby certify that this schematic drawing was prepared based on field—surveyed elevation measurements of the points shown hereon. This map is not intended to meet G.S. 47—30 recording requirements.

This 5th day of March, 2015.



Andrew G. Zoutewelle
Professional Land Surveyor
NC License No. L-3098



WEST PARK AVENUE

A.G. ZOUTEWELLE SURVEYORS

1418 East Fifth St. Charlotte, NC 28204
Phone: 704-372-9444 Fax: 704-372-9555
Firm Licensure Number C-1054

Building Heights Sketch of

300 BLOCK of WEST PARK AVENUE

FACING NORTHEAST

CHARLOTTE, MECKLENBURG COUNTY, N.C.

for Charlotte-Mecklenburg Planning Department
March 04, 2015

1. The purpose of this Building Heights Sketch is to show existing building facade heights relative to the elevation points at the public sidewalk, front yard grade ("Grade"), 1st level, and ridgeline of the houses depicted hereon. No rearyard or sideyard measurements were made. The heights shown hereon were derived from indirect measurements and are not intended for structural design.

2. The vertical datum for these elevation measurements is the North

General Notes:


American Vertical Datum of 1988 (i.e., sea level). All other information and graphics are conceptual in nature and are not intended to represent accurate architectural or landscape features.

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This Ste day of March 2015.



Andrew G Zoutewelle Professional Land Surveyor NC License No L-3098

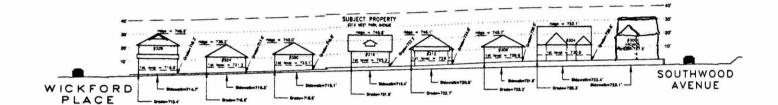


WEST PARK AVENUE

A.G. ZOUTEWELLE
SURVEYORS
1418 East Fifth St. Charlotte, NC 28204
Phone: 704-372-9544 Fax 704-372-9555
Firm Licensure Number C-1054

Building Heights Sketch of 300 BLOCK of WEST PARK AVENUE FACING NORTHEAST


CHARLOTTE, MECKLENBURG COUNTY, N.C. for Charlotte-Mecklenburg Planning Department March 04, 2015

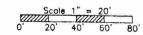



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The vertical datum for these elevation measurements is the North Merican Vertical Datum of 1988 (i.e., sea level). All other information and graphics are conceptual in nature and are not intended to apresent accurate architectural or Indiacope features.





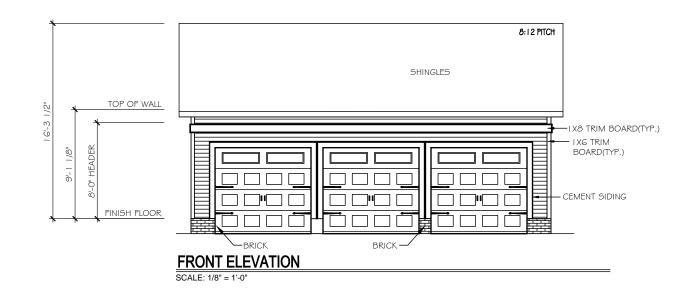

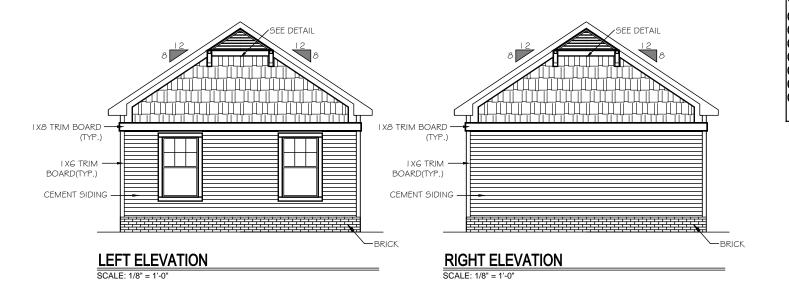KEY NOTES **ELEVATIONS** CORNER TRIM CORNE

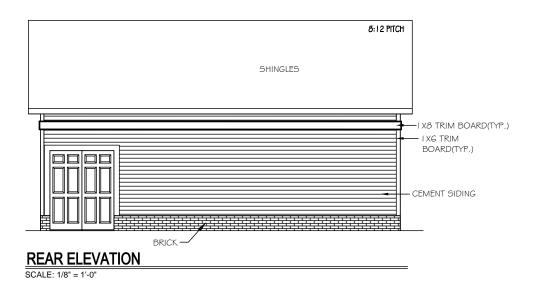TRIM BOARD AT OVERHEAD DOOR JAMB

JAMB

(2) BRICKMOLD TRIM
(2) IX4 TRIM BOARD
(23) IX6 TRIM BOARD
(25) IX8 TRIM BOARD
(26) SYNTHETIC CROSS HEAD
(27) IX4 FRIEZE TRIM BOARD

I XG" SPRUCE FASCIA W/ COIL WRAP & VINYL SOFFIT

VINYL SOFFII

(3) I - I / 2" THICK STONE CAP
(33) 5" FACE BRICK VENEER
(33) ROWLOCK SILL
(37) BRICK JACK ARCH
(33) SOLDIER COURSE
(44) PRECAST KEYSTONE
(43) THIN-SET STONE VENEER

ON YOUR LOT

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SCALE: 1/8"=1'-0"

CHECKED BY: INITIALS

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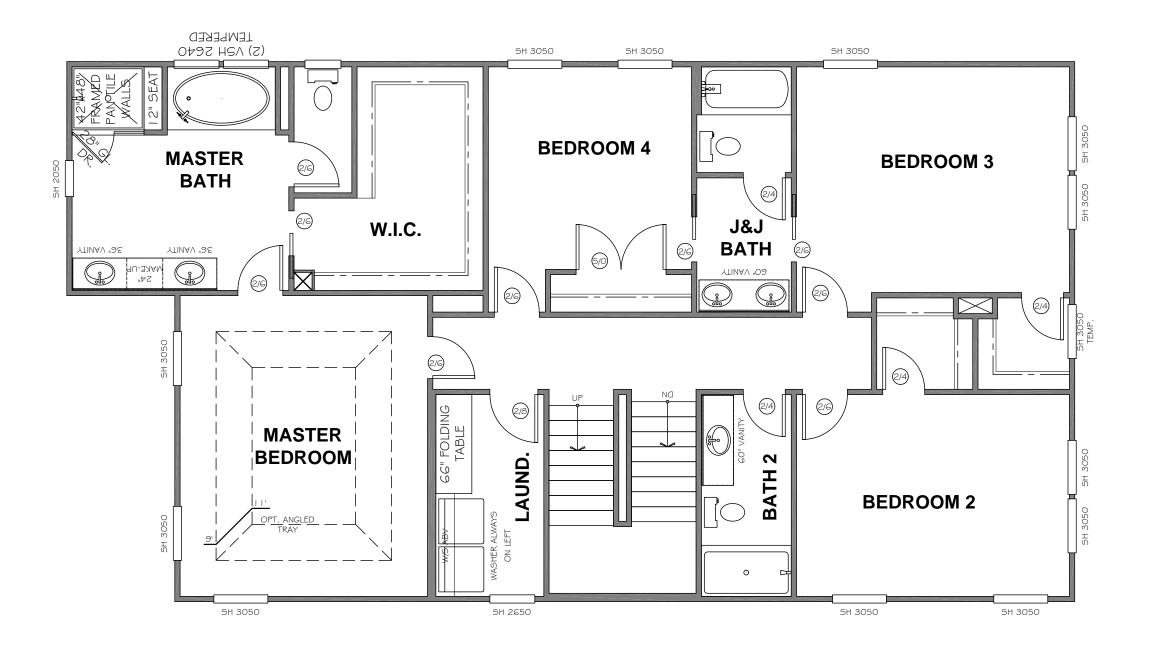
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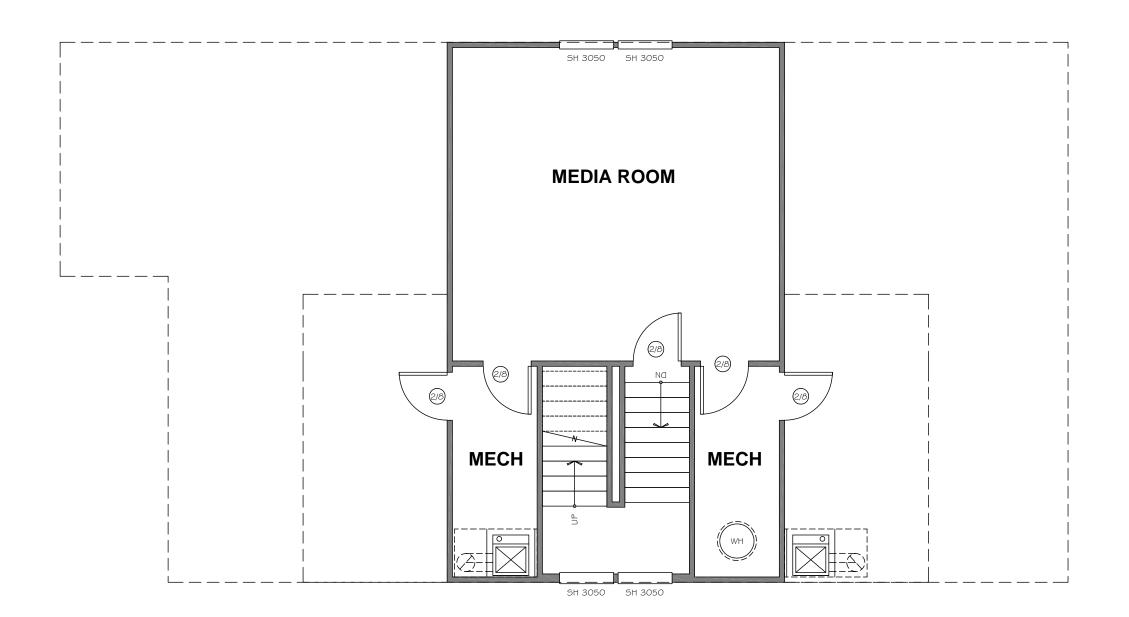
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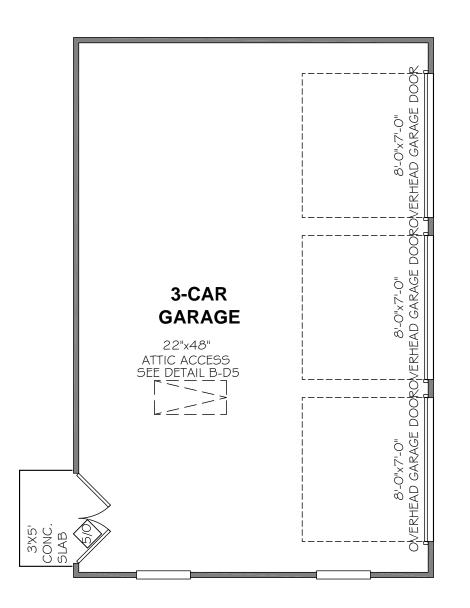
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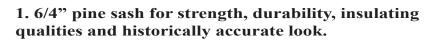
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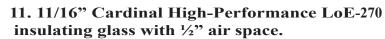


TRIM CORP Albany Ga. 229-432-2322 866-432-2822

Standard Features



- 2. Treated with WoodLife®111 water repellent and wood preservative for long life.
- 3. Exteriors are factory-primed and ready for painting.
- 4. Thicker mortise and tenon joint. (Resists cracking)
- 5. Deeper shoulder for thicker S.D.L. bar.
- 6. Natural wood interiors ready for painting or staining.
- 7. Continuous routed finger lift for easy operation.
- 8. Sash screwed together with 2-1/4" screws for strength, durability and cleaner look. (No staple holes in face of sash)
- 9. Boot Glazed, reglazable in minutes, cuts down stress cracks.
- 10. Sash and Boot with weep holes to get condensation out of sash for long life



- 12. Foam-filled bulb weather stripping with three adjustments for a weather tight fit.
- 13. Dual action sash lock with adjustable keeper. Security and enhanced performance.
- 14. Insulated jamb-liners with spring covers, bridged back and adjustable springs. Smooth raise/lower and weather tight fit.
- 15. Tilt-in removable top and bottom sash for easy cleaning.
- 16. One piece 4-9/16" jambs for better strength and performance. (Not pieced together)
- 17. Low-maintenance rot-proof, sill, blind stop and brickmould.
- 18. Brickmould grooved for easy screen installation.
- 19. Double-hung windows designed to be factory-combined with other Tucker Door products. (Transom, Elliptical, Segment and Round-Top windows)







Albany Ga. 229-432-2322

866-432-2822






Optional Features

- All Natural Pine exterior and interior for staining inside and out.
- White or tan colored jamb-liners. White or bronze sash locks.
- S.D.L Options 7/8" 1-1/8" and 7/8" Putty Bars
- · G.B.G Bars
- Factory-applied exterior casing. 5/4x4 flat casing, 5/4x6 flat casing, 1x4 backband.
- Factory-applied extension jambs.
- Cardinal Glass LoE-366, (LoE-240 Glare Control) all available with Argon gas.
- Custom sizes.

Sash Replacment

- Improve Energy Efficiency While updating Your Curb
- Easy Installation. Sash kit takes about 20 minutes to install



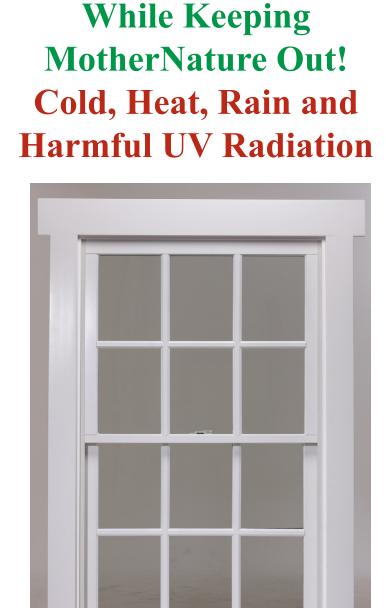

Let The Beauty

Of The World In

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		Data			
		U Value	SHGC	VLT	CR
NFRC	LOW-E	0.33	0.27	0.51	54
lational Fenestration	LOW-E	0.30	0.27	0.51	57
CERTIFIED	Argon			(6-24-1	0SJSH)