Charlotte Historic District Commission

Staff Review HDC 2016-086 Application for a Certificate of Appropriateness

Date: May 11, 2016

PID# 07102333

LOCAL HISTORIC DISTRICT: Wesley Heights

PROPERTY ADDRESS: 604 South Summit Avenue

SUMMARY OF REQUEST: Addition of more than 25% of original structure, mature tree removal

APPLICANT: Jason and Emily Clark

Details of Proposed Request

Existing Conditions

The existing structure is a one story Cottage style house constructed in 1937. It is listed as a contributing structure in the Wesley Heights National Register of Historic Places. Adjacent structures are a mix of one and two story homes.

Proposal

The proposal is a rear addition that is not visible from public right of way. The project requires the removal a small storage area and porch on the rear. Siding, windows and trim details with match the existing house in material and size. Two mature trees will be removed to accommodate the addition.

Policy & Design Guidelines for Additions, page 36

Additions to existing structures in Local Historic Districts have a responsibility to complement the original structure. Additions should reflect the design, scale and architectural style of the original structure. The following guidelines are intended to encourage addition designs that are compatible with the existing structure, while not fully mimicking the original design.

All additions will be reviewed for compatibility by the following criteria:					
a. Size	the relationship of the project to its site				
b. Scale	the relationship of the building to those around it				
c. Massing	the relationship of the building's various parts to each other				
d. Fenestration	the placement, style and materials of windows and doors				
e. Rhythm	the relationship of fenestration, recesses and projections				
f. Setback	in relation to setback of immediate surroundings				
g. Materials	proper historic materials or approved substitutes				
h. Context	the overall relationship of the project to its surroundings				

- 2. Additions must respect the original character of the property, but must be distinguishable from the original construction.
- 3. All additions to the front or side of existing properties must be of a design that is sensitive to the character and massing of the existing structure.

4. Additions to the front or side of existing structures that are substantially visible from a street must go before the full Commission.

<u>Staff Analysis:</u> The Commission will determine if the proposed improvements meet the design guidelines for size, scale, massing, fenestration, rhythm, materials and context.



HOME ADDITION for JASON & EMILY CLARK

CHARLOTTE, NORTH CAROLINA

OWNER:

JASON & EMILY CLARK 604 South Summit Avenue Charlotte, NC 28208 704-806-3387

DRAWING SCHEDULE:

IN0.0 COVER SHEET

IN1.0 SITE PLAN, EXISTING & NEW

N2.0 DEMOLITION & NEW CONSTRUCTION

IN3.0 NEW ROOF PLAN, DEMO & NEW

IN4.0 SCHEDULES

IN5.0 EXTERIOR ELEVATIONS, EXISTING


IN6.0 EXTERIOR ELEVATIONS, NEW

IN7.0 FURNITURE PLAN

PROJECT CONTACTS

TRADE	NAME	CONTACT	LOCATION
Contractor	M. Pete, Inc. Pete Mangum	704-614-8017 Mpeteinc@aol.com	Charlotte, NC
Designer	LiveSmart Design, LLC Carolyn Cook	980-213-1911 carolyn@livesmartdesign.com	Charlotte, NC

SITE LOCATION

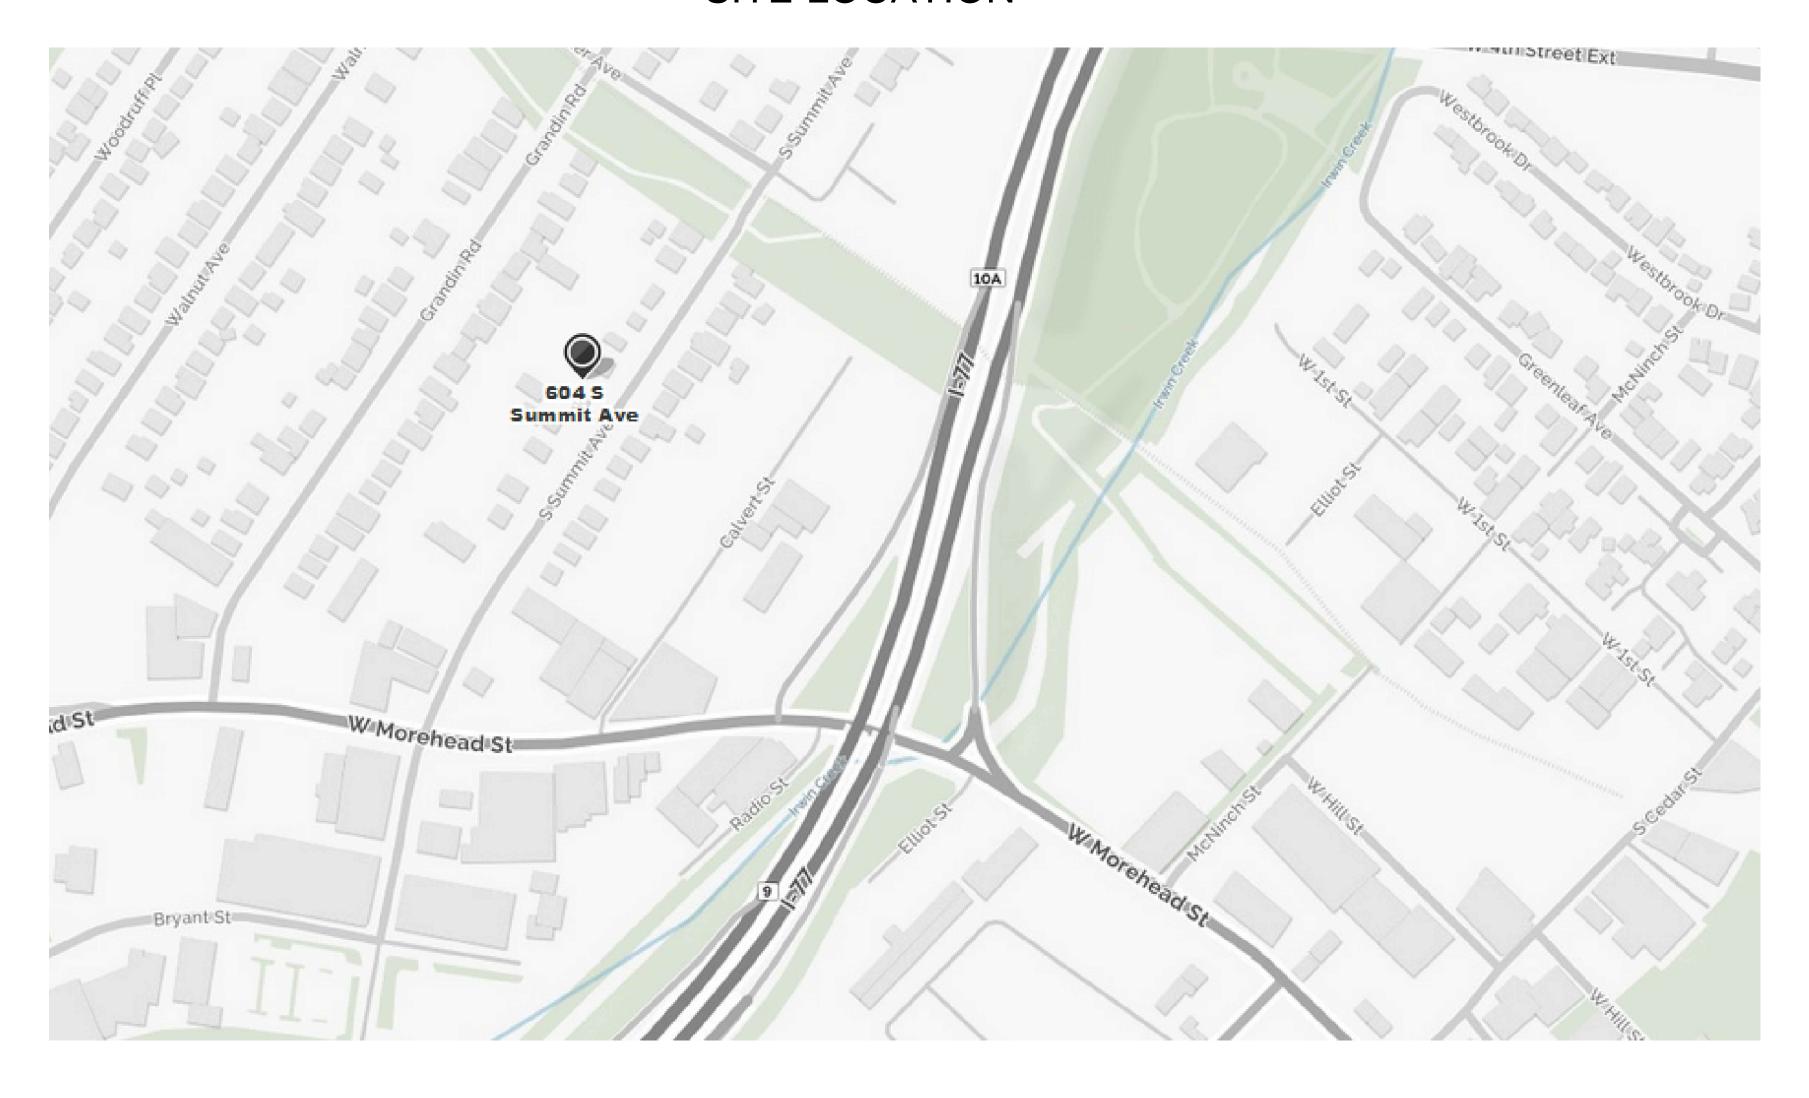

LiveSmart Design Charlotte, NC 28205 C: 980-213-1911 Project No: 186

Date: 4/11/16












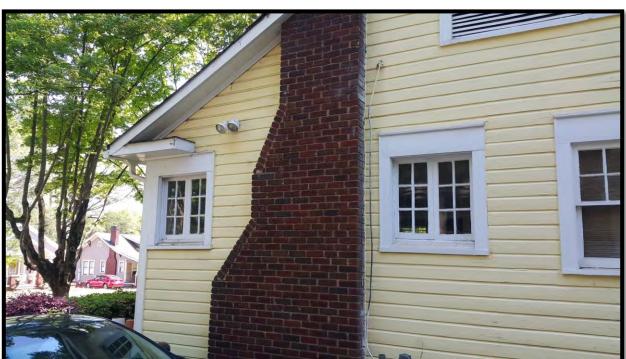



















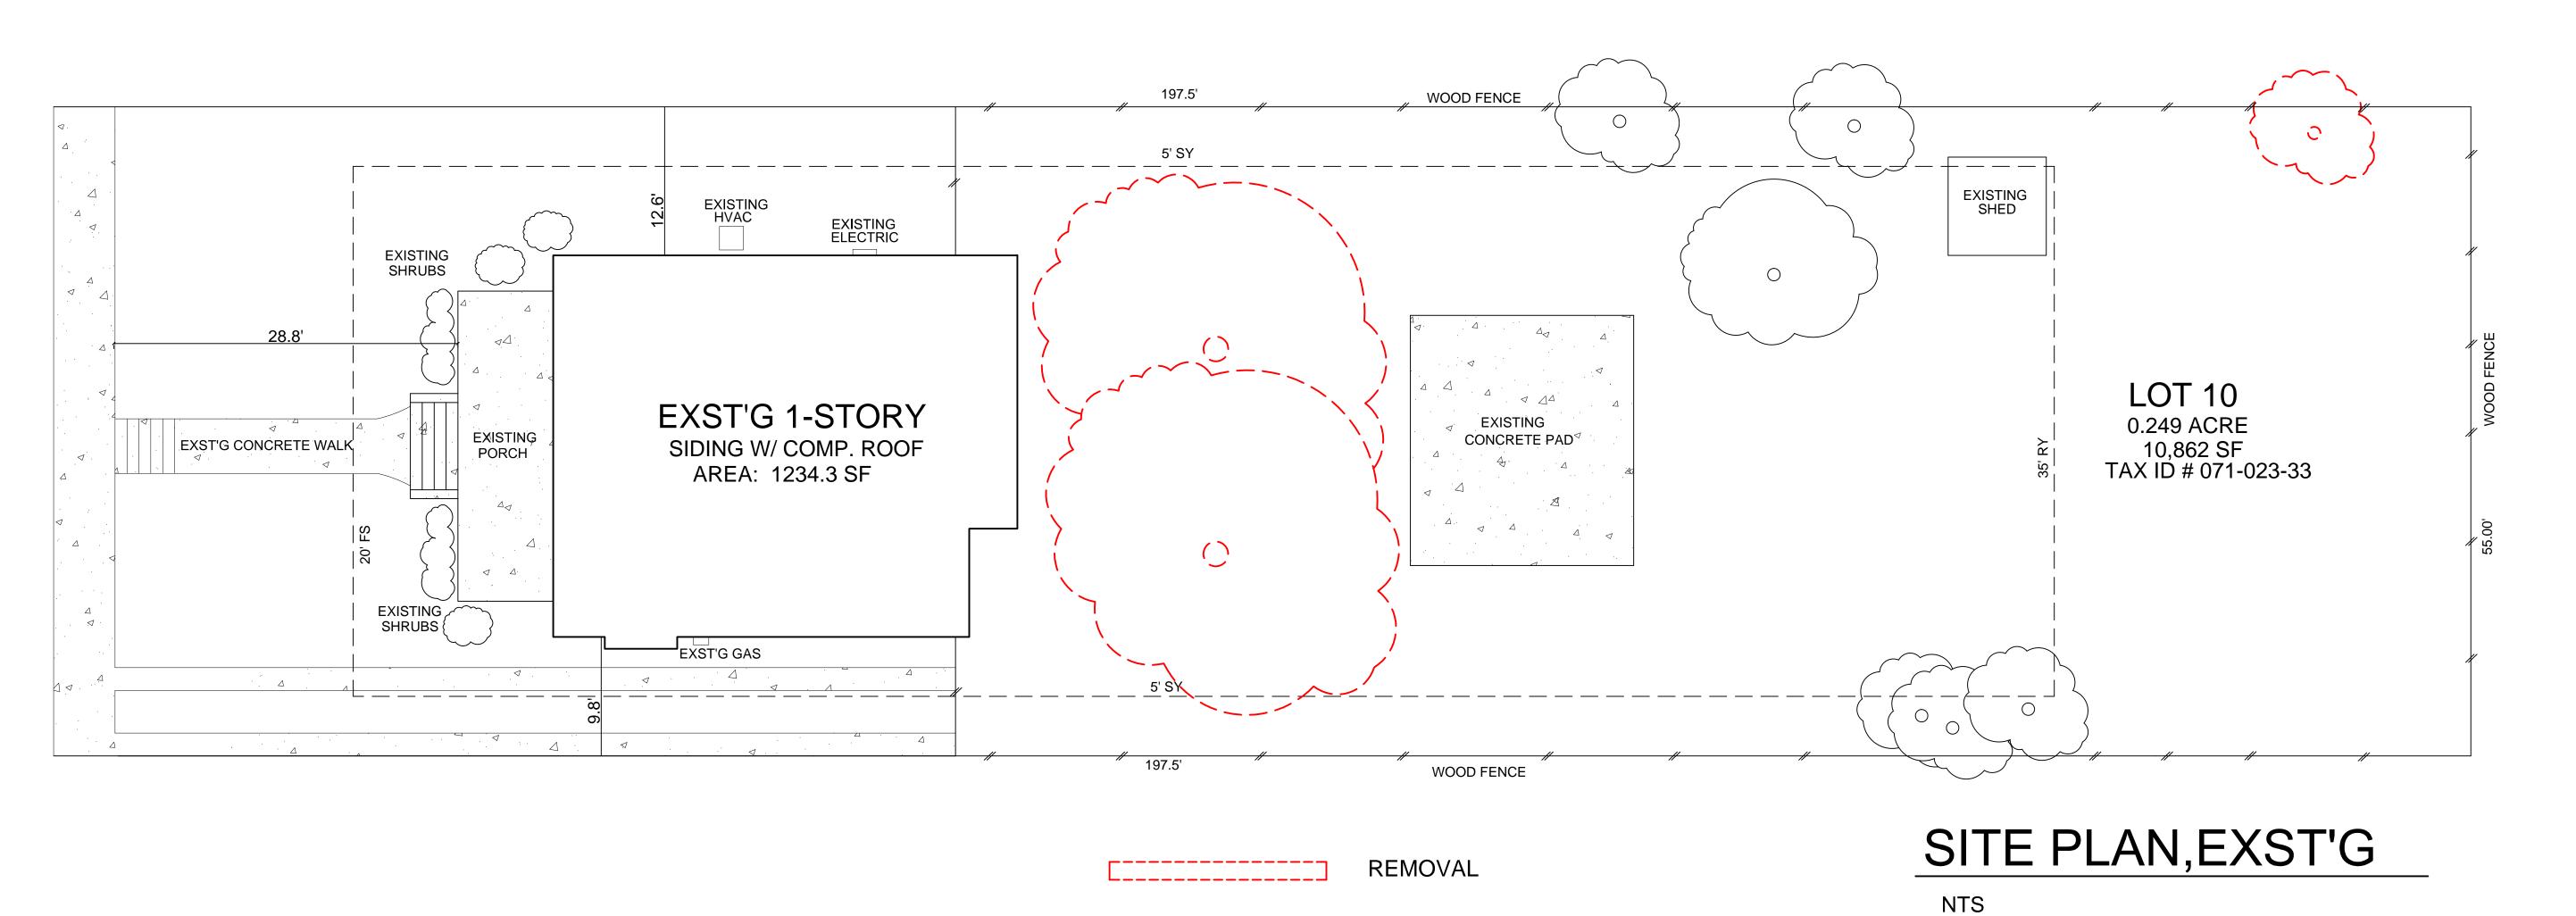

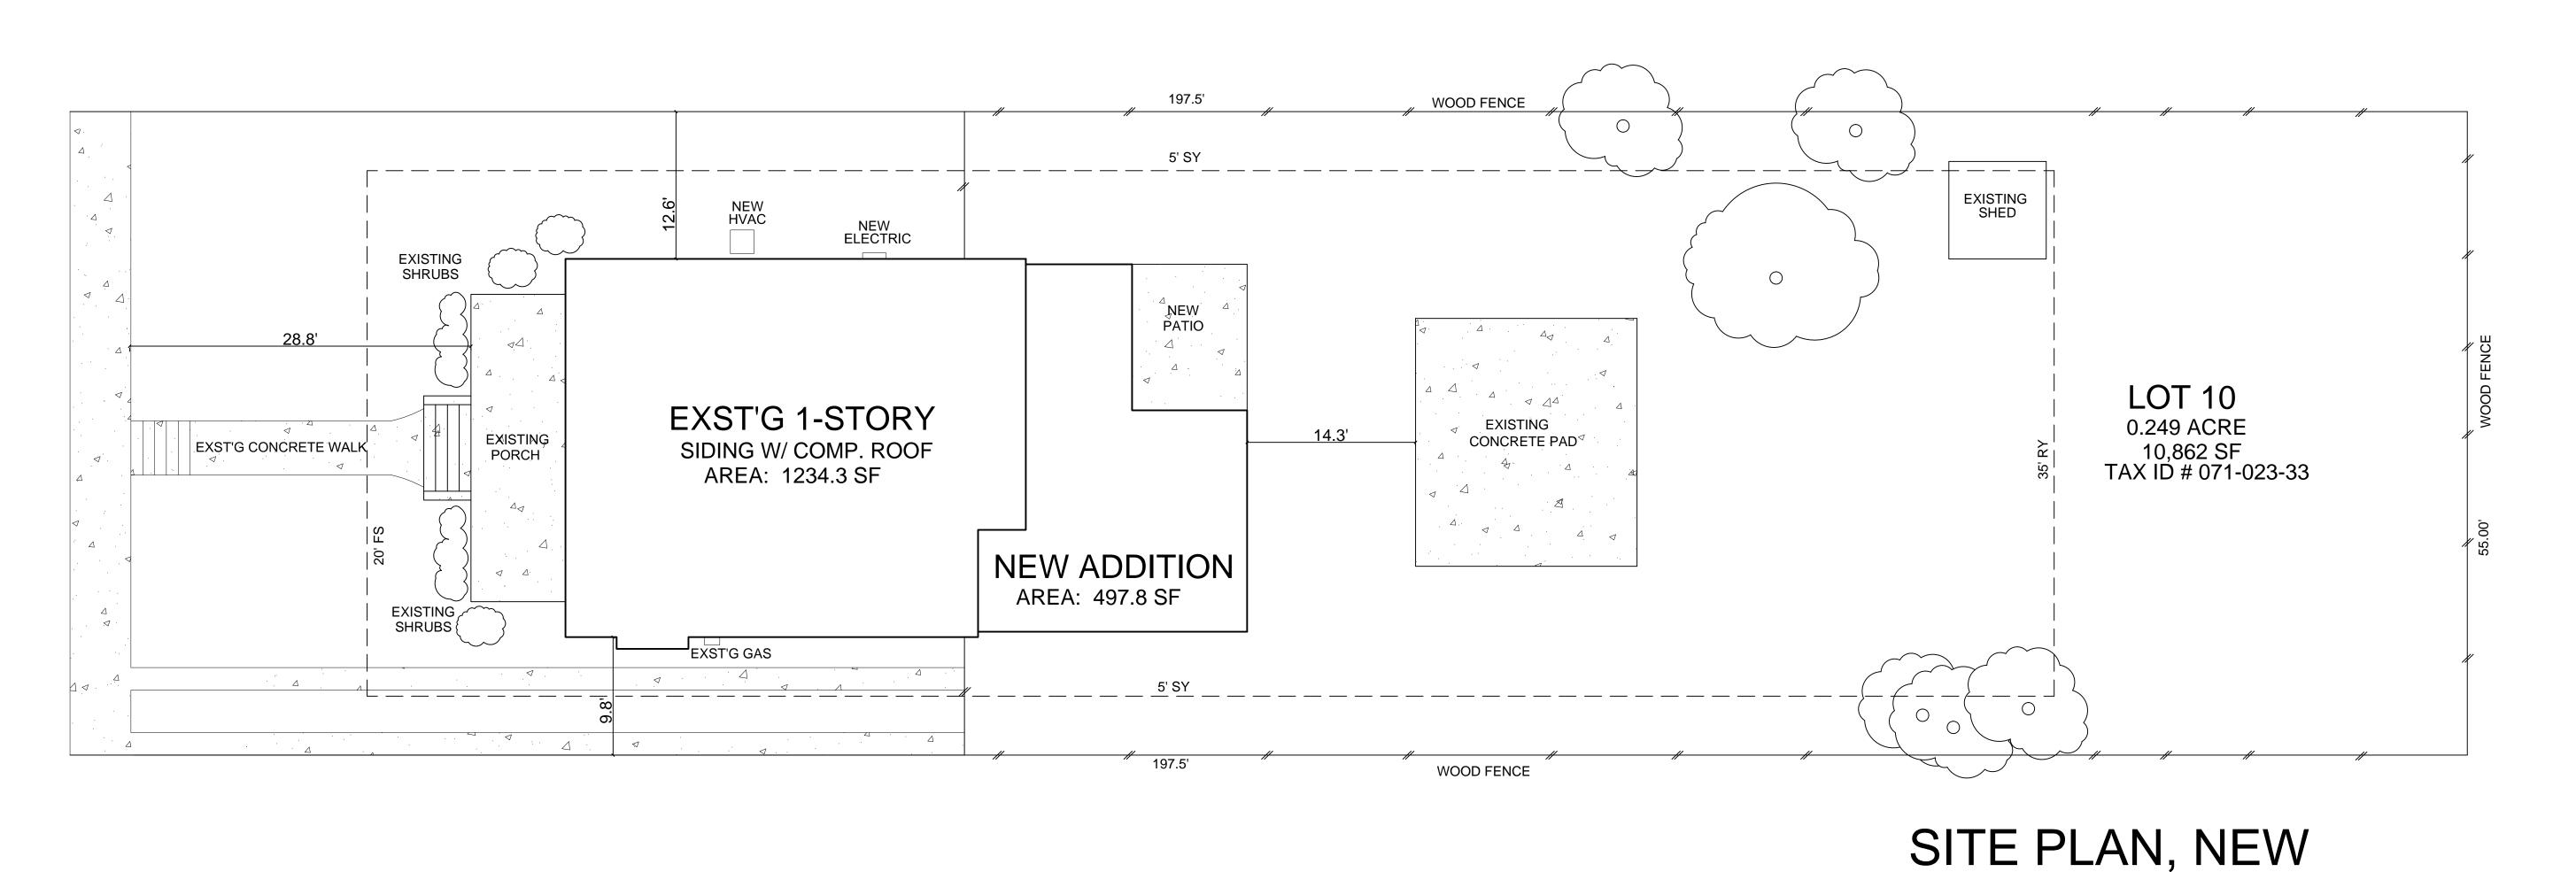

Suite D, 1200 The Plaza Charlotte, NC 28205 P: 704-614-8017

JASON CLARK RESIDENCE

ADDITION & RENOVATION

CHARLOTTE, NC

SITE PLAN, NEW & EXISTING

project number

。186

date4/11/16

scale

NTS drawn by

Carolyn Cook

INTENDED USE OF PLANS DISCLAIMER:

THESE DESIGN PLANS ARE NOT PROVIDED FOR ARCHITECTURAL OR ENGINEERING USE. IT IS THE RESPONSIBILITY OF THE RESPECTIVE TRADES TO VERIFY THAT ALL INFORMATION LISTED IS IN ACCORDANCE WITH EQUIPMENT USE, APPLICABLE CODES AND ACUTAL JOBSITE DIMENSIONS.

revisions

o

0

DESIGN PLANS ARE PROVIDED FOR THE FAIR USE BY THE CLIENT OR HIS AGENT IN COMPLETING THE PROJECT AS LISTED WITHIN THIS CONTRACT. DESIGN PLANS REMAIN THE PROPERTY OF THIS FIRM AND CANNOT BE USED OR REUSED WITHOUT

FOR CONSTRUCTION


FINAL PLAN ACCEPTED BY:

DATE:

NTS

sheet number

IN1.0

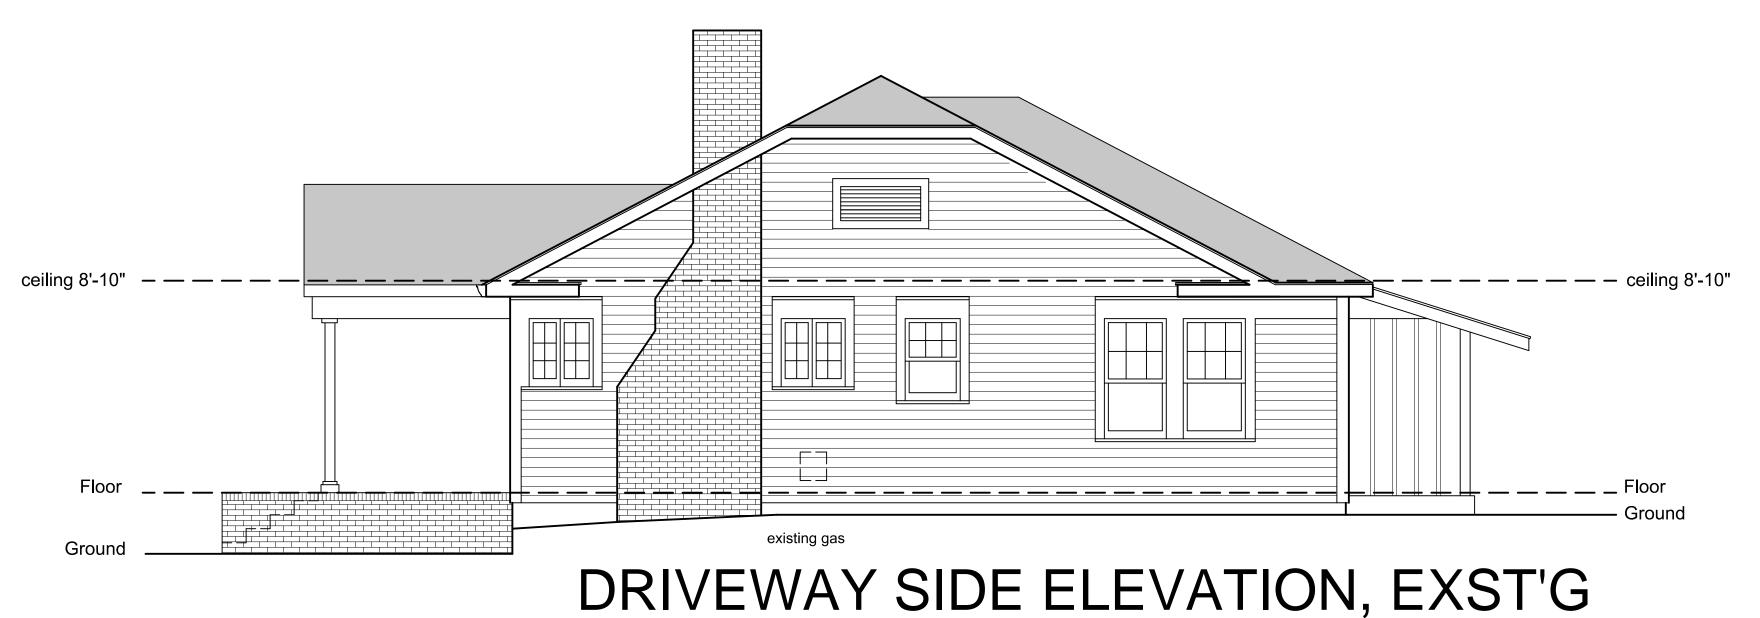

SCALE: 1/4"=1'-0"



REAR ELEVATION, EXST'G

SCALE: 1/4"=1'-0"



SIDE ELEVATION, EXST'G

SCALE: 1/4"=1'-0"

M. Pete, Inc.

Suite D, 1200 The Plaza Charlotte, NC 28205 P: 704-614-8017

JASON CLARK RESIDENCE

ADDITION & RENOVATION

CHARLOTTE, NC

EXTERIOR ELEVATIONS EXISTING

project number

。186

date4/11/16

scale

∘ 1/4"=1'-0" drawn by

Carolyn Cook

INTENDED USE OF PLANS DISCLAIMER:

THESE DESIGN PLANS ARE NOT PROVIDED FOR ARCHITECTURAL OR ENGINEERING USE. IT IS THE RESPONSIBILITY OF THE RESPECTIVE TRADES TO VERIFY THAT ALL INFORMATION LISTED IS IN ACCORDANCE WITH EQUIPMENT USE, APPLICABLE CODES AND ACUTAL JOBSITE DIMENSIONS.

revisions

0

0

0

DESIGN PLANS ARE PROVIDED FOR THE FAIR USE BY THE CLIENT OR HIS AGENT IN COMPLETING THE PROJECT AS LISTED WITHIN THIS CONTRACT. DESIGN PLANS REMAIN THE PROPERTY OF THIS FIRM AND CANNOT BE USED OR REUSED WITHOUT PERMISSION.

FOR CONSTRUCTION

FINAL PLAN ACCEPTED BY:

DATE:


sheet number

IN5.0



DRIVEWAY SIDE ELEVATION, NEW

SCALE: 1/4"=1'-0"

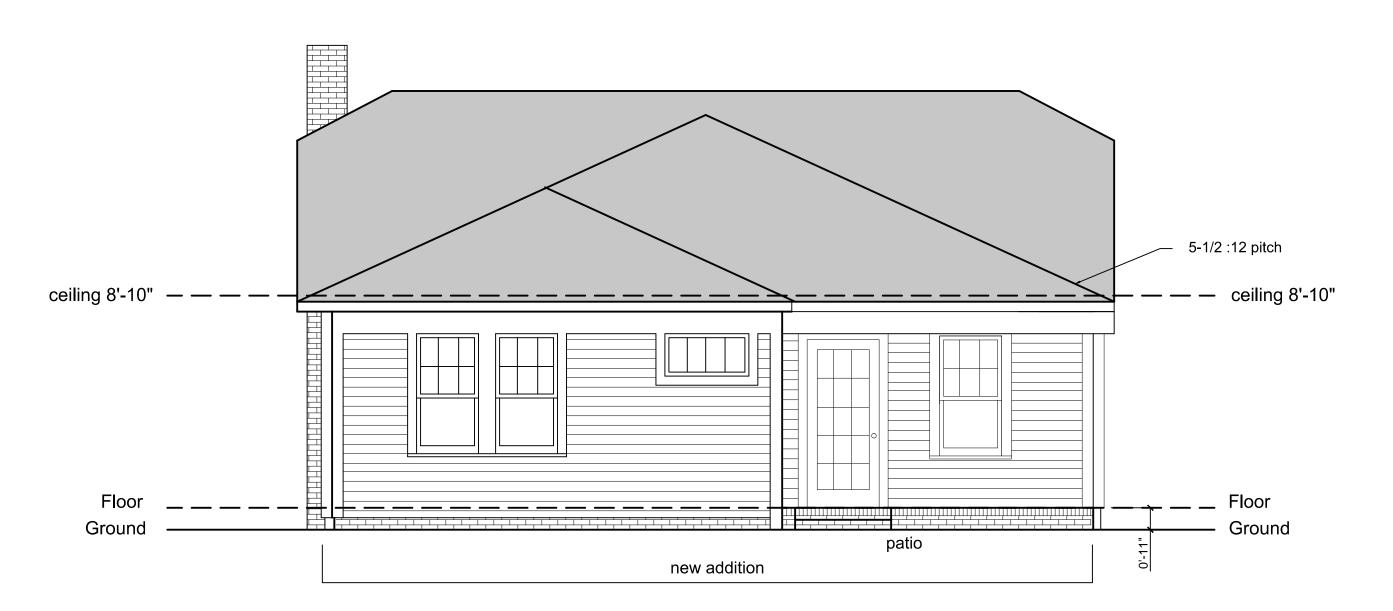

NOTES

- 1. Windows and doors shall be trimmed to match original home.
- Siding and cornerboard shall be matched to original home in style and dimension.
- 3. Soffit shall be open style.
- 4. Roof shall be matched to original home in style, material and color.
- New electrical and new HVAC shall be located where existing is located utilizing natural shrub screening. New shrub screening shall be added if necessary to eliminate appliance visibility from the road.

M. Pete, Inc.

Suite D, 1200 The Plaza Charlotte, NC 28205 P: 704-614-8017

JASON CLARK RESIDENCE

ADDITION & RENOVATION

CHARLOTTE, NC

EXTERIOR ELEVATIONS NEW

project number

- 。186
- date4/11/16

scale

- ∘ 1/4"=1'-0" drawn by
- Carolyn Cook

INTENDED USE OF PLANS DISCLAIMER:

THESE DESIGN PLANS ARE NOT PROVIDED FOR ARCHITECTURAL OR ENGINEERING USE. IT IS THE RESPONSIBILITY OF THE RESPECTIVE TRADES TO VERIFY THAT ALL INFORMATION LISTED IS IN ACCORDANCE WITH EQUIPMENT USE, APPLICABLE CODES AND ACUTAL JOBSITE DIMENSIONS.

revisions

- 0
- 0

DESIGN PLANS ARE PROVIDED FOR THE FAIR USE BY THE CLIENT OR HIS AGENT IN COMPLETING THE PROJECT AS LISTED WITHIN THIS CONTRACT. DESIGN PLANS REMAIN THE PROPERTY OF THIS FIRM AND CANNOT BE USED OR REUSED WITHOUT PERMISSION.

FOR CONSTRUCTION

FINAL PLAN ACCEPTED BY:

DATE:

sheet number

IN6.0

6 of 7


REAR ELEVATION, NEW


SCALE: 1/4"=1'-0"



SIDE ELEVATION, NEW

SCALE: 1/4"=1'-0"

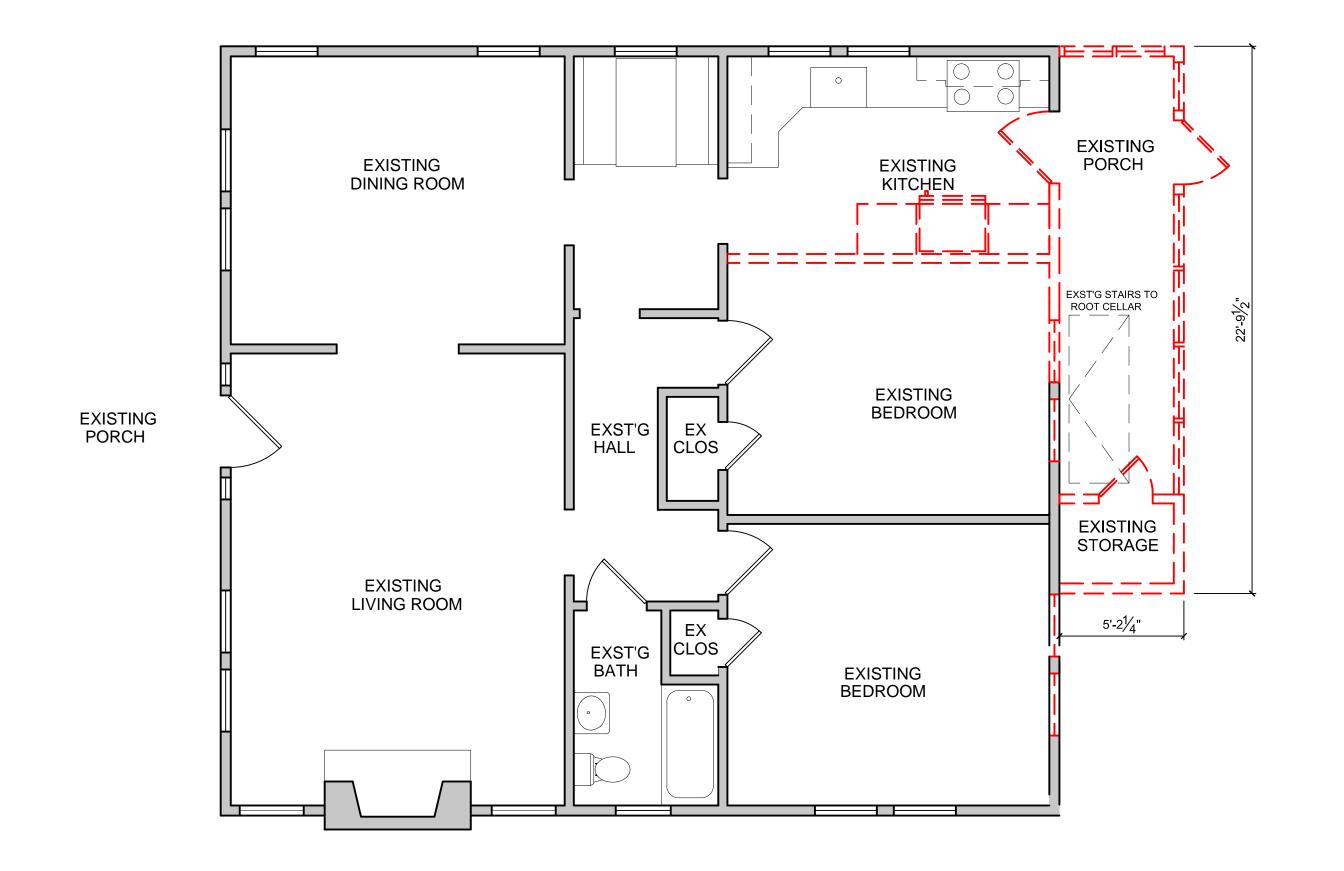

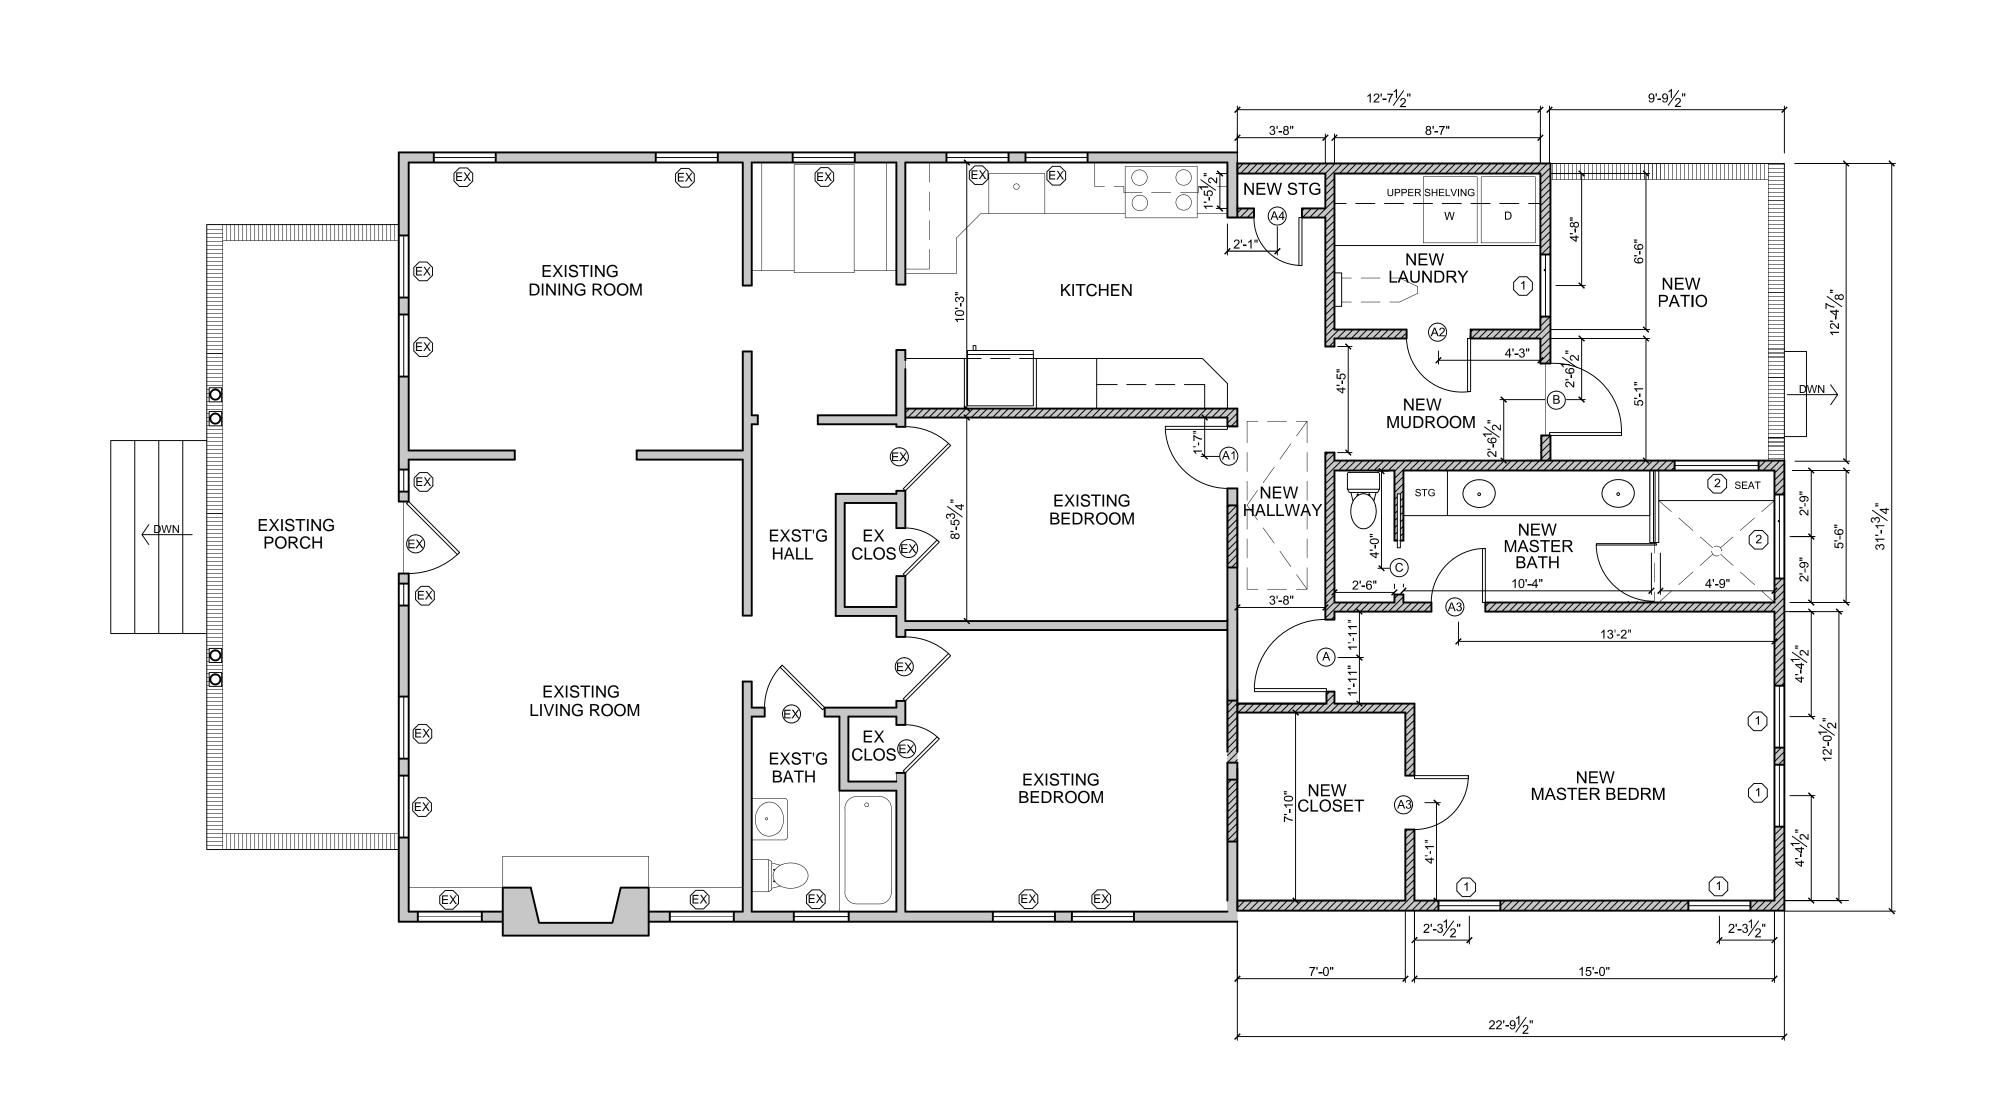

DEMOLITION

EXISTING WALLS



NEW CONSTRUCTION

DEMOLITION PLAN

SCALE: 1/4"=1'-0"

SCALE: 1/4"=1'-0"

flooring and hardware.

CONSTRUCTION NOTES

NEW CONSTRUCTION

Interior design shall match the design original to the home.
 This includes door and window trim, crown and base molding,

ADDITION & RENOVATION

M. Pete, Inc.

Suite D, 1200 The Plaza

Charlotte, NC 28205

JASON CLARK

RESIDENCE

P: 704-614-8017

CHARLOTTE, NC

DEMOLITION PLAN & NEW CONSTRUCTION

project number

- 。186
- date 4/11/16

scale

1/4"=1'-0" drawn by

Carolyn Cook

INTENDED USE OF PLANS DISCLAIMER:

THESE DESIGN PLANS ARE NOT PROVIDED FOR ARCHITECTURAL OR ENGINEERING USE. IT IS THE RESPONSIBILITY OF THE RESPECTIVE TRADES TO VERIFY THAT ALL INFORMATION LISTED IS IN ACCORDANCE WITH EQUIPMENT USE, APPLICABLE CODES AND ACUTAL JOBSITE DIMENSIONS.

revisions

DESIGN PLANS ARE PROVIDED FOR THE FAIR USE BY THE CLIENT OR HIS AGENT IN COMPLETING THE PROJECT AS LISTED WITHIN THIS CONTRACT. DESIGN PLANS REMAIN THE PROPERTY OF THIS FIRM AND CANNOT BE USED OR REUSED WITHOUT


FOR CONSTRUCTION

FINAL PLAN ACCEPTED BY:

DATE:

sheet number

IN2.0

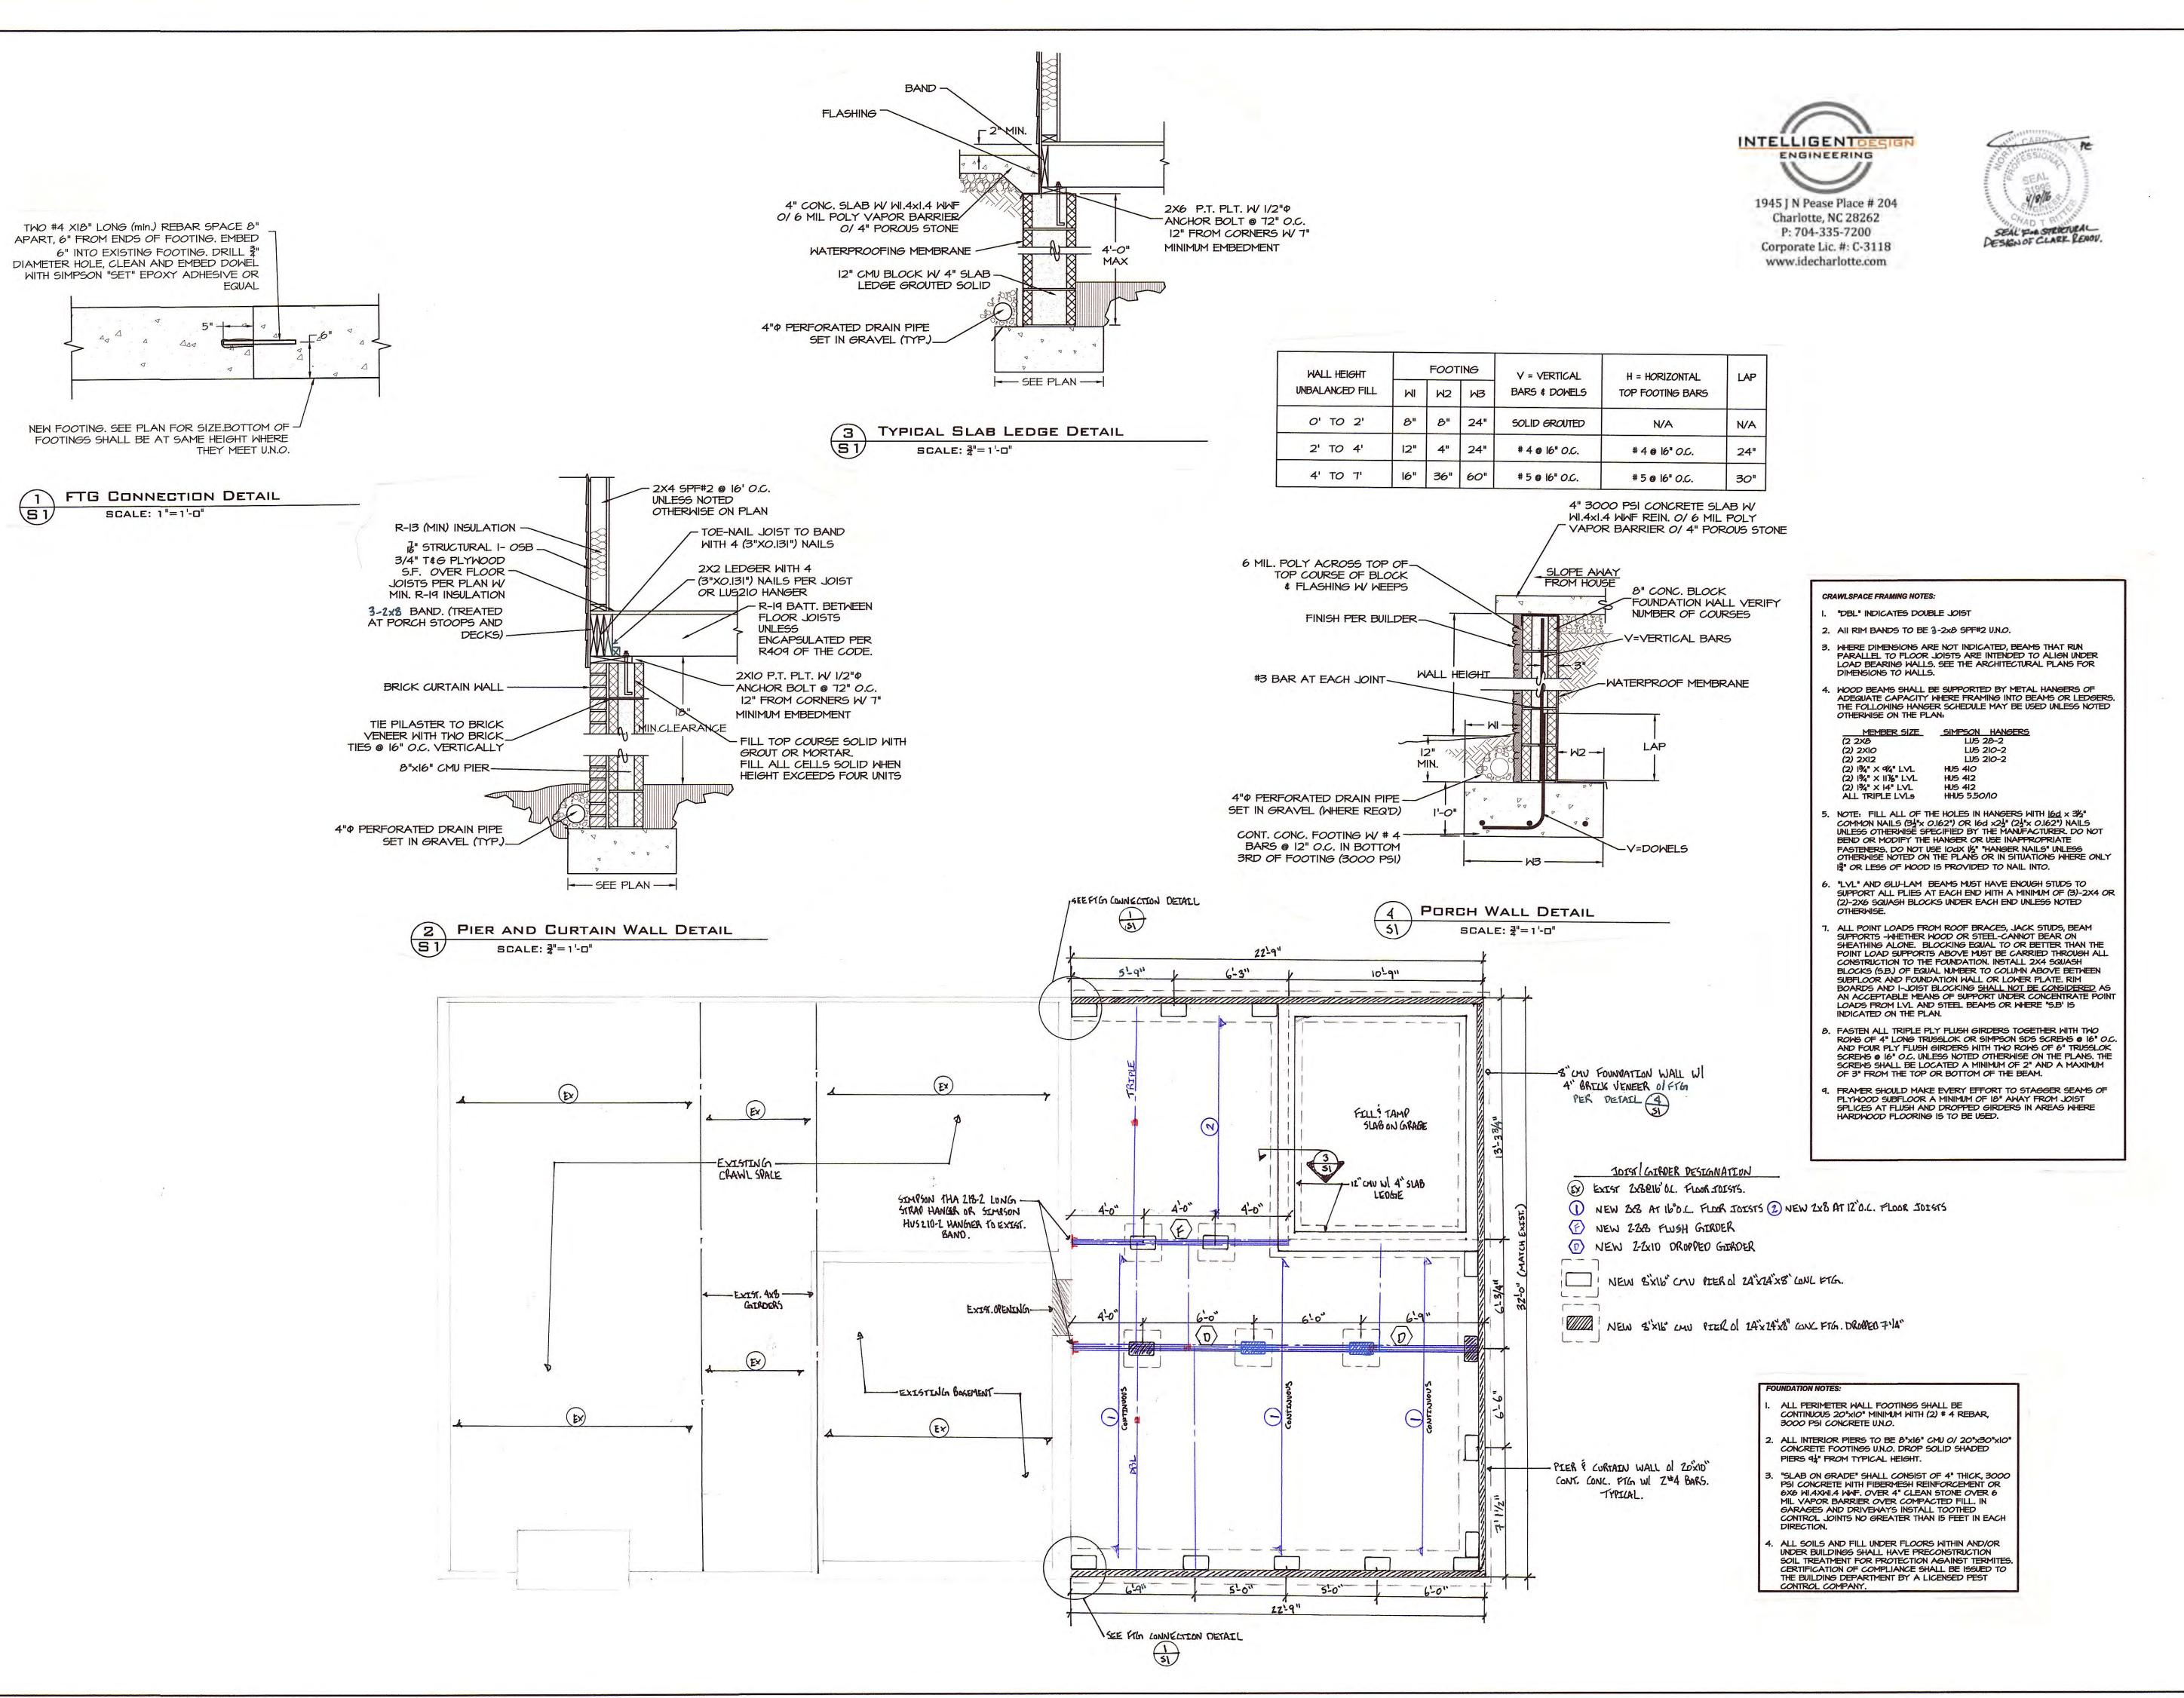

Suite D, 1200 The Plaza Charlotte, NC 28205 P: 704-614-8017

JASON CLARK RESIDENCE

ADDITION & RENOVATION

CHARLOTTE, NC

FOUNDATION PLAN

project number

。186

date4/5/16

scale

∘ 1/4"=1'-0" drawn by

Carolyn Cook

INTENDED USE OF PLANS DISCLAIMER:

THESE DESIGN PLANS ARE NOT PROVIDED FOR ARCHITECTURAL OR ENGINEERING USE. IT IS THE RESPONSIBILITY OF THE RESPECTIVE TRADES TO VERIFY THAT ALL INFORMATION LISTED IS IN ACCORDANCE WITH EQUIPMENT USE, APPLICABLE CODES AND ACUTAL JOBSITE DIMENSIONS.

revisions

0

•


DESIGN PLANS ARE PROVIDED FOR THE FAIR USE BY THE CLIENT OR HIS AGENT IN COMPLETING THE PROJECT AS LISTED WITHIN THIS CONTRACT. DESIGN PLANS REMAIN THE PROPERTY OF THIS FIRM AND CANNOT BE USED OR REUSED WITHOUT PERMISSION.


FINAL PLAN ACCEPTED BY:

DATE:

sheet number

51

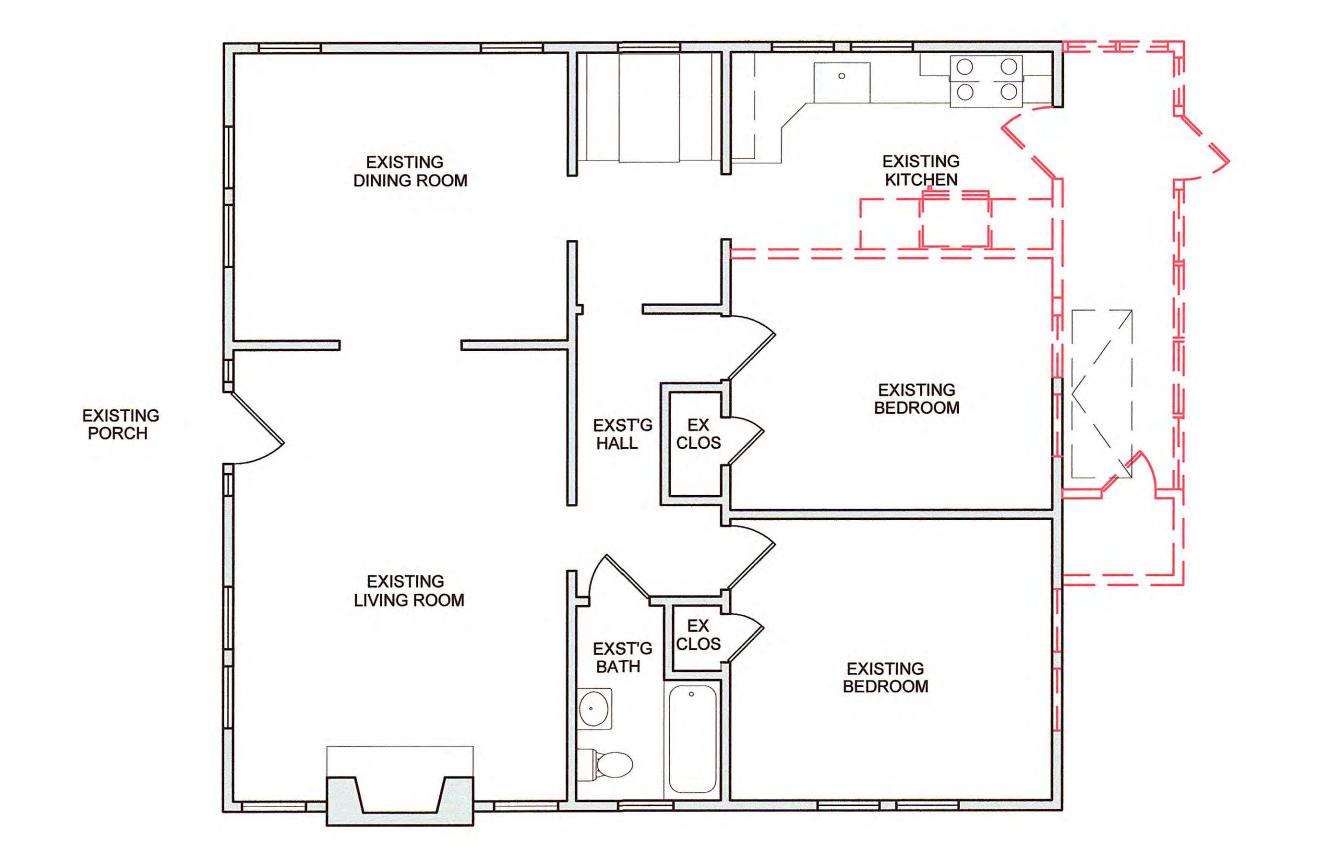

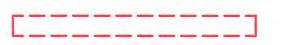

DEMOLITION



EXISTING WALLS



NEW CONSTRUCTION

DEMOLITION PLAN

SCALE: 1/4"=1'-0"

- "T.T.R" INDICATES "TIE (CEILING JOIS) TO RAFTER WITH FOUR
- 2. "DBL" INDICATES DOUBLE JOIST . ALL LOAD- BEARING HEADERS SHALL BE (2)2X8 SPF#2 UNLESS OTHERWISE NOTED ON THE PLAN.
- FRACED WALL LINE NOTE:
 THIS ADDITION HAS BEEN ANALYZED FOR LATERAL LOADING
- USING CONTINUOUSLY SHEATHED WALL SHEATHING AS INDICATED IN THE GENERAL NOTES. WHERE BRACED WALLS DO NOT MEET THE PRESCRIPTIVE REQUIREMENTS OF SECTION R602.10 OF THE CODE, IT HAS BEEN ANALYZED BY ENGINEERING ANALYSIS INCORPORATING ENGINEERED LATERAL BRACING ELEMENTS WHERE NEEDED TO MEET THE INTENT OF THE CODE.
- WHERE DIMENSIONS ARE NOT INDICATED, BEAMS THAT RUN PARALLEL TO FLOOR JOISTS ARE INTENDED TO ALIGN UNDER LOAD BEARING WALLS. SEE THE ARCHITECTURAL PLANS FOR
- . ALL WALLS UP TO 10 FT. TALL SHALL BE 2X4 SPF#2 @ 16" O.C. UNLESS NOTED OTHERWISE ON THE PLAN. TALLER WALLS SHALL COMPLY WITH TABLE R602.3(4) OF THE CODE OR AS NOTED ON
- WOOD BEAMS SHALL BE SUPPORTED BY METAL HANGERS OF ADEQUATE CAPACITY WHERE FRAMING INTO BEAMS OR LEDGERS. THE FOLLOWING HANGER SCHEDULE MAY BE USED UNLESS NOTED OTHERWISE ON THE PLAN:
- LUS 210-2 (2) 134" X 94" LVL

(2) 134" X 1136" LVL (2) 134" X 1136" LVL (2) 134" X 14" LVL ALL TRIPLE LVLs


10'-91/2"

22'-41/2"

HUS 410

- 8. NOTE: FILL ALL OF THE HOLES IN HANGERS WITH 16d x 31/2" COMMON NAILS (3½"X 0.162") OR 16d X2½" (2½"X 0.162") NAILS UNLESS OTHERWISE SPECIFIED BY THE MANUFACTURER. DO NOT BEND OR MODIFY THE HANGER OR USE INAPPROPRIATE FASTENERS, DO NOT USE IOOX 16" "HANGER NAILS" UNLESS OTHERWISE NOTED ON THE PLANS OR IN SITUATIONS WHERE ONLY IP OR LESS OF WOOD IS PROVIDED TO NAIL INTO.
- 9. "LYL" AND GLU-LAM BEAMS MUST HAVE ENOUGH STUDS TO SUPPORT ALL PLIES AT EACH END WITH A MINIMUM OF (3)-2X4 OR (2)-2X6 STUDS UNDER EACH END UNLESS NOTED OTHERWISE.
- IO. ALL POINT LOADS FROM ROOF BRACES, JACK STUDS, BEAM SUPPORTS -WHETHER WOOD OR STEEL-CANNOT BEAR ON SHEATHING ALONE. BLOCKING EQUAL TO OR BETTER THAN THE POINT LOAD SUPPORTS ABOVE MUST BE CARRIED THROUGH ALL CONSTRUCTION TO THE FOUNDATION, INSTALL 2X4 SQUASH BLOCKS (S.B.) OF EQUAL NUMBER TO COLUMN ABOVE BETWEEN SUBFLOOR AND FOUNDATION WALL OR LOWER PLATE. RIM
 BOARDS AND I-JOIST BLOCKING SHALL NOT BE CONSIDERED AS
 AN ACCEPTABLE MEANS OF SUPPORT UNDER CONCENTRATE POINT
 LOADS FROM LYL AND STEEL BEAMS OR WHERE "S.B" IS
 INDICATED ON THE PLAN.
- FASTEN ALL TRIPLE PLY LVLS TOGETHER WITH TWO ROWS OF 5" LONG TRUSSLOK OR SIMPSON SDS SCREAS @ 16" O.C. AND FOUR PLY LVLs WITH THO ROWS OF 634" TRUSSLOK SCREMS @ 16" O.C. UNLESS NOTED OTHERWISE ON THE PLANS. THE SCREWS SHALL BE LOCATED A MINIMUM OF 2" AND A MAXIMUM OF 3" FROM THE TOP OR BOTTOM OF THE BEAM.
- 12. FASTEN FIRST KING STUD TO LUMBER HEADER WITH AT LEAST THREE 16D (31/2 XO.162") IN EACH PLY.

... 2 JACK, 3 KINGS ... 2 JACKS, 4 KINGS ... 3 JACKS, 5 KINGS ... 5EE PLAN SPANS >5'-6" TO 6'-6" . . . SPANS >6'-6" TO 8'-6" . . . SPANS >8'-6" TO 10'-0". .

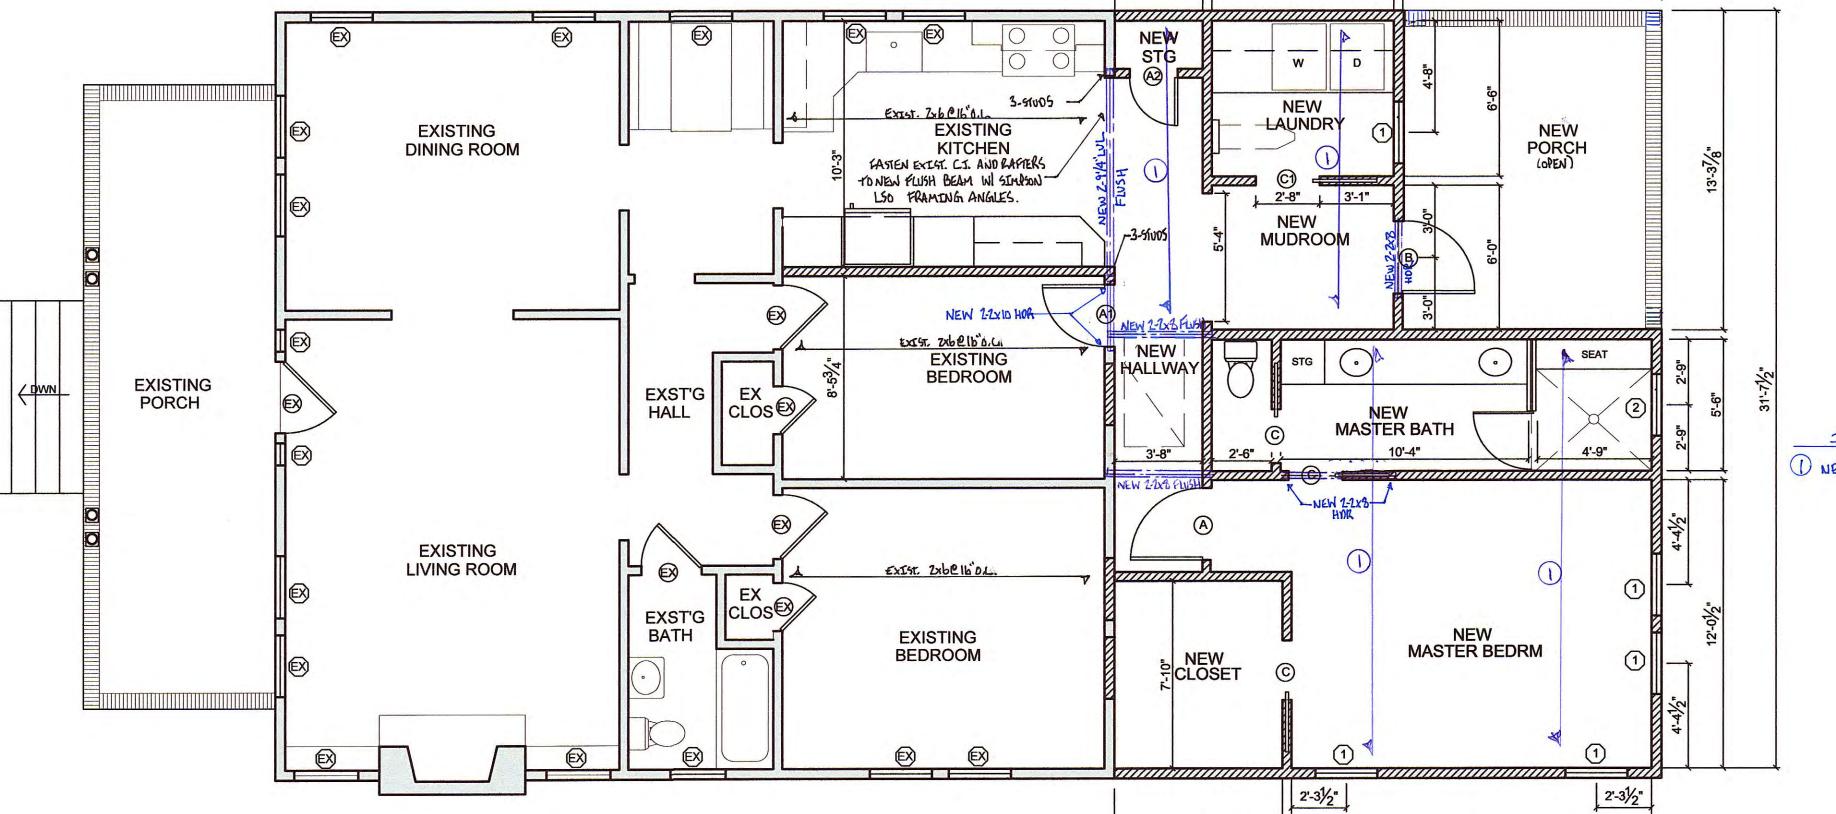

NEW CONSTRUCTION

SCALE: 1/4"=1'-0"

New Addition 554.6 sf

JOIST DESIGNATION 1 NEW 2x8 SPF#2 E16'0.L.



INTELLIGENTOESIG 1945 J N Pease Place # 204 Charlotte, NC 28262 P: 704-335-7200 Corporate Lic. #: C-3118 www.idecharlotte.com

M. Pete, Inc.

Suite D, 1200 The Plaza Charlotte, NC 28205 P: 704-614-8017

JASON CLARK RESIDENCE

ADDITION & RENOVATION

CHARLOTTE, NC

DEMOLITION PLAN & NEW CONSTRUCTION

project number

- date 4/5/16

scale · 1/4"=1'-0"

drawn by Carolyn Cook

INTENDED USE OF PLANS DISCLAIMER:

THESE DESIGN PLANS ARE NOT PROVIDED FOR ARCHITECTURAL OR ENGINEERING USE. IT IS THE RESPONSIBILITY OF THE RESPECTIVE TRADES TO VERIFY THAT ALL INFORMATION LISTED IS IN ACCORDANCE WITH EQUIPMENT USE, APPLICABLE CODES AND ACUTAL JOBSITE DIMENSIONS.

revisions

DESIGN PLANS ARE PROVIDED FOR THE FAIR USE BY THE CLIENT OR HIS AGENT IN COMPLETING THE PROJECT AS LISTED WITHIN THIS CONTRACT. DESIGN PLANS REMAIN THE PROPERTY OF THIS FIRM AND CANNOT BE USED OR REUSED WITHOUT PERMISSION.

FOR CONSTRUCTION

FINAL PLAN ACCEPTED BY:

DATE:

sheet number

IN2.0





Suite D, 1200 The Plaza Charlotte, NC 28205 P: 704-614-8017

JASON CLARK RESIDENCE

ADDITION & RENOVATION

CHARLOTTE, NC

ROOF PLAN

project number

。186

date 4/5/16

scale AS NOTED drawn by Carolyn Cook

INTENDED USE OF PLANS DISCLAIMER: THESE DESIGN PLANS ARE NOT PROVIDED FOR ARCHITECTURAL OR ENGINEERING RESPECTIVE TRADES TO VERIFY THAT AL INFORMATION LISTED IS IN ACCORDANCE WITH EQUIPMENT USE, APPLICABLE CODES AND ACUTAL JOBSITE DIMENSIONS.

revisions

DESIGN PLANS ARE PROVIDED FOR THE FAIR USE BY THE CLIENT OR HIS AGENT I WITHIN THIS CONTRACT. DESIGN PLANS REMAIN THE PROPERTY OF THIS FIRM AND CANNOT BE USED OR REUSED WITHOUT

FOR CONSTRUCTION

FINAL PLAN ACCEPTED BY:

DATE:

sheet number

IN3.0

3 of 7


DEMOLITION

ROOF FRAMING NOTES @ NEW FRAMING:

- IN ADDITION TO THE CODE'S FASTENER SCHEDULE, UNLESS NOTED OTHERWISE ON THE PLAN, INSTALL SIMPSON HI OR H2.5A HURRICANE CLIPS AT THE ENDS OF THE RAFTERS WHERE THEY BEAR ON THE WALL PLATE @ 48" O.C. FASTEN TO THE OUTSIDE OF THE WALL PLATE WITH
- 8d COMMON NAILS AND TO THE RAFTER OR TRUSS WITH 8dX1½" NAILS. INSTALLING OVER WALL SHEATHING IS ACCEPTABLE. . RAFTERS SHALL BE 2X6 SPF#2 @ 16" O.C. FOR SHINGLES WITH 7" OSB SHEATHING WITH ONE LAYER OF 15# FELT UNLESS NOTED OTHERWISE. THEY ARE TO BE CUT INTO HIPS, RIDGES, ETC., UNLESS NOTED OTHERWISE
- . ALL RAFTERS FRAMING INTO STRUCTURAL RIDGE BEAMS (RIDGES WITHOUT CEILING TIES), SHALL BE CONNECTED WITH THREE 3"X O.131" TOE-NAILS FOR SPANS UP TO 8 FT. AND A SIMPSON LRU28 HANGER OR L50 BRACKET FOR SPANS GREATER THAN 8 FT.
- ALL "HOGS" SHALL BE COMPOSED OF TWO 2X6'S OR TWO 2X6'S, AS INDICATED ON THE PLAN. THE BOARDS SHALL BE FASTENED TOGETHER AT THEIR ENDS WITH 3"XO.131" NAILS AT 4" ON CENTER TO
- RAFTERS MAY BE SPLICED OVER HOGS. SPLICE RAFTER HOGS ONLY
- ALL ROOF BRACES MUST HAVE A STUD FROM PLATE THROUGH ALL FLOORS TO THE FOUNDATION OR SUPPORTING BEAM BELOW. NO BRACES SHALL BE ATTACHED TO TOP WALL PLATE MITHOUT STUDS DIRECTLY UNDER THEM.

- INDICATES LOCATION OF ROOF BRACE POINT AT RAFTER
- ⊗→ ARROW AWAY FROM THE BRACE POINT INDICATES DIRECTION OF ROOF BRACE TO PARTITION, BEAM, OR OTHER BRACE POINT BELOW.
- &- ARROW INTO BRACE POINT INDICATES A VERTICAL OR ALMOST VERTICAL ROOF BRACE TO PARTITION, BEAM, OR OTHER BRACE POINT BELOW.
- D. ROOF BRACES UNDER 7'-O" ARE 2-2X4 NAILED WITH 3"X O.131"NAILS @ 6" O.C. VERTICALLY FROM TOP TO BOTTOM. BRACES LONGER THAN 7'-0" SHALL CONSIST OF (2)2X6 T-BRACES. BRACES LONGER THAN 12 FT. MUST BE BRACED HORIZONTALLY IN TWO DIRECTIONS AT
- E. CONNECT BOTTOMS OF ALL BRACES THAT ARE NOT WITHIN 26° FROM VERTICAL TO BEAMS OR WALLS WITH ONE SIMPSON A34 BRACKET.
- 6. "HOG": INDICATES (2)2X6 HOG INSTALLED AGAINST RAFTERS.
- H. "R.B." INDICATES RAFTERS BEAR ON WALL
- I. ALL SHADED OR HATCHED AREAS INDICATE ROOF OVERBUILDS

AT A ROOF BRACE.

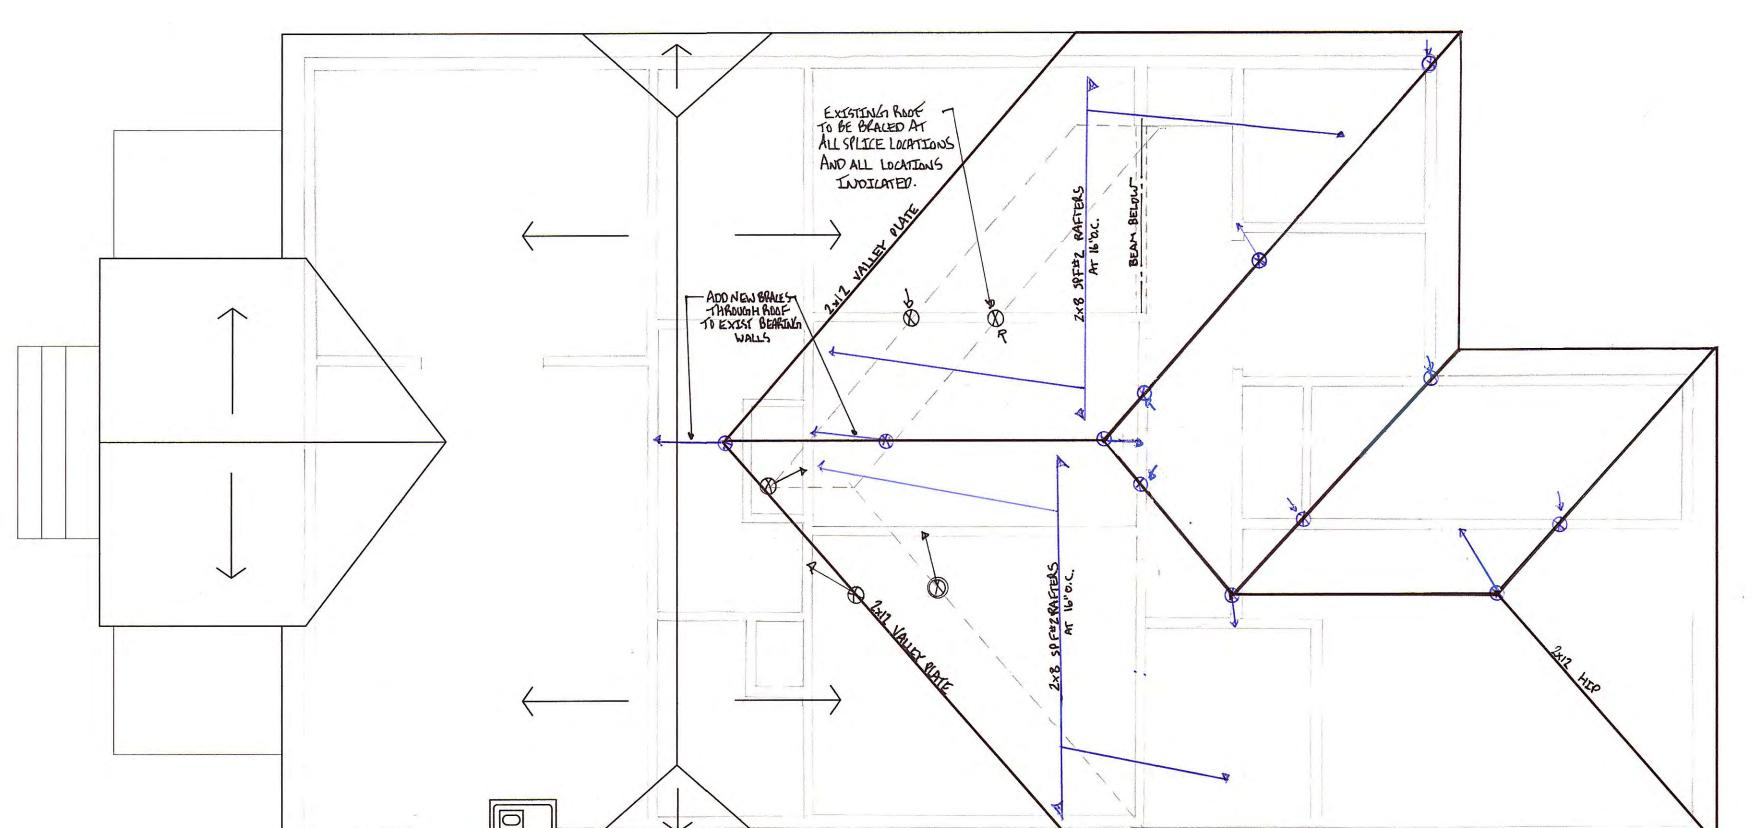


NEW ROOF PLAN


SCALE: 1/4"=1'-0"

ASPHALT ROOF DETAIL

Underlayment


NTS

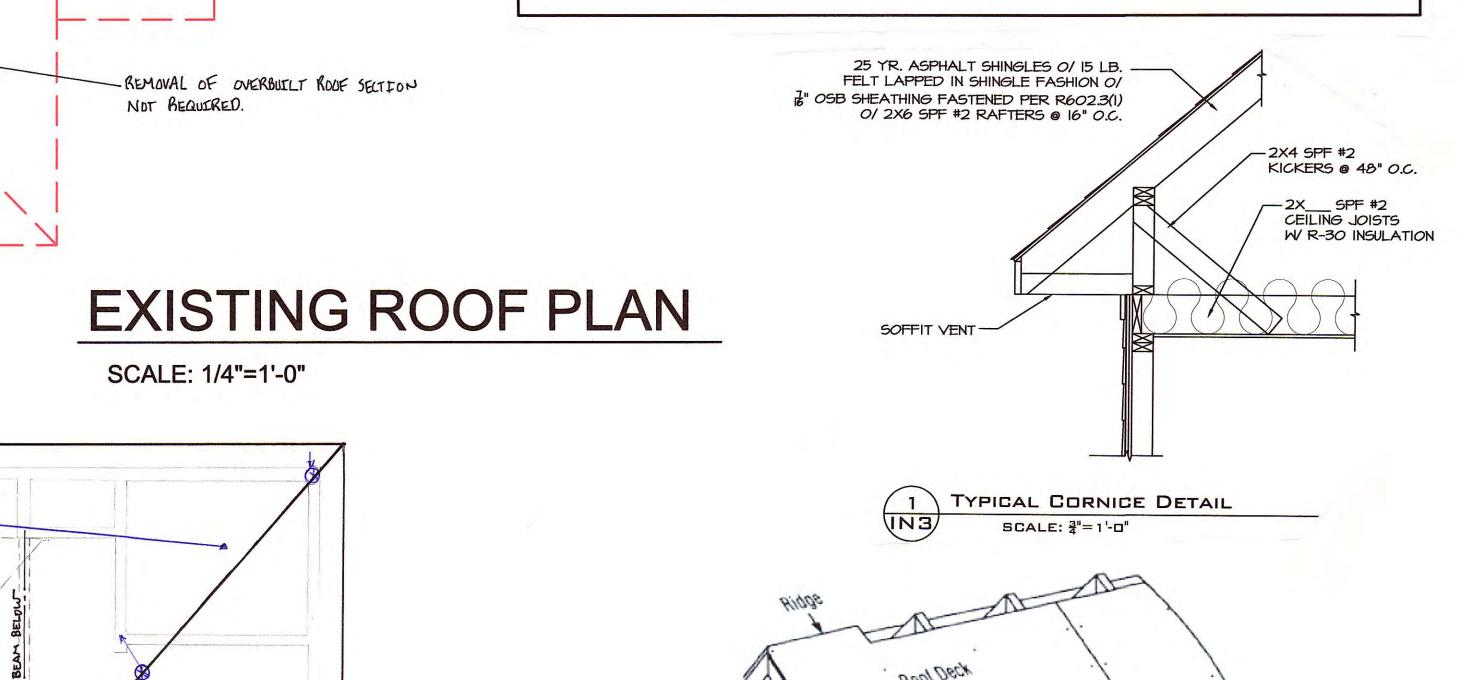

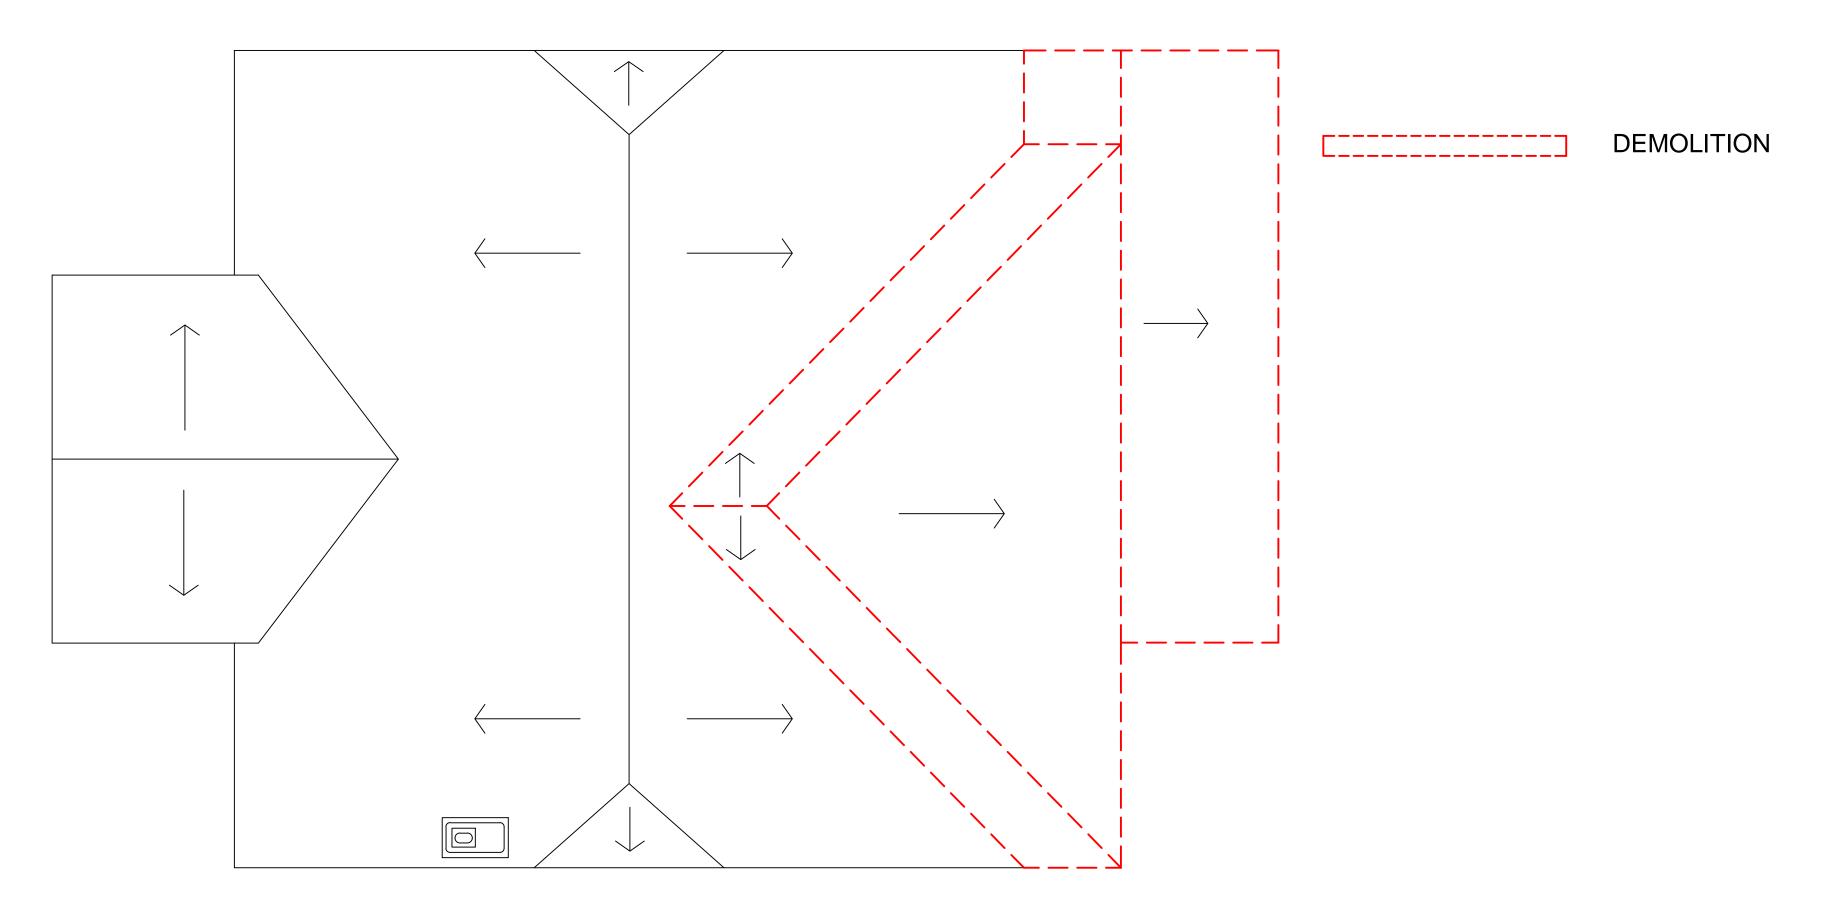


EXISTING ROOF PLAN

SCALE: 1/4"=1'-0"

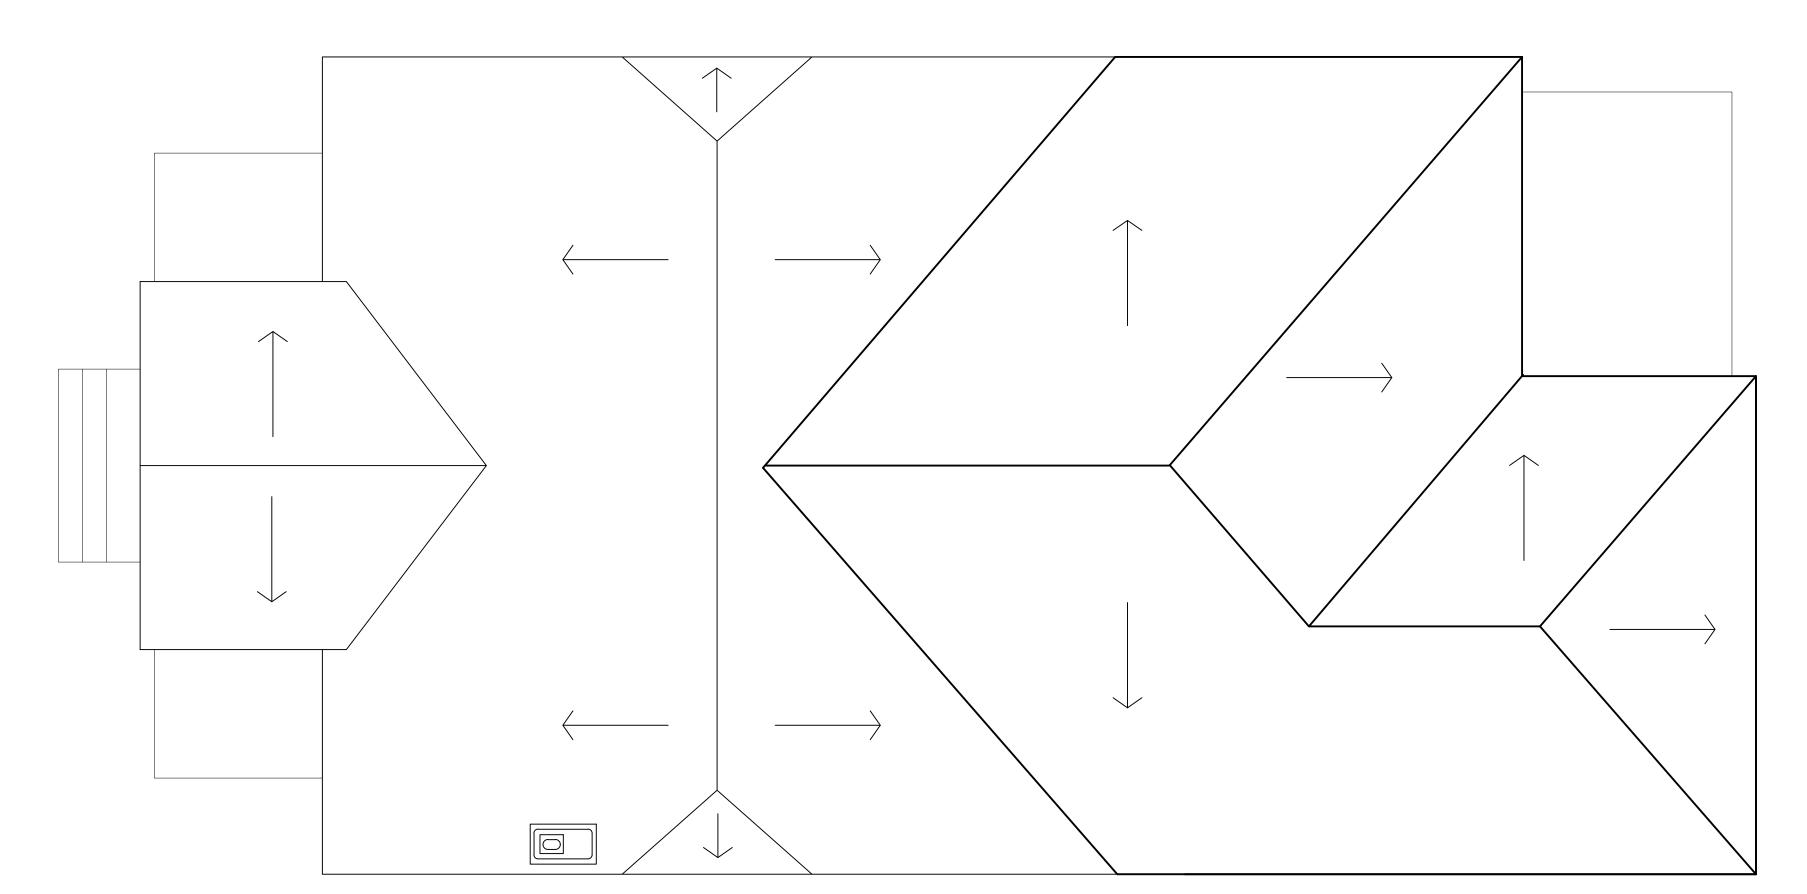

NEW ROOF PLAN

SCALE: 1/4"=1'-0"

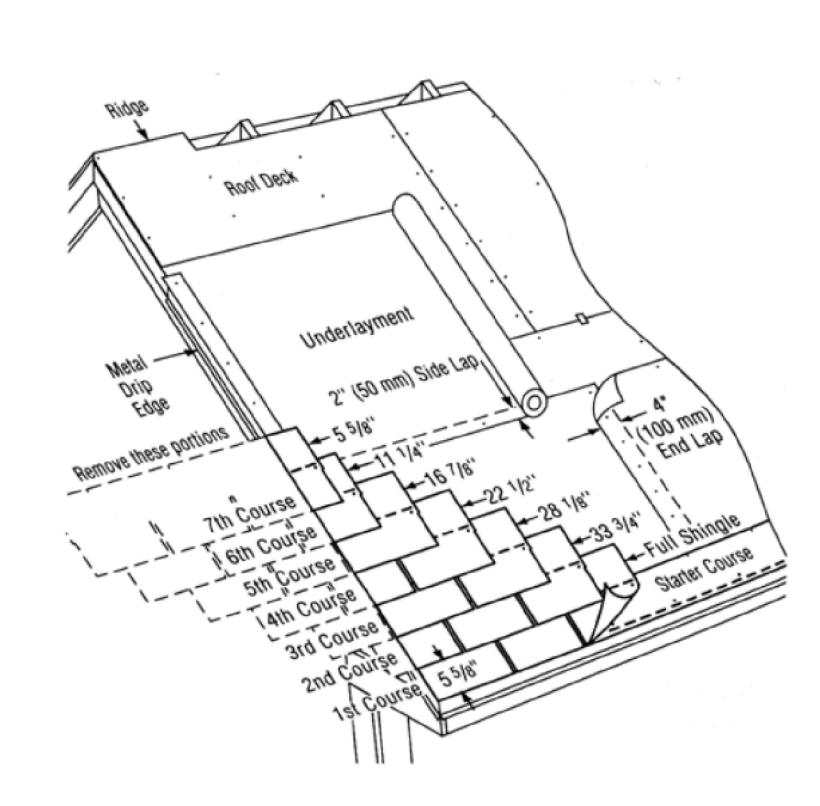

ASPHALT ROOF DETAIL

NTS

M. Pete, Inc.

Suite D, 1200 The Plaza Charlotte, NC 28205 P: 704-614-8017

JASON CLARK RESIDENCE

ADDITION & RENOVATION

CHARLOTTE, NC

ROOF PLAN, DEMO & NEW

project number

- 。186
- date

4/11/16

scale

AS NOTED drawn by Carolyn Cook

INTENDED USE OF PLANS DISCLAIMER:

THESE DESIGN PLANS ARE NOT PROVIDED FOR ARCHITECTURAL OR ENGINEERING
USE. IT IS THE RESPONSIBILITY OF THE
RESPECTIVE TRADES TO VERIFY THAT ALL
INFORMATION LISTED IS IN ACCORDANCE
WITH EQUIPMENT USE, APPLICABLE CODES AND ACUTAL JOBSITE DIMENSIONS.

revisions

DESIGN PLANS ARE PROVIDED FOR THE FAIR USE BY THE CLIENT OR HIS AGENT IN COMPLETING THE PROJECT AS LISTED WITHIN THIS CONTRACT. DESIGN PLANS
REMAIN THE PROPERTY OF THIS FIRM AND
CANNOT BE USED OR REUSED WITHOUT


FOR CONSTRUCTION

FINAL PLAN ACCEPTED BY:

DATE:

sheet number

IN3.0

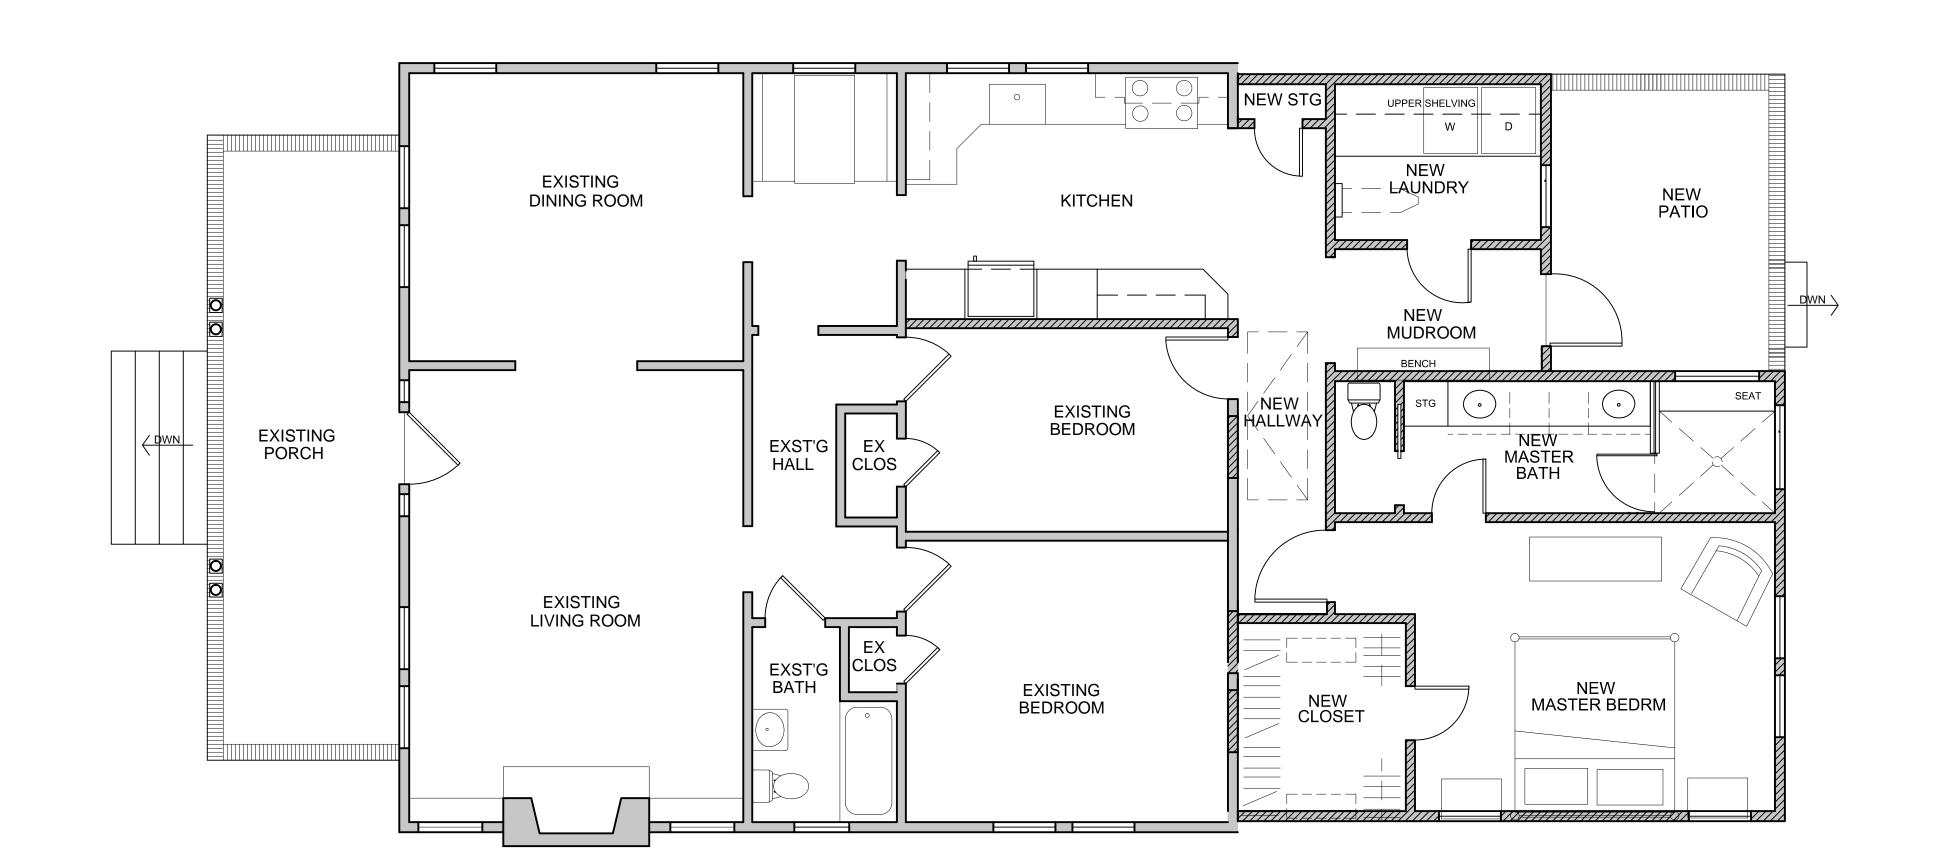

FURNITURE PLAN

SCALE: 1/4"=1'-0"

M. Pete, Inc.

Suite D, 1200 The Plaza Charlotte, NC 28205 P: 704-614-8017

JASON CLARK RESIDENCE

ADDITION & RENOVATION

CHARLOTTE, NC

FURNITURE PLAN

project number

- 。186
- date4/11/16

scale

- 1/4"=1'-0" drawn by
- Carolyn Cook

INTENDED USE OF PLANS DISCLAIMER:

THESE DESIGN PLANS ARE NOT PROVIDED FOR ARCHITECTURAL OR ENGINEERING USE. IT IS THE RESPONSIBILITY OF THE RESPECTIVE TRADES TO VERIFY THAT ALL INFORMATION LISTED IS IN ACCORDANCE WITH EQUIPMENT USE, APPLICABLE CODES AND ACUTAL JOBSITE DIMENSIONS.

revisions

| '

۱

DESIGN PLANS ARE PROVIDED FOR THE FAIR USE BY THE CLIENT OR HIS AGENT IN COMPLETING THE PROJECT AS LISTED WITHIN THIS CONTRACT. DESIGN PLANS REMAIN THE PROPERTY OF THIS FIRM AND CANNOT BE USED OR REUSED WITHOUT PERMISSION.

FOR CONSTRUCTION

FINAL PLAN ACCEPTED BY:

DATE:

sheet number

IN7.0

DOOR LEGEND				
Door		Room	Qty	Description
	A	New Master Bedroom	1	Hinged, 2-Panel Wood Interior Door 36"W
	A1	New Office	1	Hinged, 2-Panel Wood Interior Door 30"W
	A2)	New Laundry	1	Hinged, 2-Panel Wood Interior Door 32"W
	(A3)	New Master Closet	1	Hinged, 2-Panel Wood Interior Door 27"W
		New Master Bathroom	2	21 VV
	A4	New Storage, Kitchen	1	Hinged, 2-Panel Wood Interior Door 24"W
	B	New Mudroom	1	Hinged 36" x 84" Primed Wood Exterior, Painted, Tempered Glass, exposed exterior grid
	C	New Master Bathroom	1	Pocket Door, 2-Panel Wood Interior Door 24"W
		match existing. Confirm existing on the control of		
Existing	g doors	s to remain, are indicated as ex		

Window	Room	Qty	Description
	New Laundry New Master Bedroom	1 4	Double-Hung, 6 over 1 pre-primed wood w/ exposed exterior grid to match original home construction. Window hardware will match exst'g. 2'-7" x 5'-0"
2	New Master Bathroom	2	Transom Window, 4 lites, fixed, w/ exposed exterior grid to match original home construction, window hardware will match exst'g, frosted privacy glass, 3'-6"w X 1'-9"h
NOTE:	Double-hung windows to matc	h existi	ing.

Suite D, 1200 The Plaza Charlotte, NC 28205 P: 704-614-8017

JASON CLARK RESIDENCE

ADDITION & RENOVATION

CHARLOTTE, NC

DOOR & WINDOW SCHEDULES

project number

- 。186
- date4/11/16

scale

- AS NOTED drawn by
- Carolyn Cook

INTENDED USE OF PLANS DISCLAIMER:

THESE DESIGN PLANS ARE NOT PROVIDED FOR ARCHITECTURAL OR ENGINEERING USE. IT IS THE RESPONSIBILITY OF THE RESPECTIVE TRADES TO VERIFY THAT ALL INFORMATION LISTED IS IN ACCORDANCE WITH EQUIPMENT USE, APPLICABLE CODES AND ACUTAL JOBSITE DIMENSIONS.

revisions

0

0

0

DESIGN PLANS ARE PROVIDED FOR THE FAIR USE BY THE CLIENT OR HIS AGENT IN COMPLETING THE PROJECT AS LISTED WITHIN THIS CONTRACT. DESIGN PLANS REMAIN THE PROPERTY OF THIS FIRM AND CANNOT BE USED OR REUSED WITHOUT PERMISSION.

FOR CONSTRUCTION

FINAL PLAN ACCEPTED BY:

DATE:

sheet number

IN4.0