LOCAL HISTORIC DISTRICT: Wilmore

PROPERTY ADDRESS:	1613 Wilmore Drive
SUMMARY OF REQUEST:	New Construction
OWNER:	Lauren & Matthew Alexander
APPLICANT:	Matthew Alexander

This application was continued for: 1) Redesigned front dormer and set back to thermal wall, 2) Window details, 3) Gable material, 4) Material dimensions, and 5) Hand rail detail.

Details of Proposed Request

Existing Conditions

The existing property is vacant. Surrounding single family homes are primarily 1 and 1.5 stories. The setback along the subject block is a range of approximately 17' to 20' from the front porch to back of sidewalk. A similar setback condition exists across the street.

Proposal

The proposal is a 1.5 story single family home, a detached garage in the rear yard and removal of a tree in the rear yard. Plan details include:

- 1. 6' front porch
- 2. 21'-11" setback measured from the porch
- 3. Overall height of 27' from FFE. Foundation height approximately 2'-4".
- 4. Wood lap and cedar shake siding
- 5. Wood windows and trim
- 6. Wood roof trim details and brackets
- 7. Tapered columns with brick piers
- 8. T&G porch deck and ceiling
- 9. Garage materials to match home

Revised Proposal – December 10, 2014

The following is a summary of the plan revisions:

- 1. Adjacent setbacks added.
- 2. The first floor height at porch beam is specified as 10'.
- 3. Porch depth is 6'-6" from thermal wall to inside of columns, 8'-6" to outside of column.
- 4. Porch ceiling material is T&G.
- 5. Photos of adjacent structures included.
- 6. Window and wall sections added.
- 7. Window sizes have been changed on side elevations.
- 8. Gable vents added.

Revised Proposal – January 14, 2015

The following is a summary of the plan revisions:

- 1. Front dormer has been redesigned and set back.
- 2. Window details have been updated to reflect true design.
- 3. Side gable material is wood lap. Gable dimensions redrawn.
- 4. Hand rail detail added.

Policy & Design Guidelines


New construction in Local Historic Districts has an obligation to blend in with the historic character and scale of the Local Historic District in which it is located. Designs for infill projects and other new construction within designated Local Historic Districts must be designed with the surroundings in mind. The Historic District Commission will not specify a particular architectural style or design for new construction projects. The scale, mass and size of a building are often far more important than the decorative details applied. However, well designed stylistic and decorative elements, as well as building materials and landscaping, can give new construction projects the attributes necessary to blend in with the district, while creating a distinctive character for the building. New construction projects in Local Historic Districts must be appropriate to their surroundings.


The Historic District Commission will review the building details for all new construction as part of their evaluation of new construction project proposals.

All New Construction Projects Will Be Evaluated For Compatibility By The Following Criteria		
1. Size	the relationship of the project to its site	
2. Scale	the relationship of the building to those around it	
3. Massing	the relationship of the building's various parts to each other	
4. Fenestration	the placement, style and materials of windows and doors	
5. Rhythm	the relationship of fenestration, recesses and projections	
6. Setback	in relation to setback of immediate surroundings	
7. Materials	proper historic materials or approved substitutes	
8. Context	the overall relationship of the project to its surroundings	
9. Landscaping	as a tool to soften and blend the project with the district	


Staff Analysis


The Commission shall determine if the proposal addresses the unresolved issues and meets the guidelines.

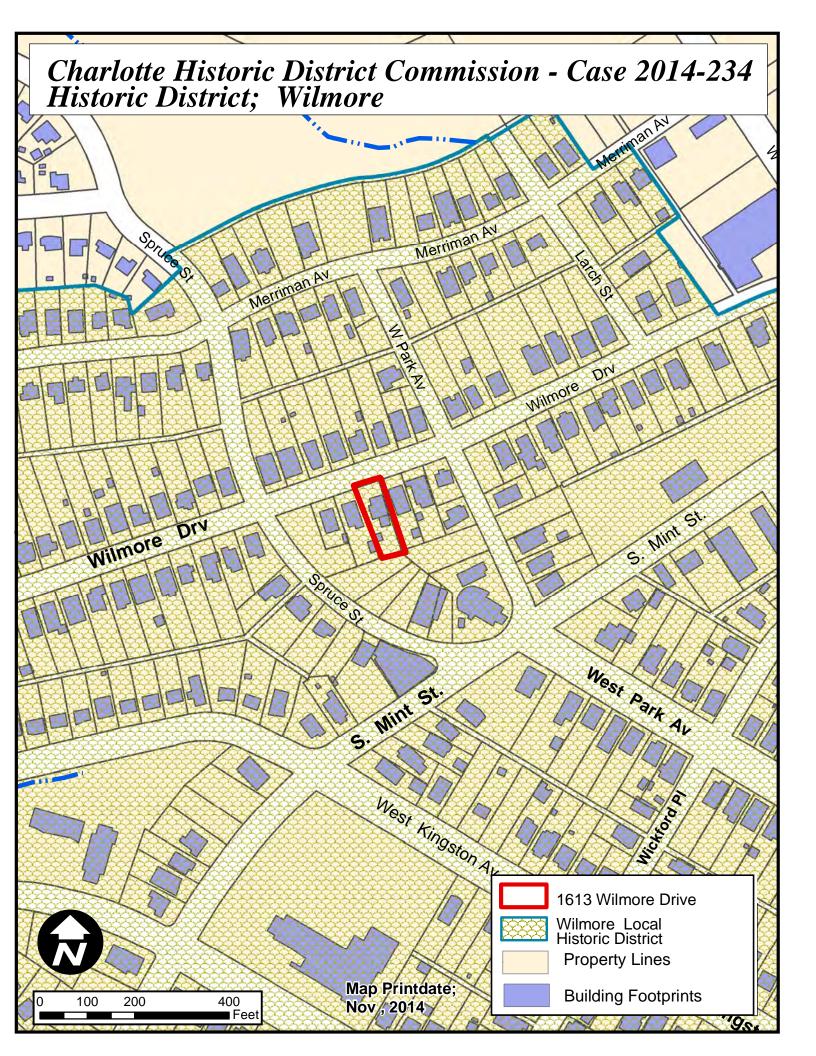


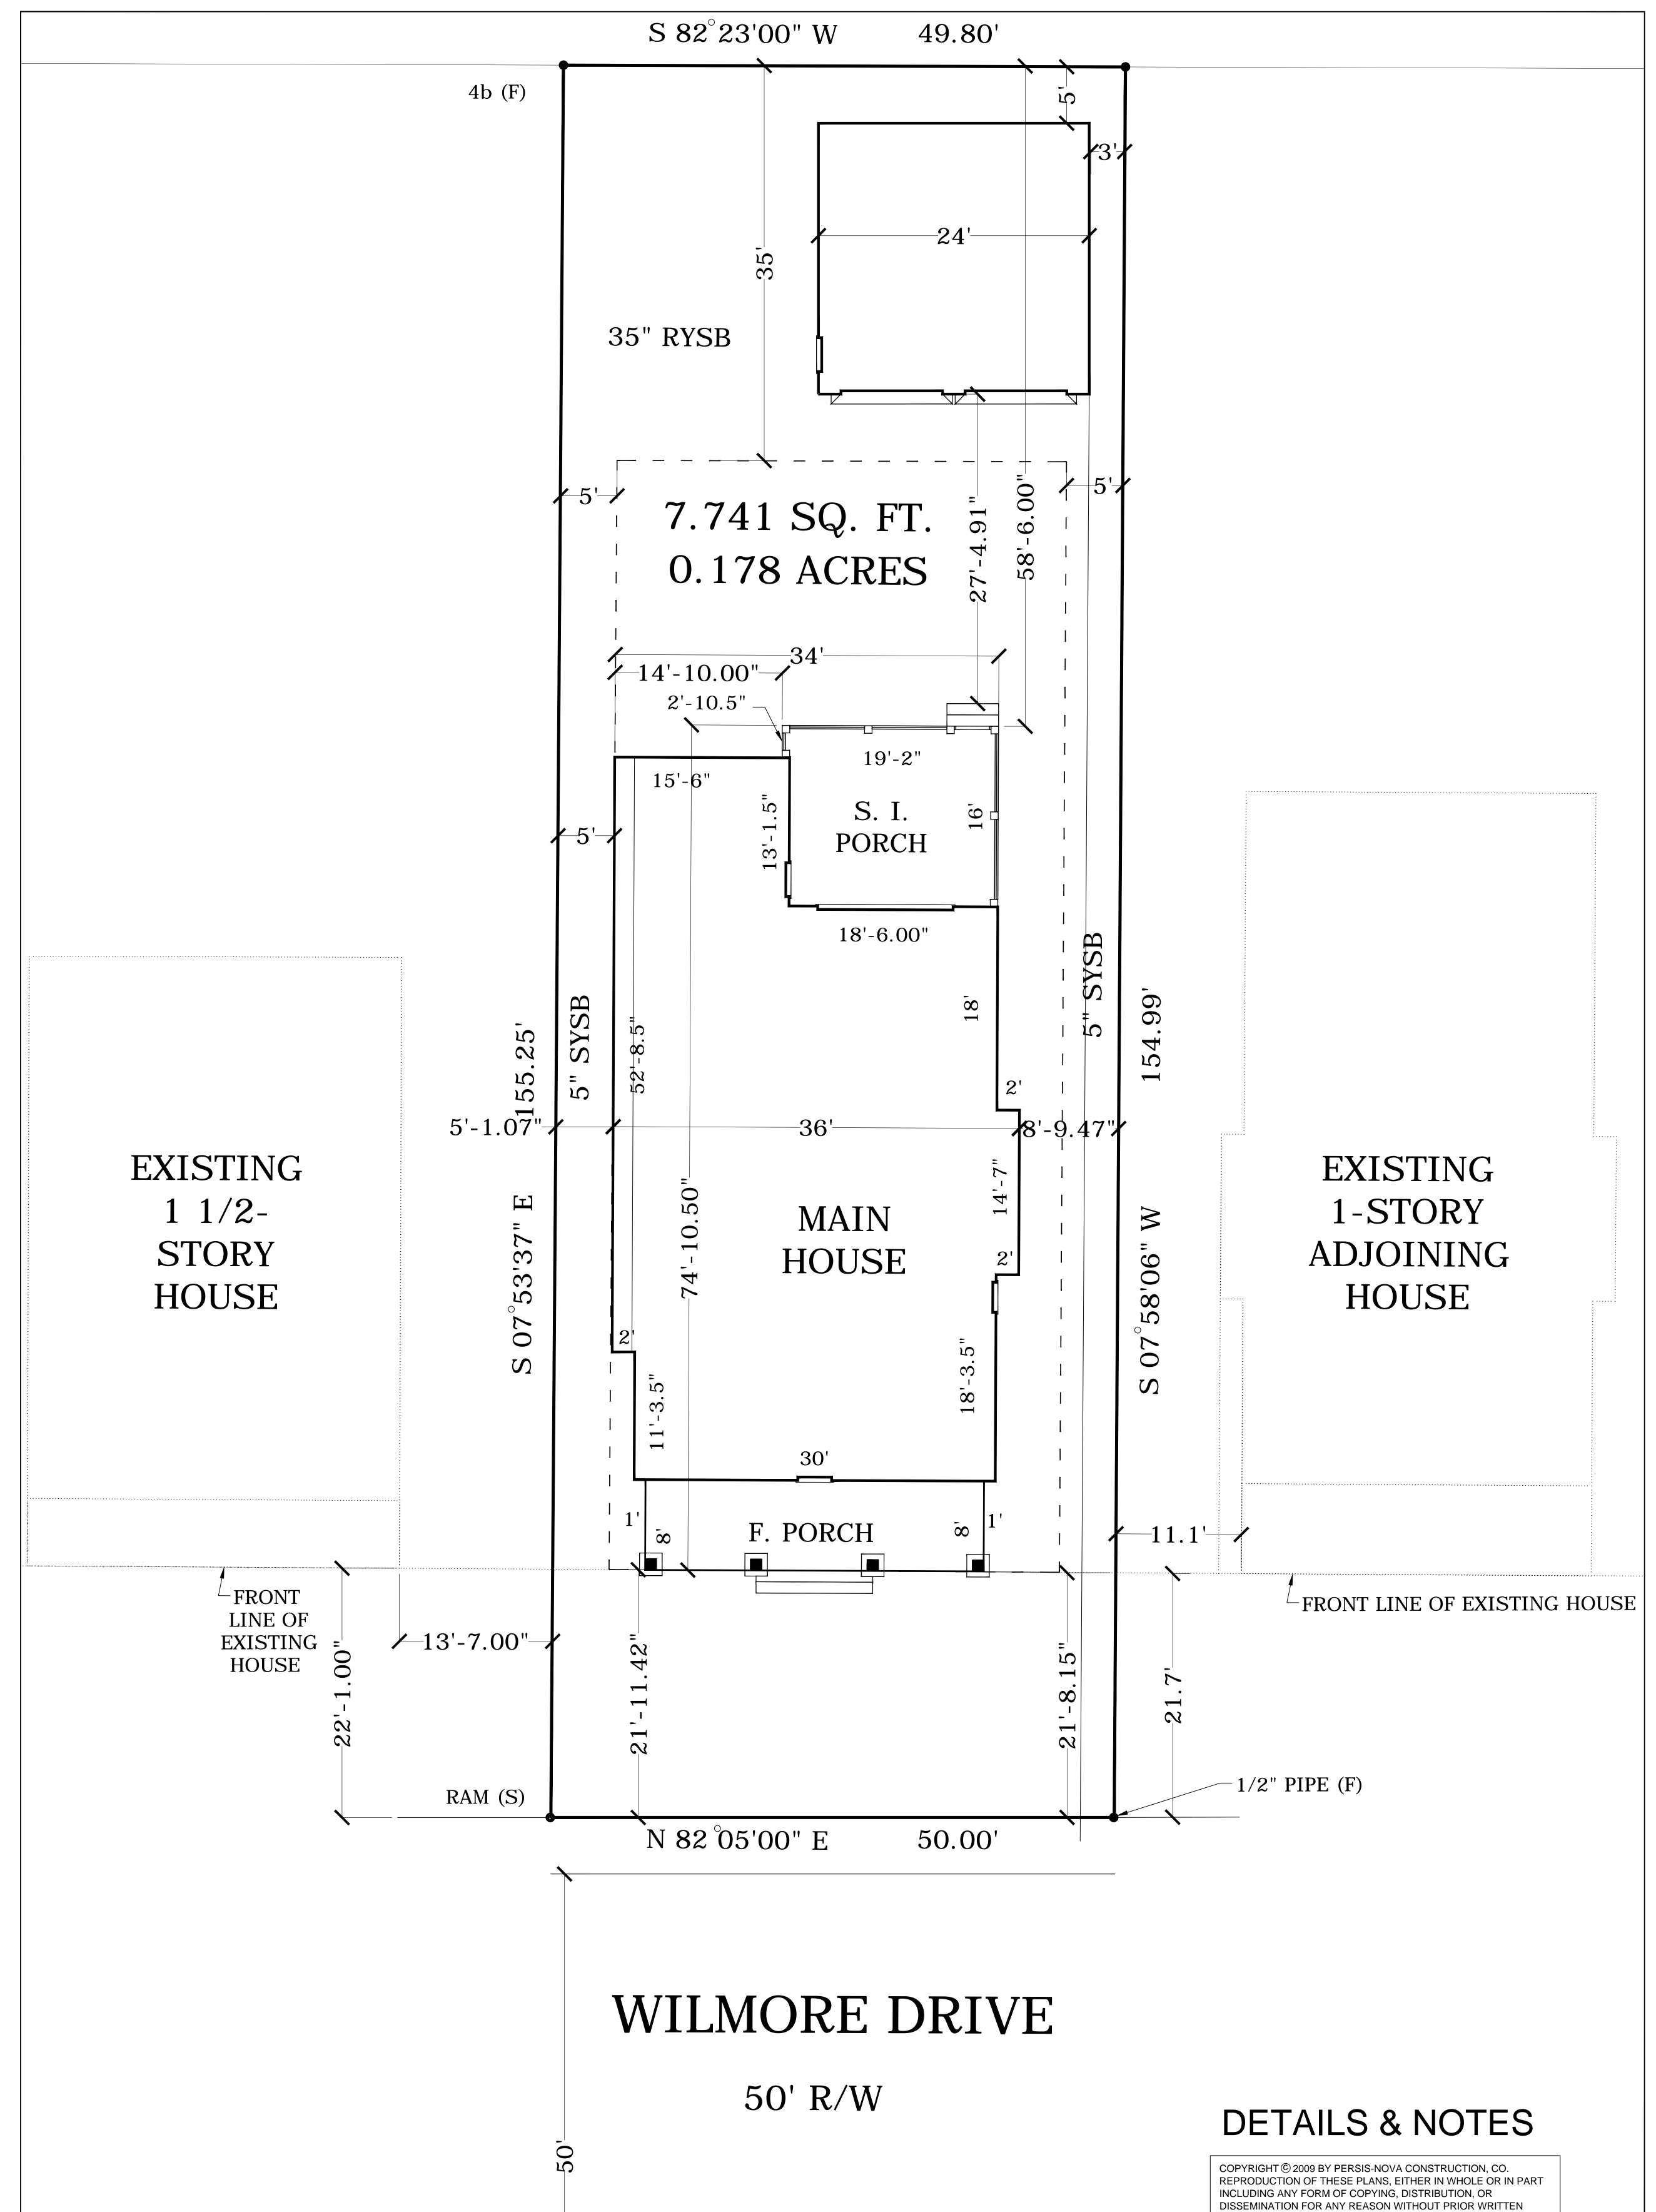

PERMISSION IS STRICTLY PROHIBITED.	
MATT & LAUREN ALEX LOT #8 - 1613 WILMORE	
SCALE: 1/8"=1'-0" APPROVED BY: DATE: 12/01/2014 1111	DRAWN BYMARY C. AIKENS REVISED MARY C. AIKENS
PROPOSED PLOT PLAN	
PERSIS NOVA CONSTRUCTION CO	

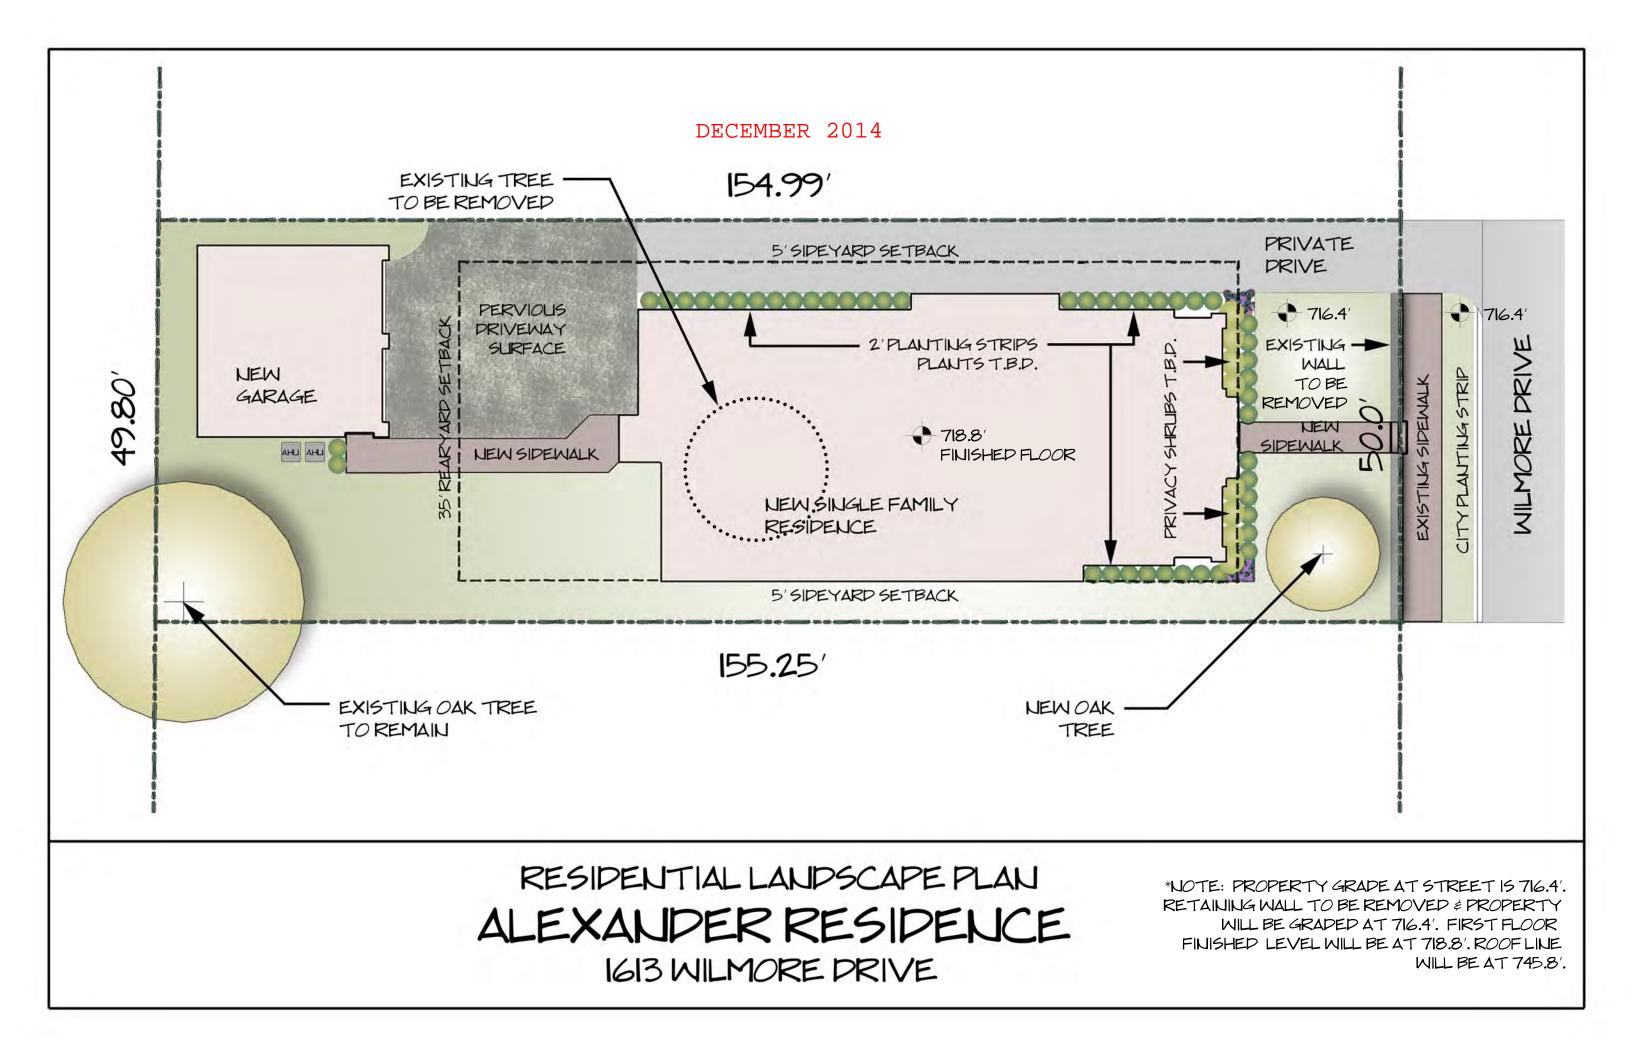

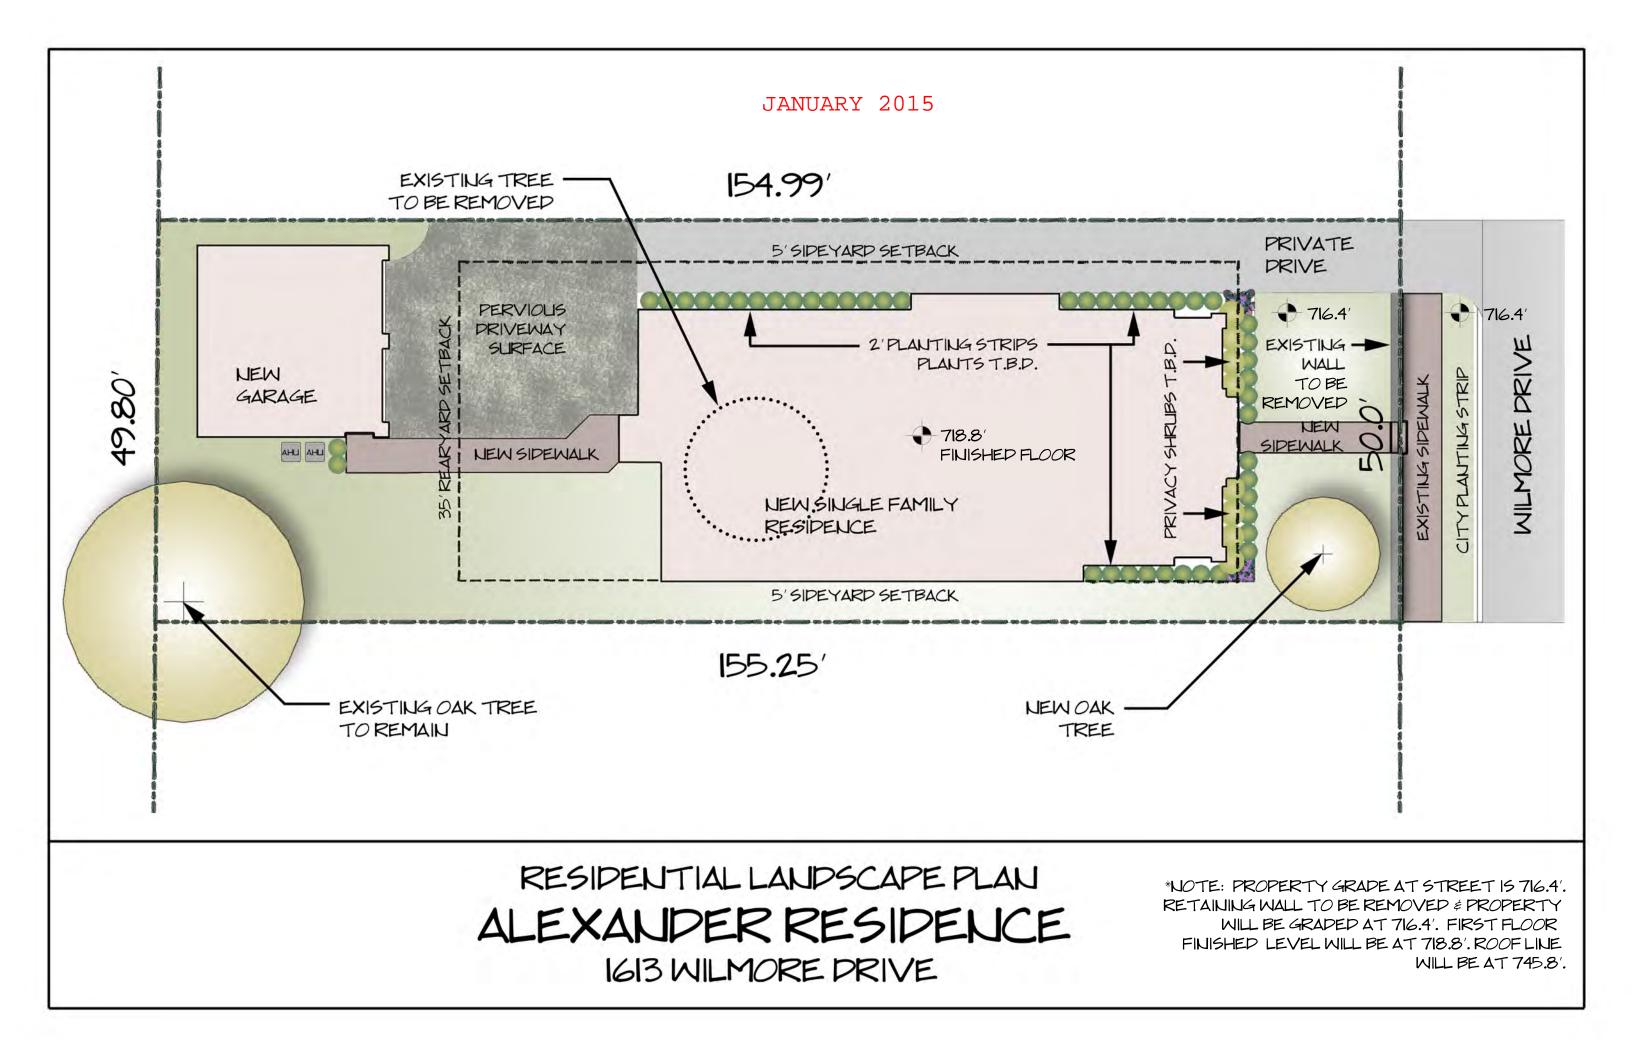

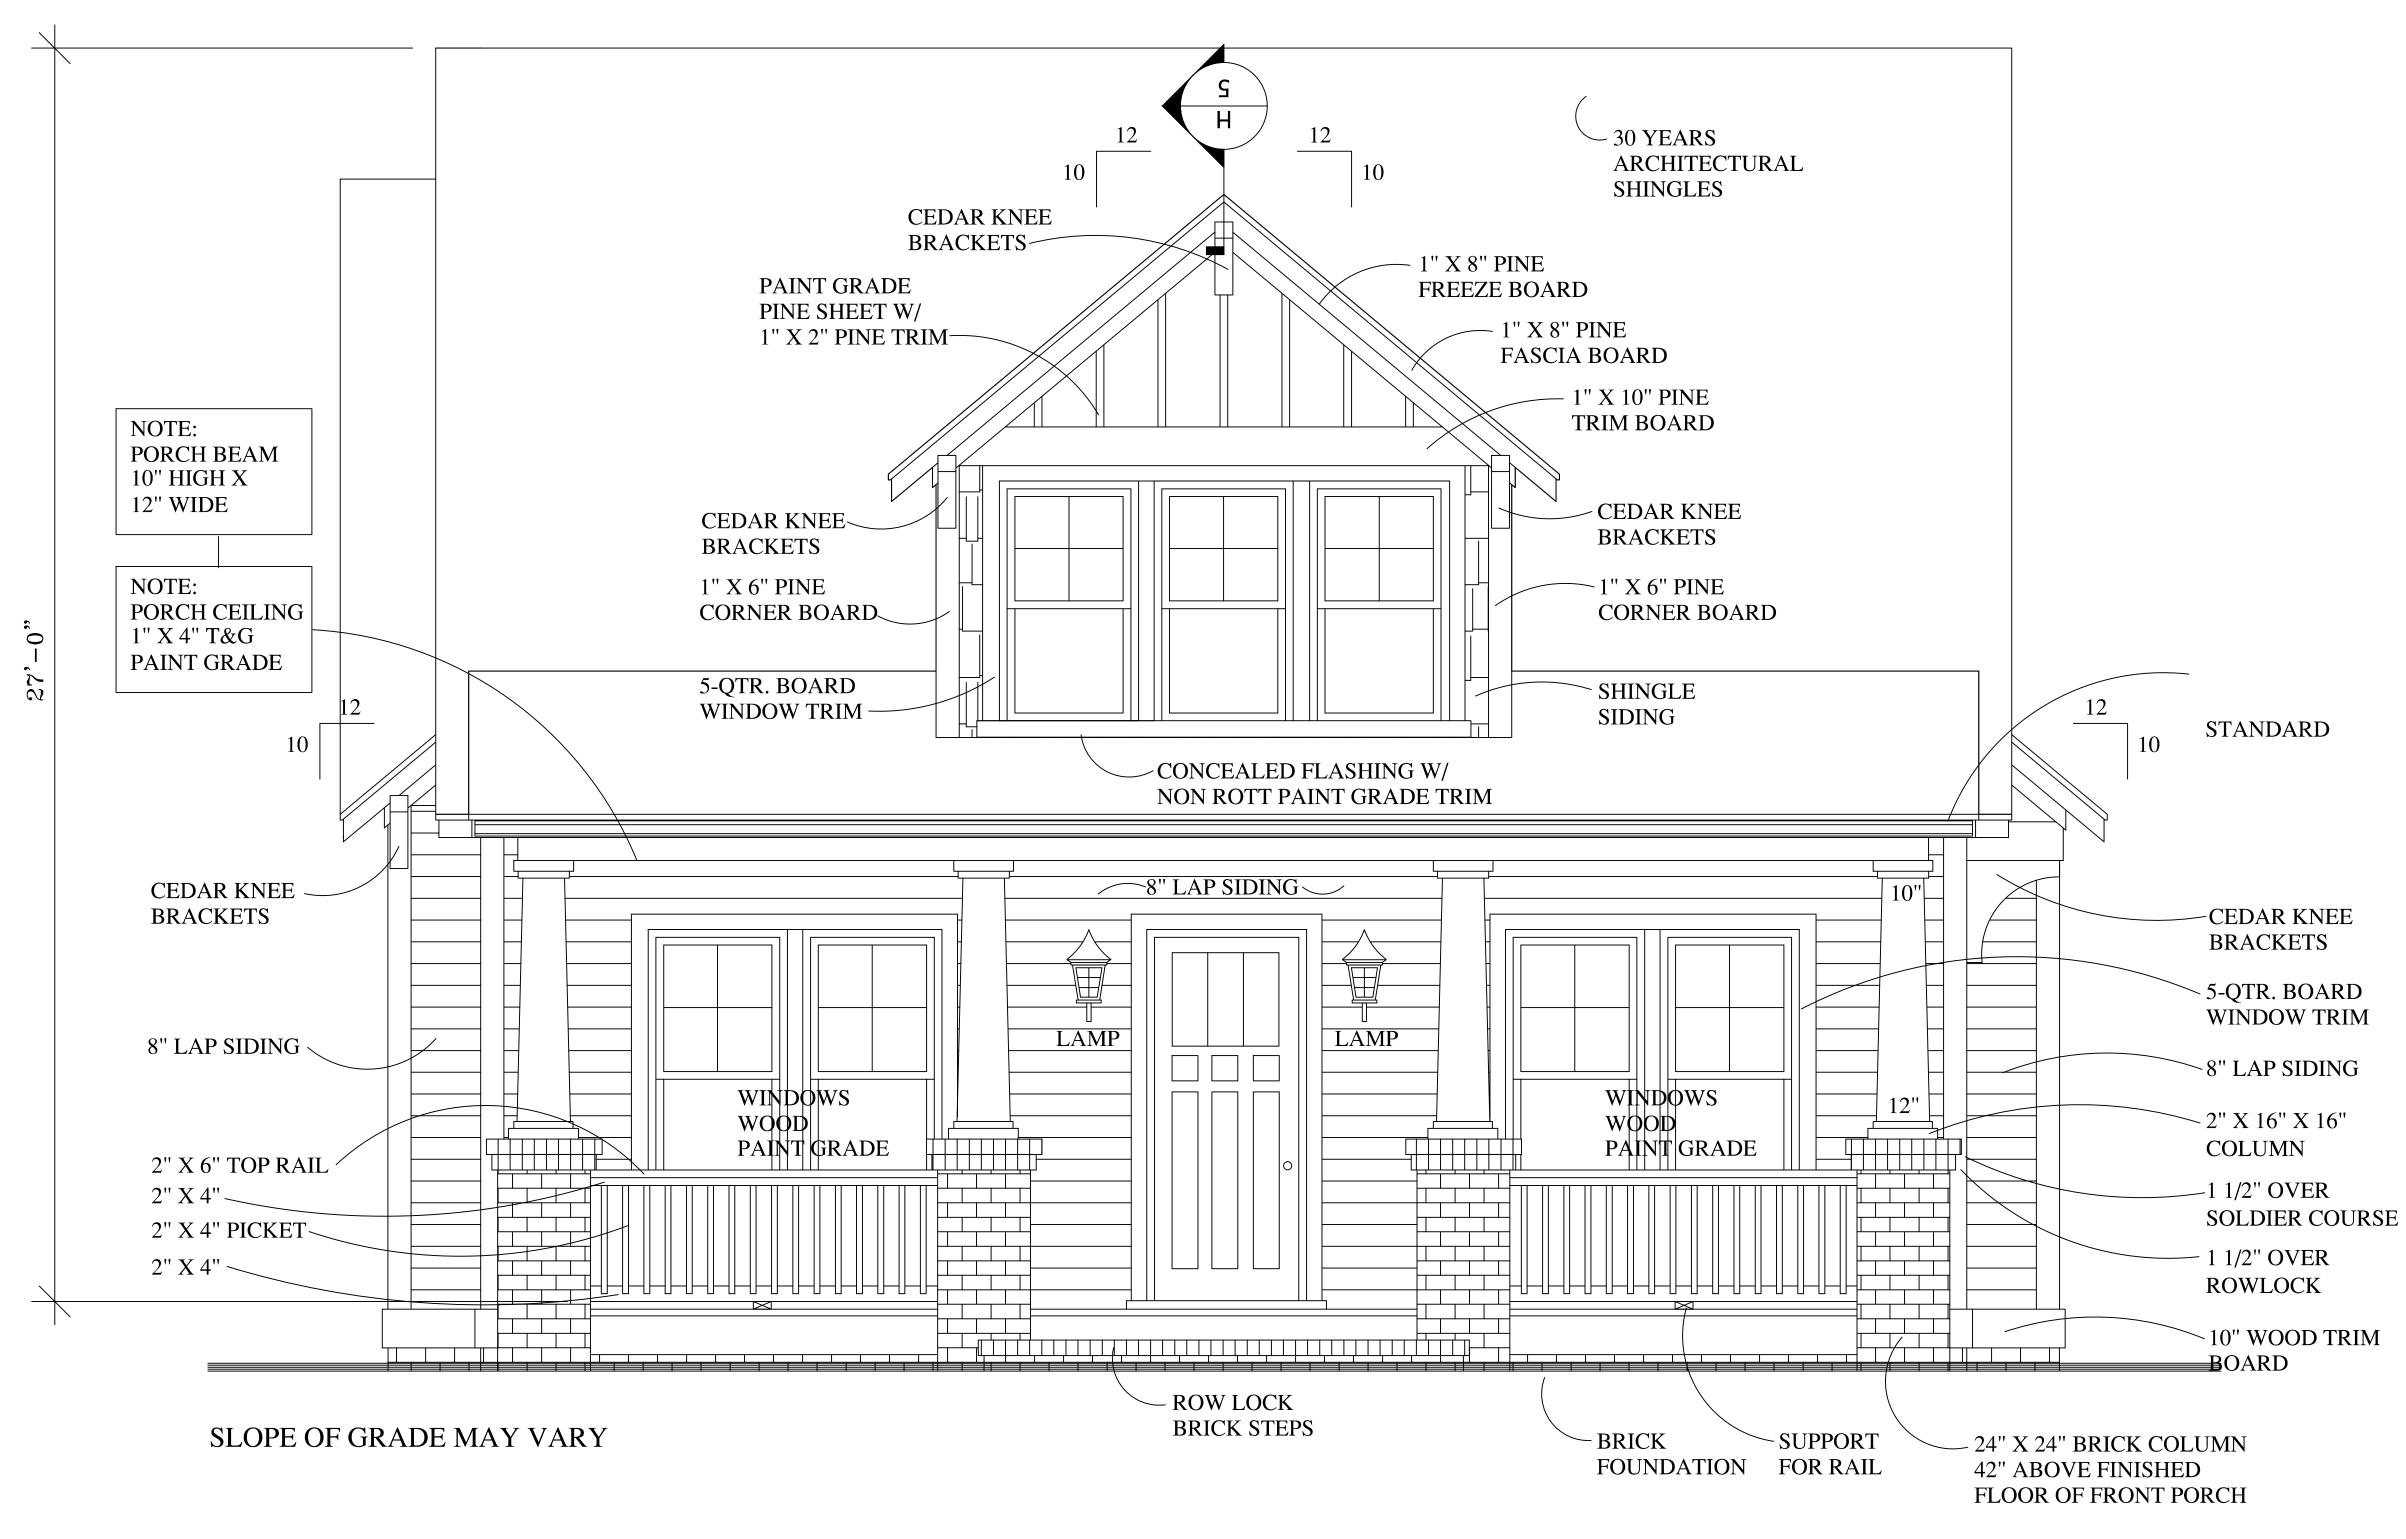



FRONT ELEVATION

SCALE: 1/2" = 1'-0"


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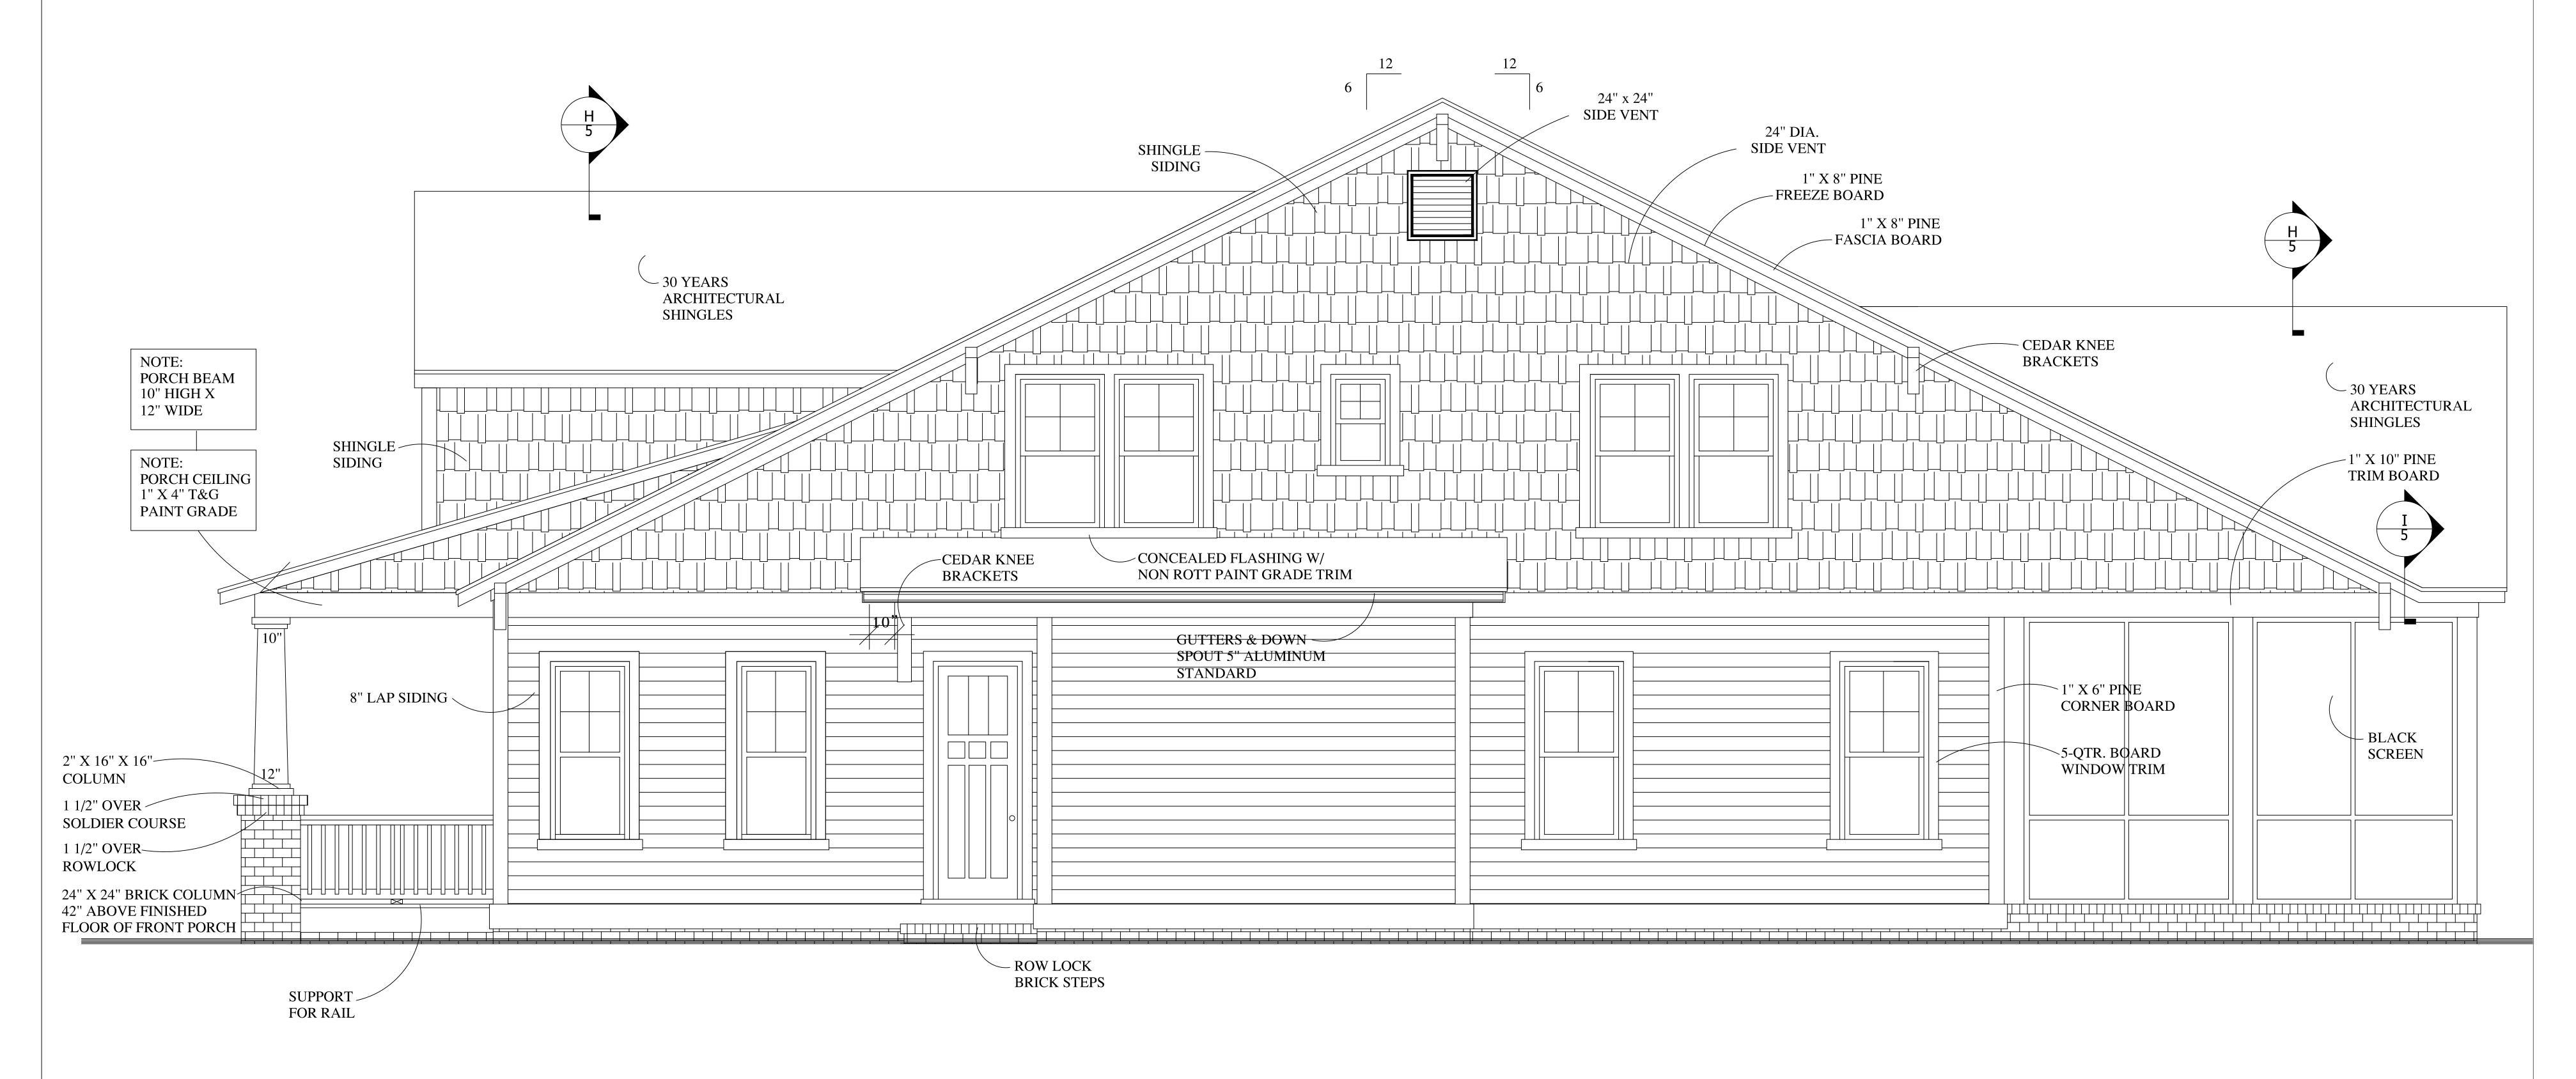
 $\frac{GRAY}{\& DESIGN}$ AFTING INAPOLIS NOR JEFFEREX RESIDENTIAL DRA 1200 SOUTH MAIN STREET KANNI CONTRACTOR SHALL CHECK AND VARIFY ALI DIMENSIONS BEFORE BEGINNING CONSTRUCTION AND COORDINATE ANY CORRECTIONS OR REVISIONS WITH THE OWNER AND DESIGNER. JEFFERY D. GRAY WILL ASSUME NO LIABILITY FOR ANY ERRORS ON CONSTRUCTION BEGINS. PROJECT: ENCE Ĭ RES ER LEX DATE: SEPT. 11, 14 **REVISION:** (R) FILE NUMBER 2014-ALEXANDER SHEET:



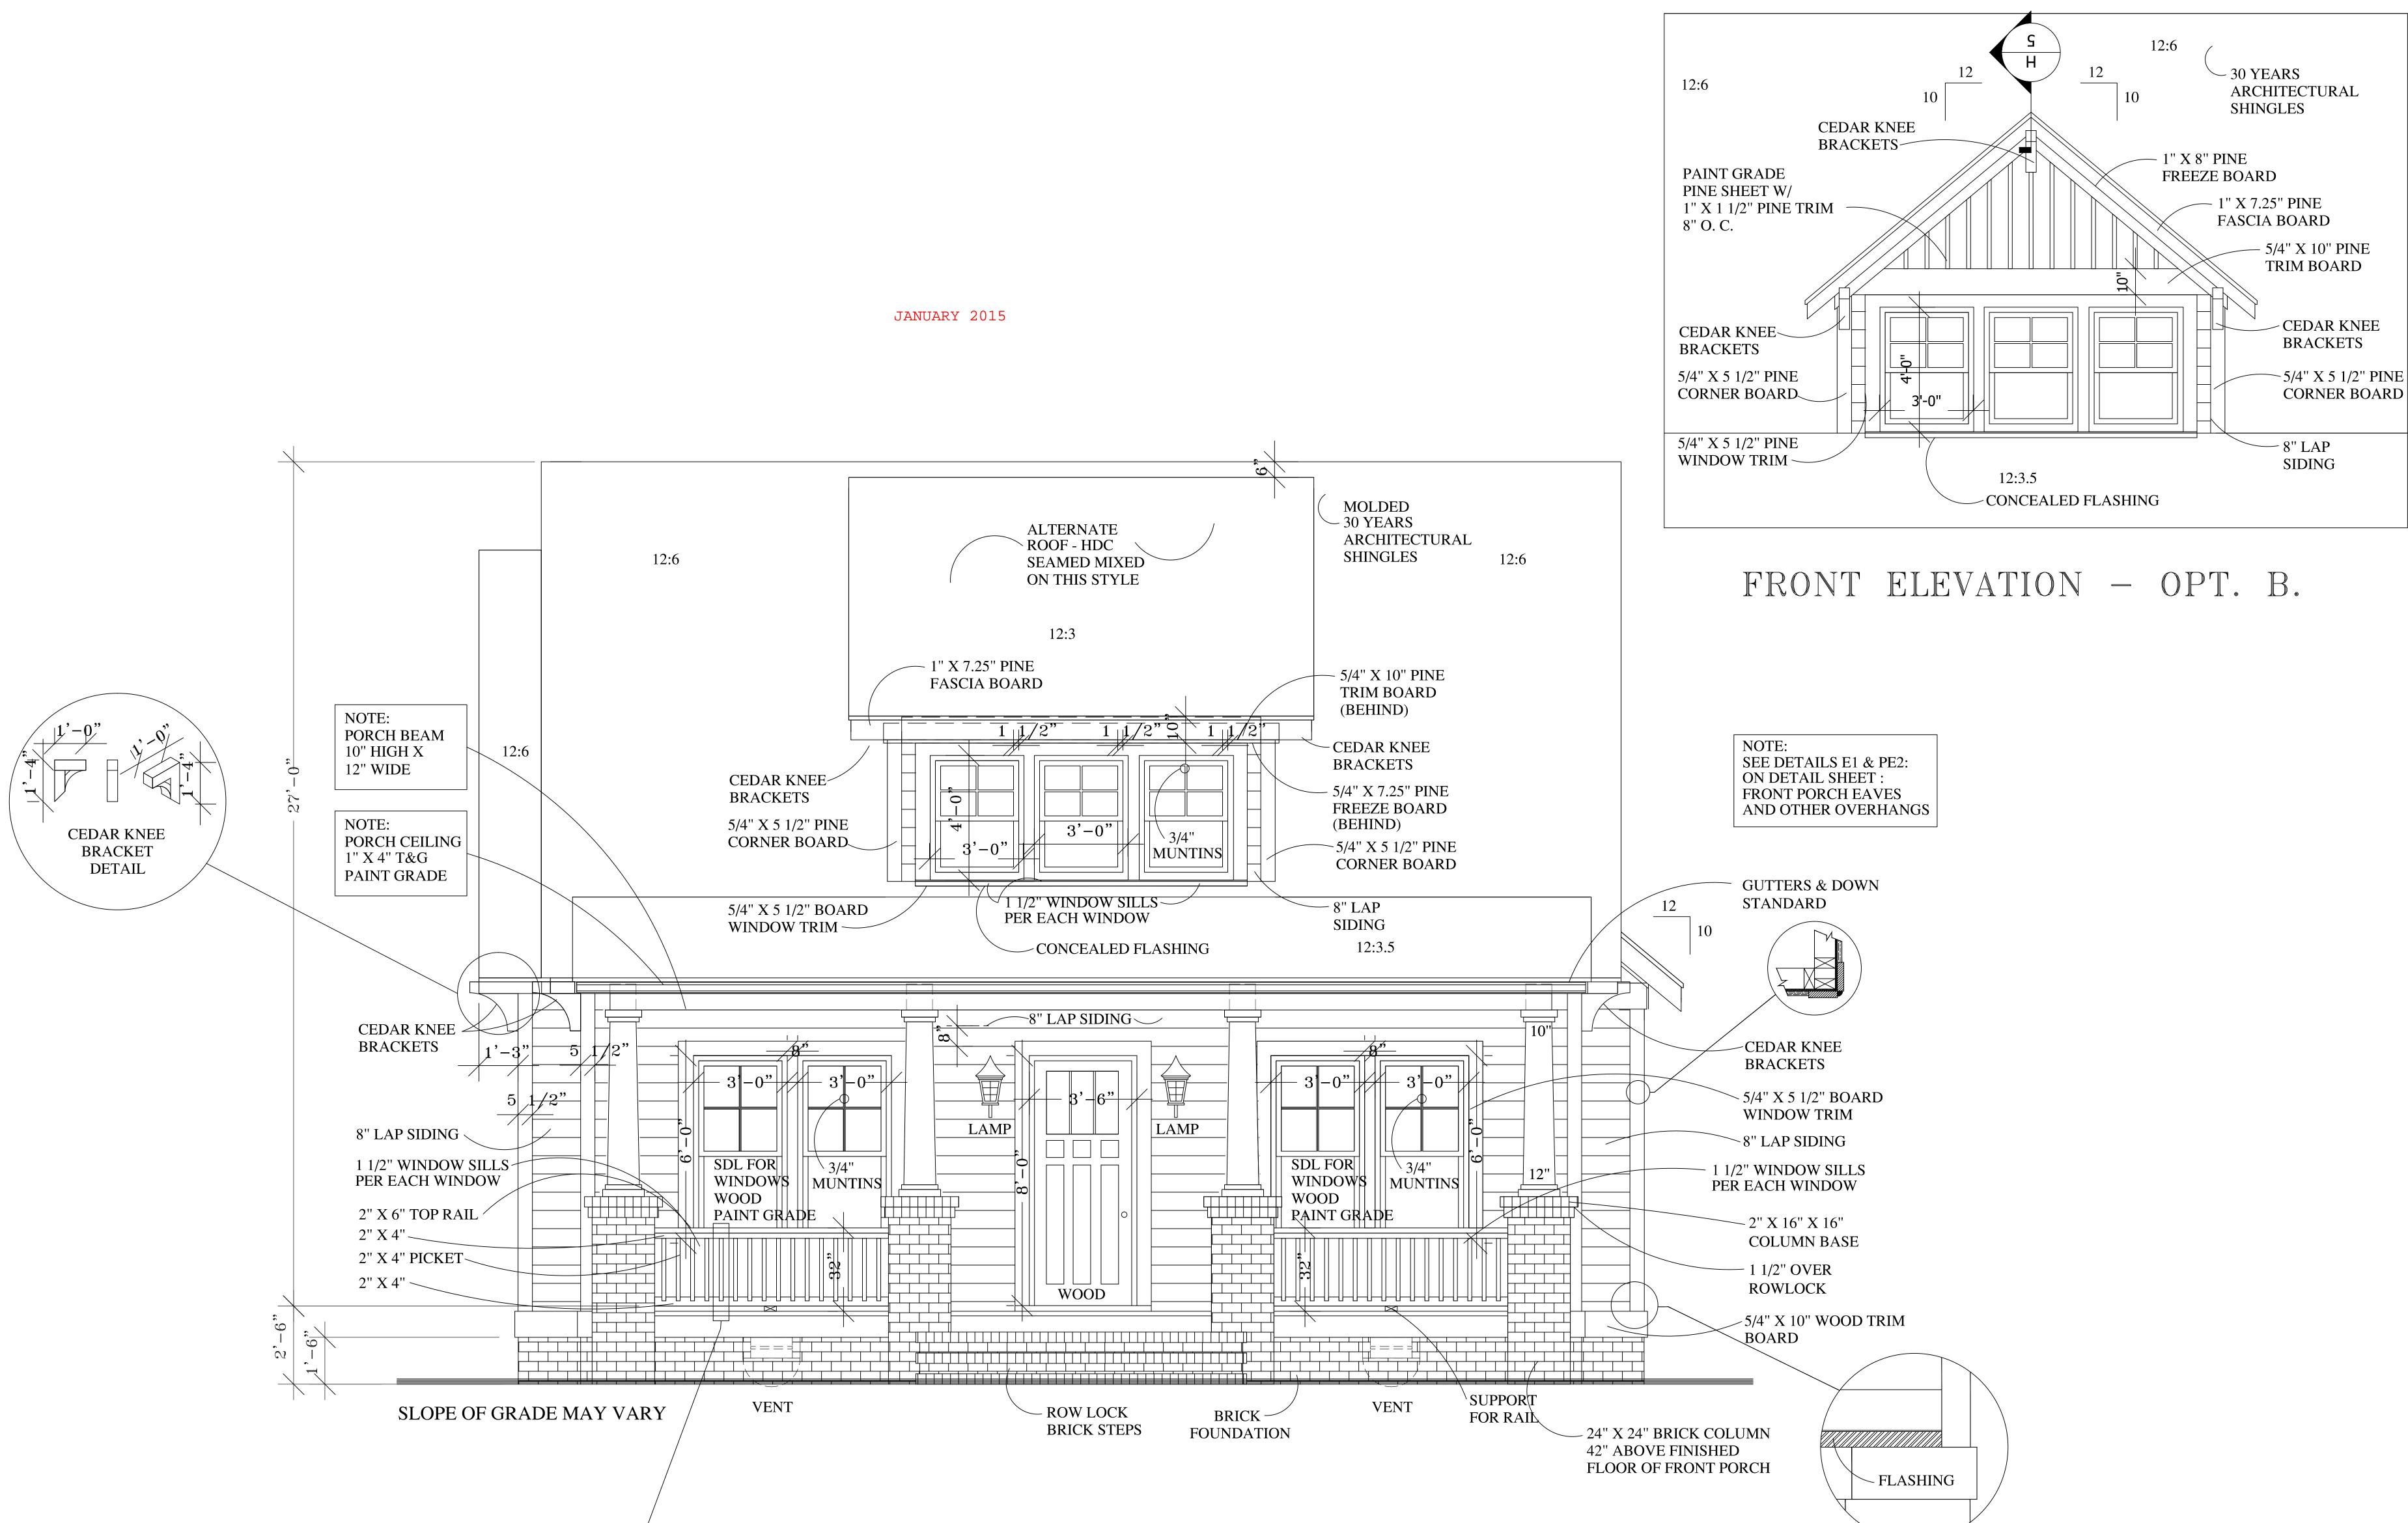

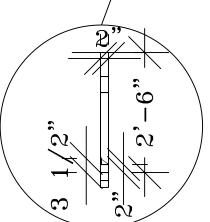FRONT ELEVATION - OPT. A. SCALE: 1/2" = 1'-0"



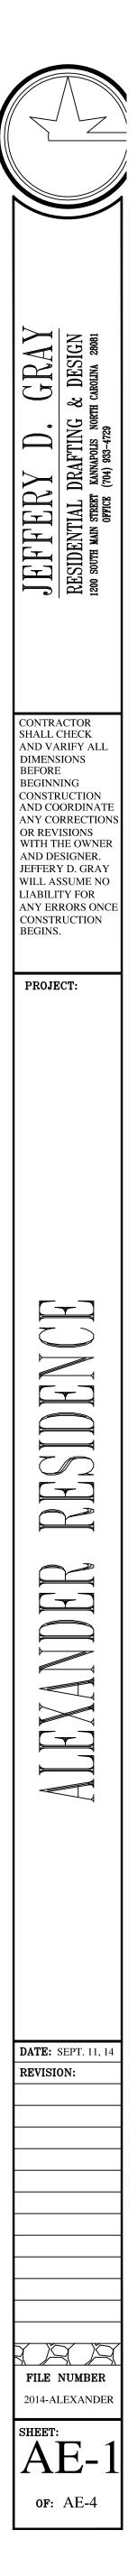

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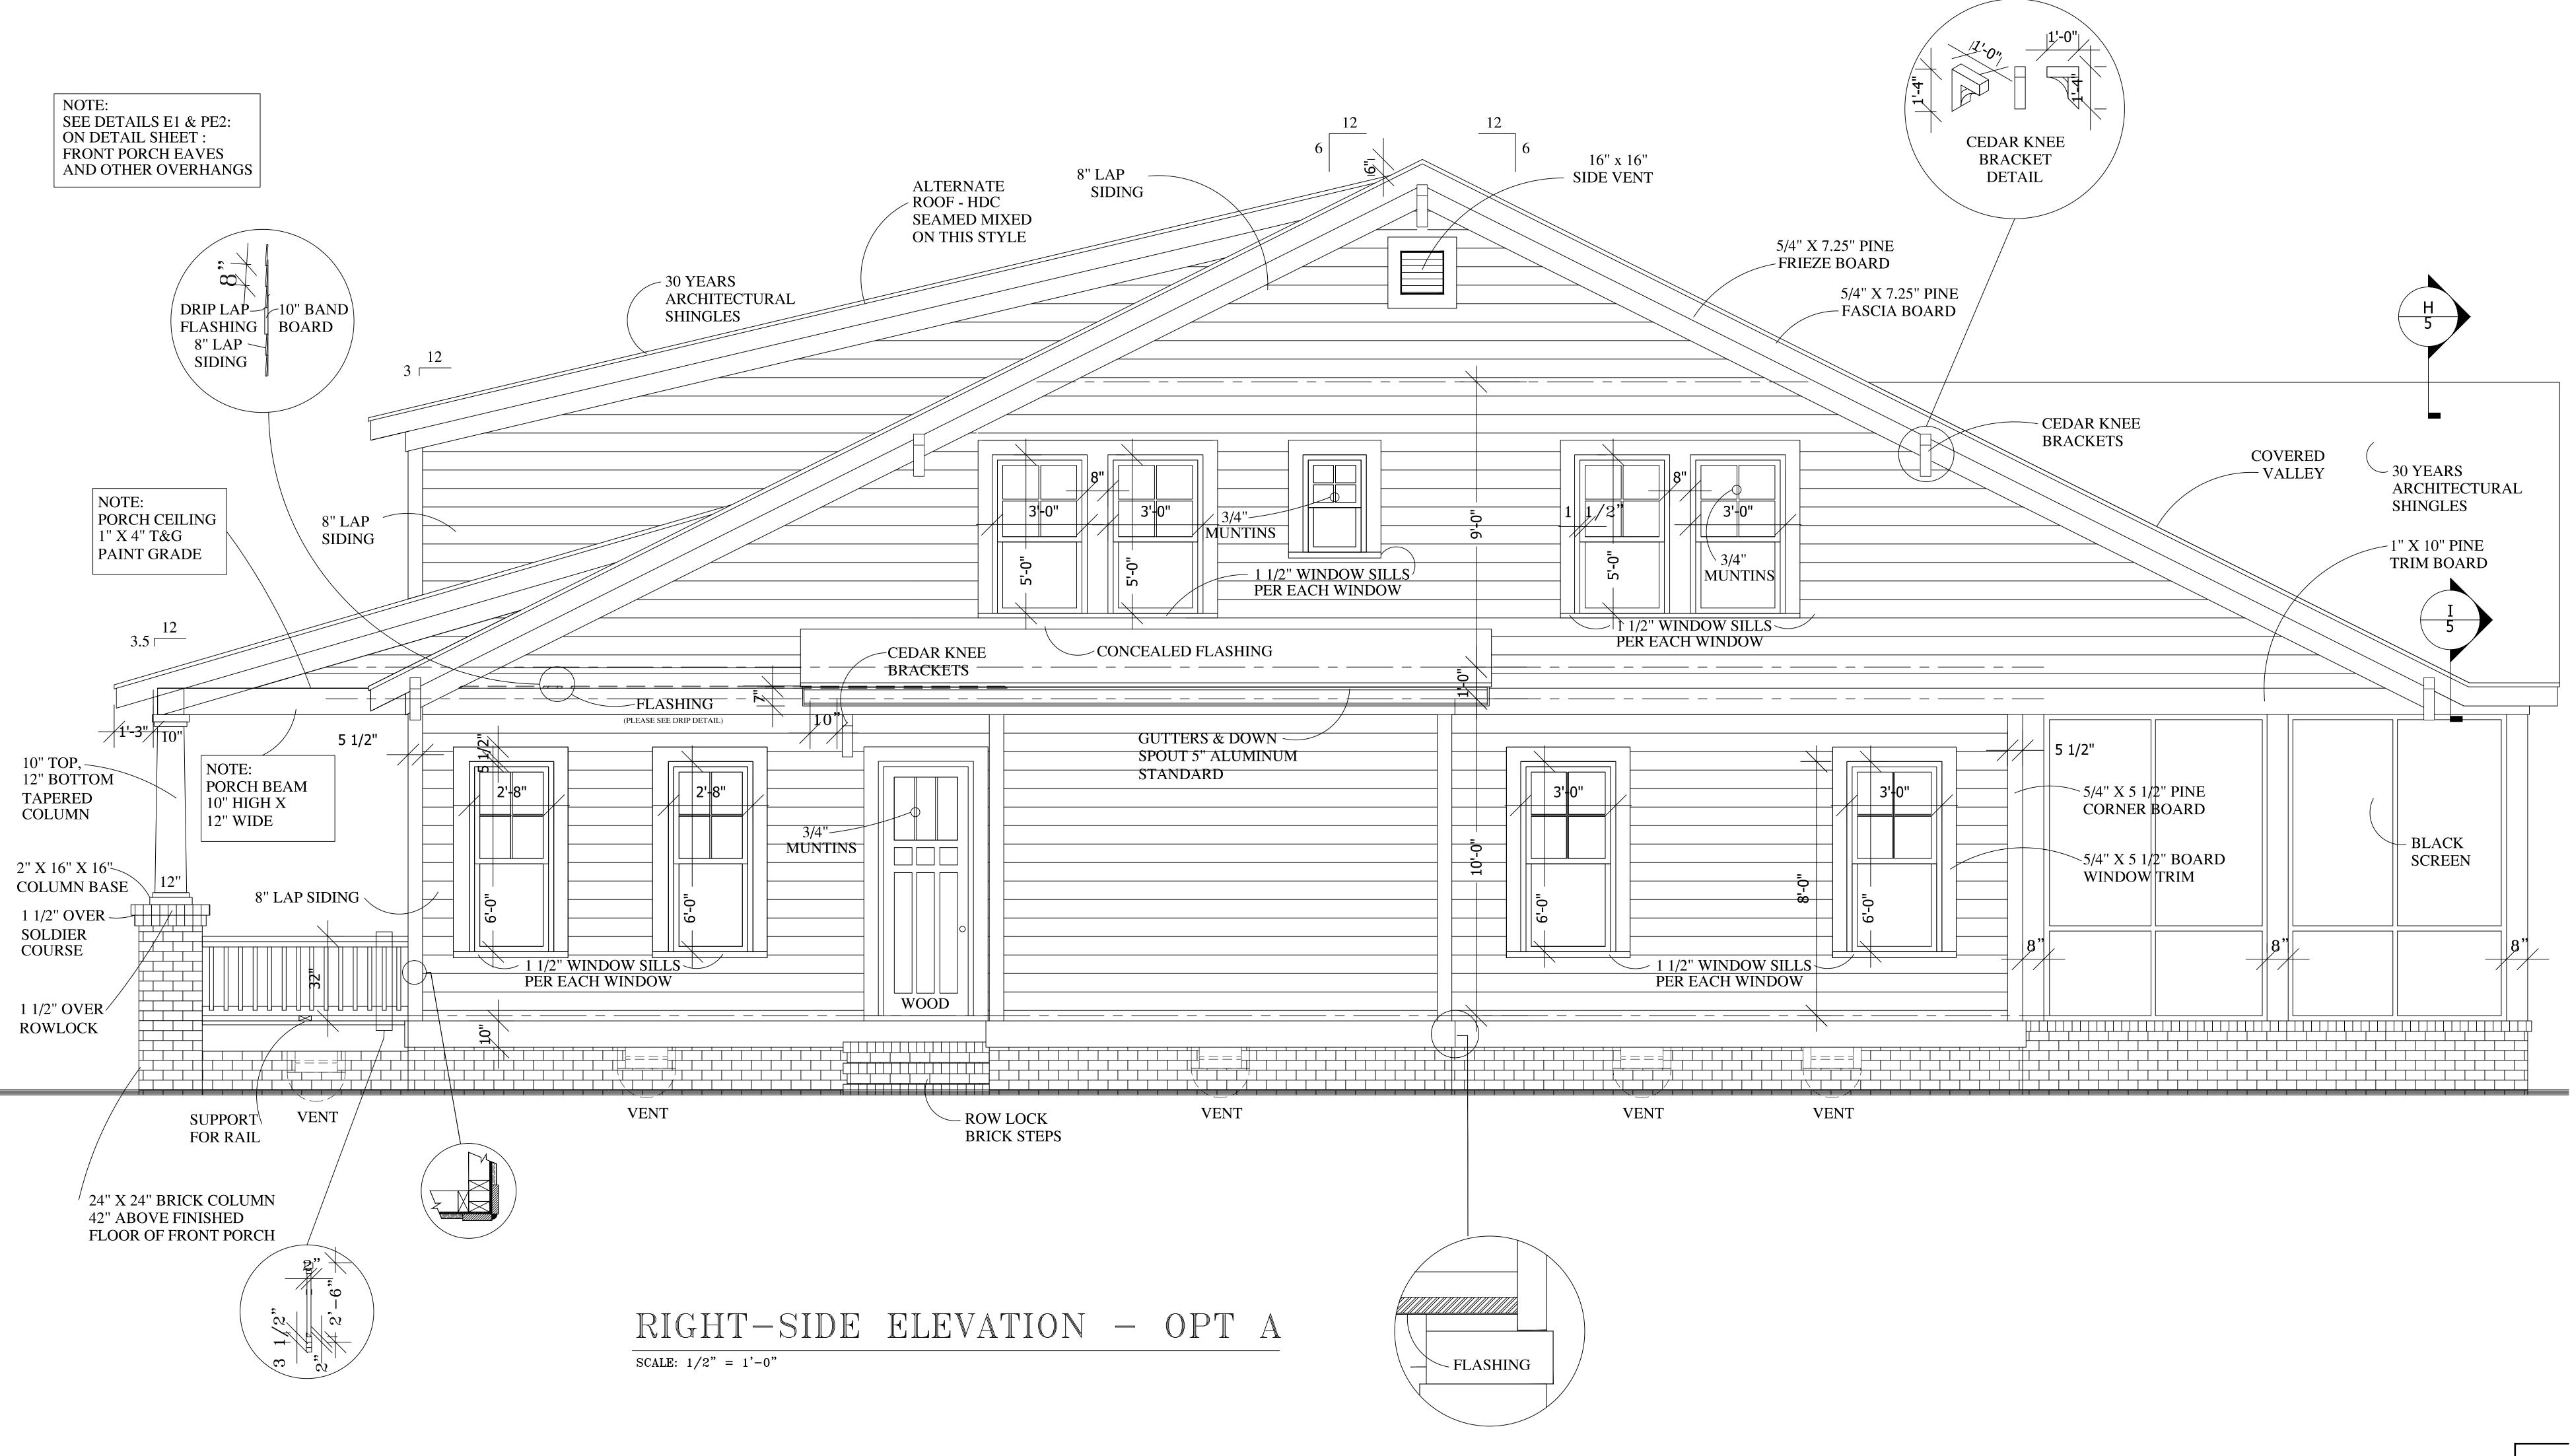
PLAN NOTES:

- CONSTRUCTION. 2. REVIEW SELECTED MECHANICAL SYSTEMS WITH OWNER PRIOR TO CONSTRUCTION. RECOMMENDED LOCATIONS ARE AS FOLLOWS: THE WATER HEATER MAY TYPICALLY BE PLACED IN THE CRAWL SPACE OR IN THE GARAGE. H.V.A.C. UNIT(S) MAY TYPICALLY BE PLACED IN THE CRAWL SPACE OR IN THE ATTIC FOR ON STORY HOUSES, IN THE CRAWL SPACE FOR THE FIRST FLOOR AND IN ATTIC FOR THE SECOND FLOOR IN TWO STORY HOUSES. H.V.A.C. EQUIPMENT IN ATTIC SPACE SHALL BE ACCESSIBLE BY AN OPENING AS LARGE AS THE LARGEST PIECE OF EQUIPMENT AND IN NO CASE LESS THAN 22"X36". 3. SEE STRUCTURAL DRAWINGS FOR ADDITIONAL INFORMATION. 4. INSULATE AROUND ALL BATHS AND UTILITY ROOM.
- 5. TYPICAL WALL 2X4'S @ 16" O.C. UNLESS OTHERWISE DIMENSIONED.
- 6. PROVIDE SMOKE DETECTORS AS REQUIRED BY CODE.
- 7. PROVIDE DOORBELLS, TRANSFORMER, AND CHIME.

RIGHT-SIDE ELEVATION

SCALE: 1/2" = 1'-0"

1. VERIFY ALL LOCAL CODES, ENERGY TYPES, AND SITE CONDITIONS PRIOR TO




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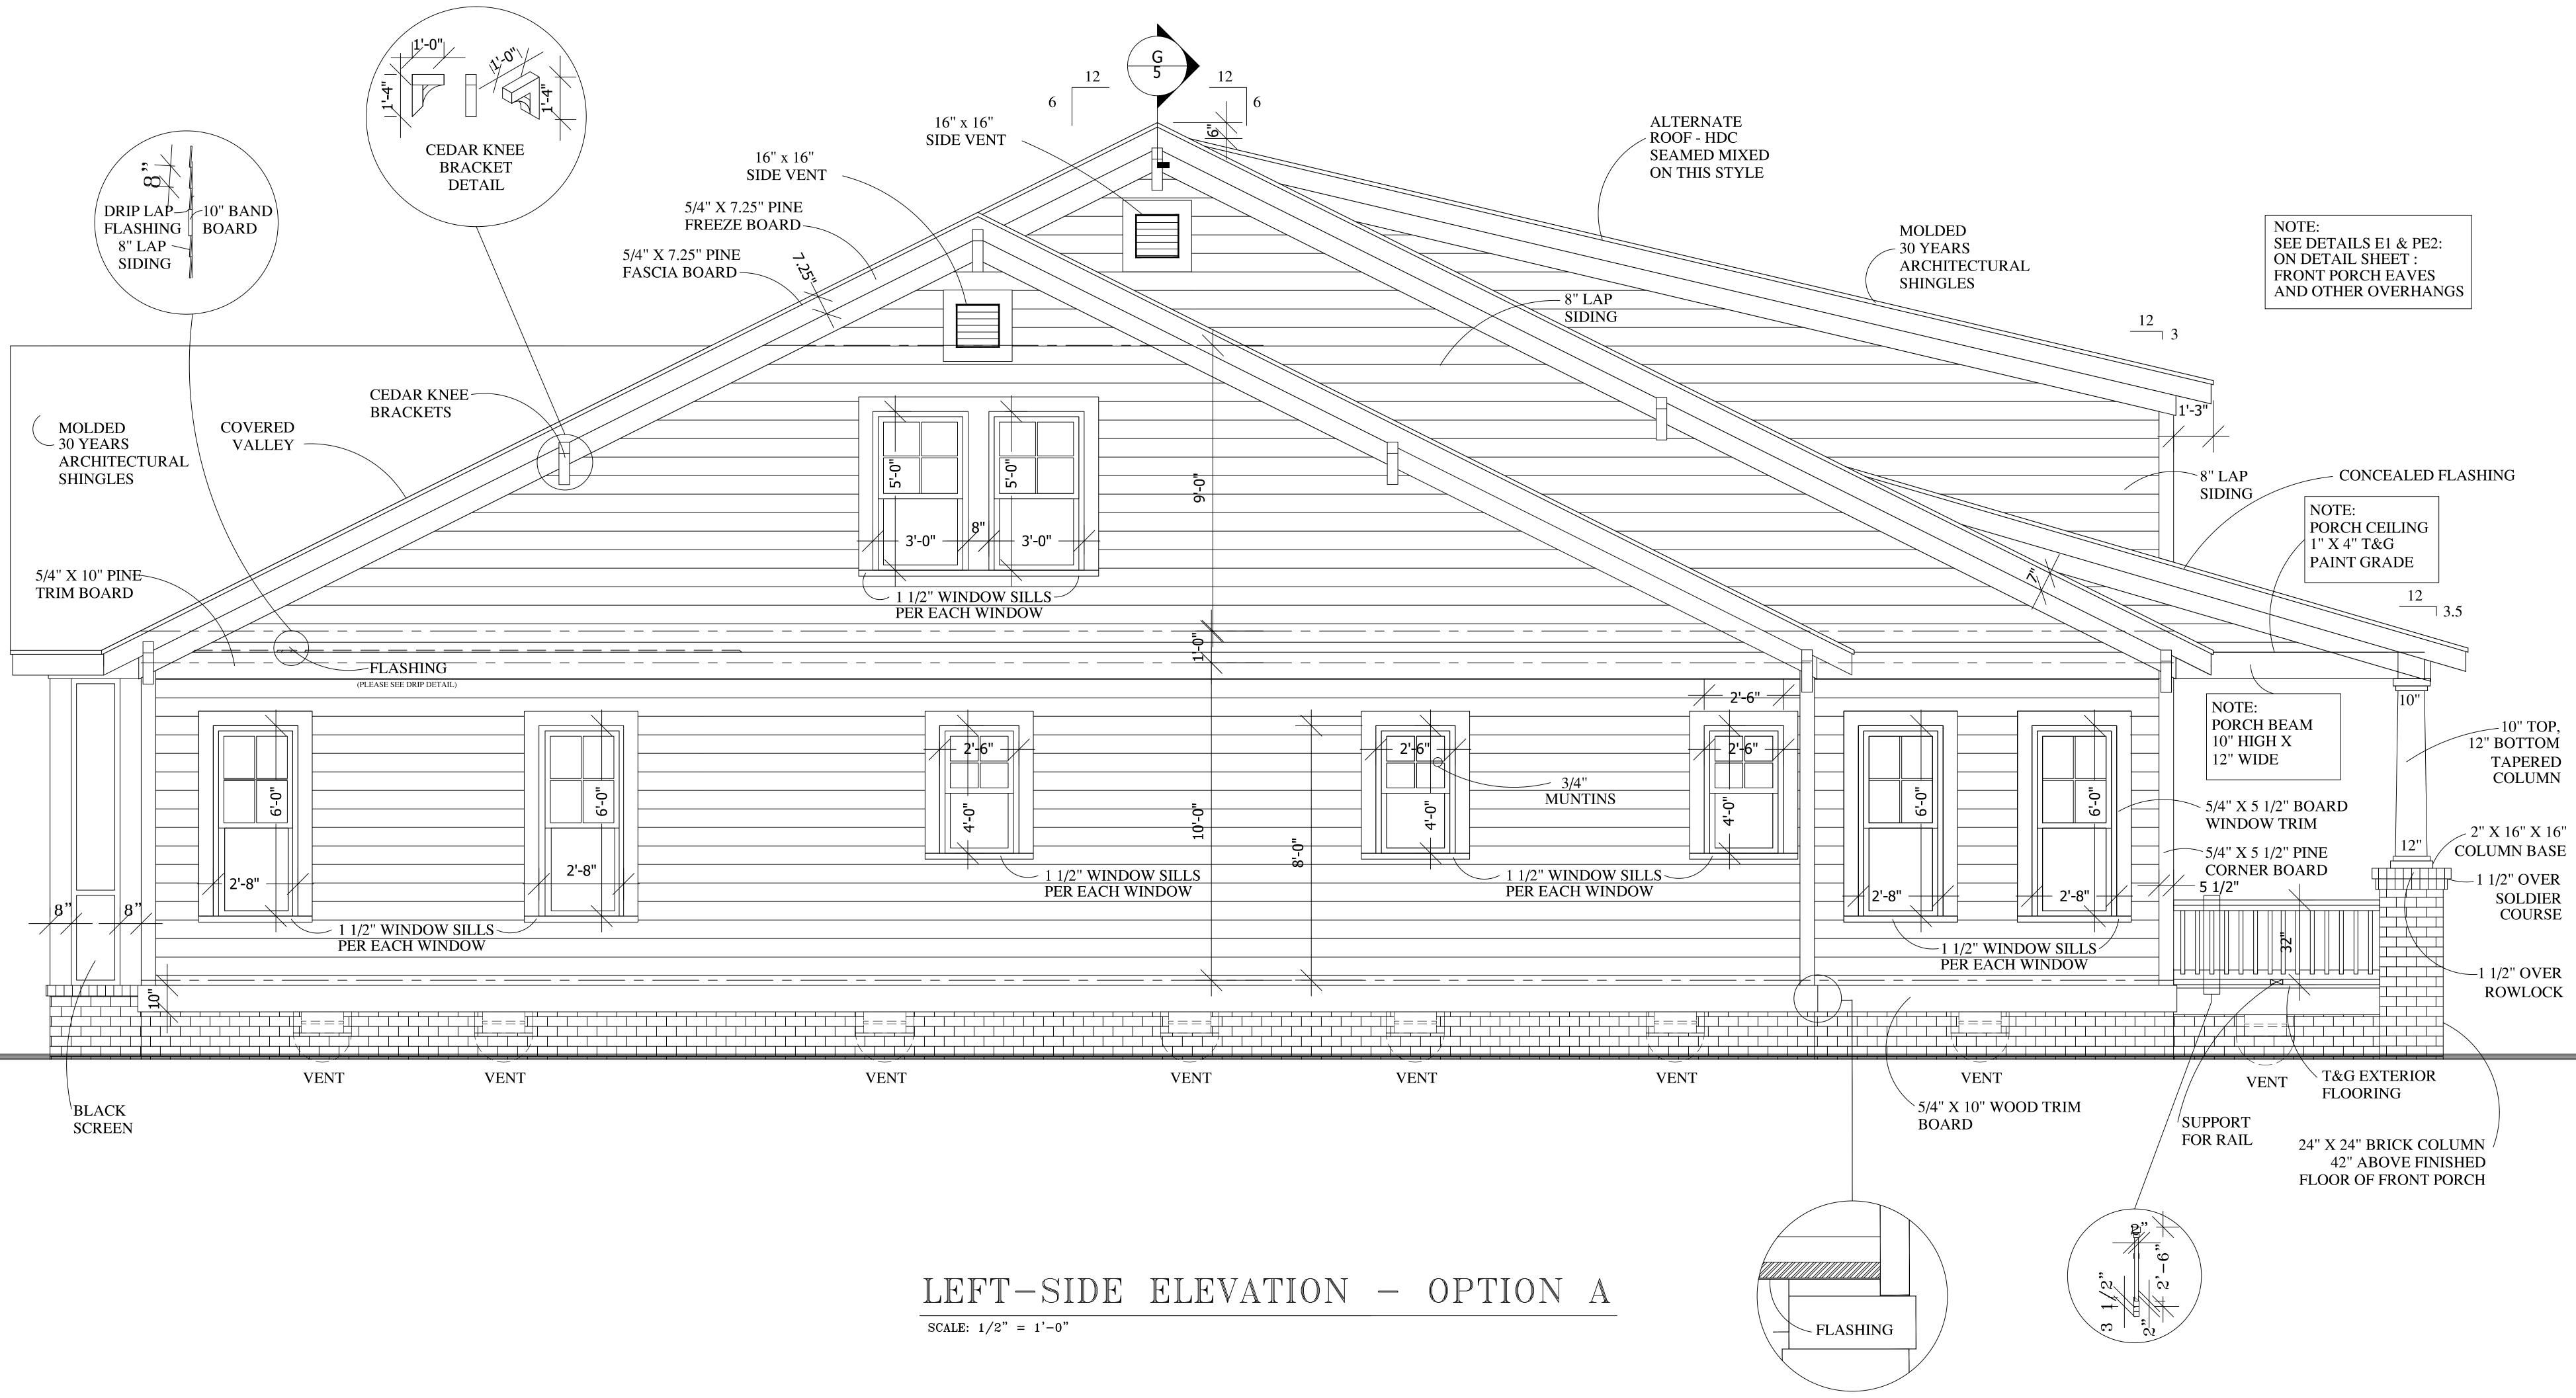
]	PLAN NOTES:
1.	VERIFY ALL LOCAL CODES, ENERGY TYPES, AND SITE CONDITIONS PRIOR TO CONSTRUCTION.
2.	REVIEW SELECTED MECHANICAL SYSTEMS WITH OWNER PRIOR TO CONSTRUCTION. RECOMMENDED LOCATIONS ARE AS FOLLOWS: THE WATER HEATER MAY TYPICALLY BE PLACED IN THE CRAWL SPACE OR IN THE GARAGE. H.V.A.C. UNIT(S) MAY TYPICALLY BE PLACED IN THE CRAWL SPACE OR IN TH ATTIC FOR ON STORY HOUSES, IN THE CRAWL SPACE FOR THE FIRST FLOOR AND IN ATTIC FOR THE SECOND FLOOR IN TWO STORY HOUSES. H.V.A.C. EQUIPMENT IN ATTIC SPACE SHALL BE ACCESSIBLE BY AN OPENING LARGE AS THE LARGEST PIECE OF EQUIPMENT AND IN NO CASE LESS THAN 22"X36".
3.	SEE STRUCTURAL DRAWINGS FOR ADDITIONAL INFORMATION.
4.	INSULATE AROUND ALL BATHS AND UTILITY ROOM.
5.	TYPICAL WALL 2X4'S 🐵 16" O.C. UNLESS OTHERWISE DIMENSIONED.
6.	PROVIDE SMOKE DETECTORS AS REQUIRED BY CODE.
7.	PROVIDE DOORBELLS, TRANSFORMER, AND CHIME.

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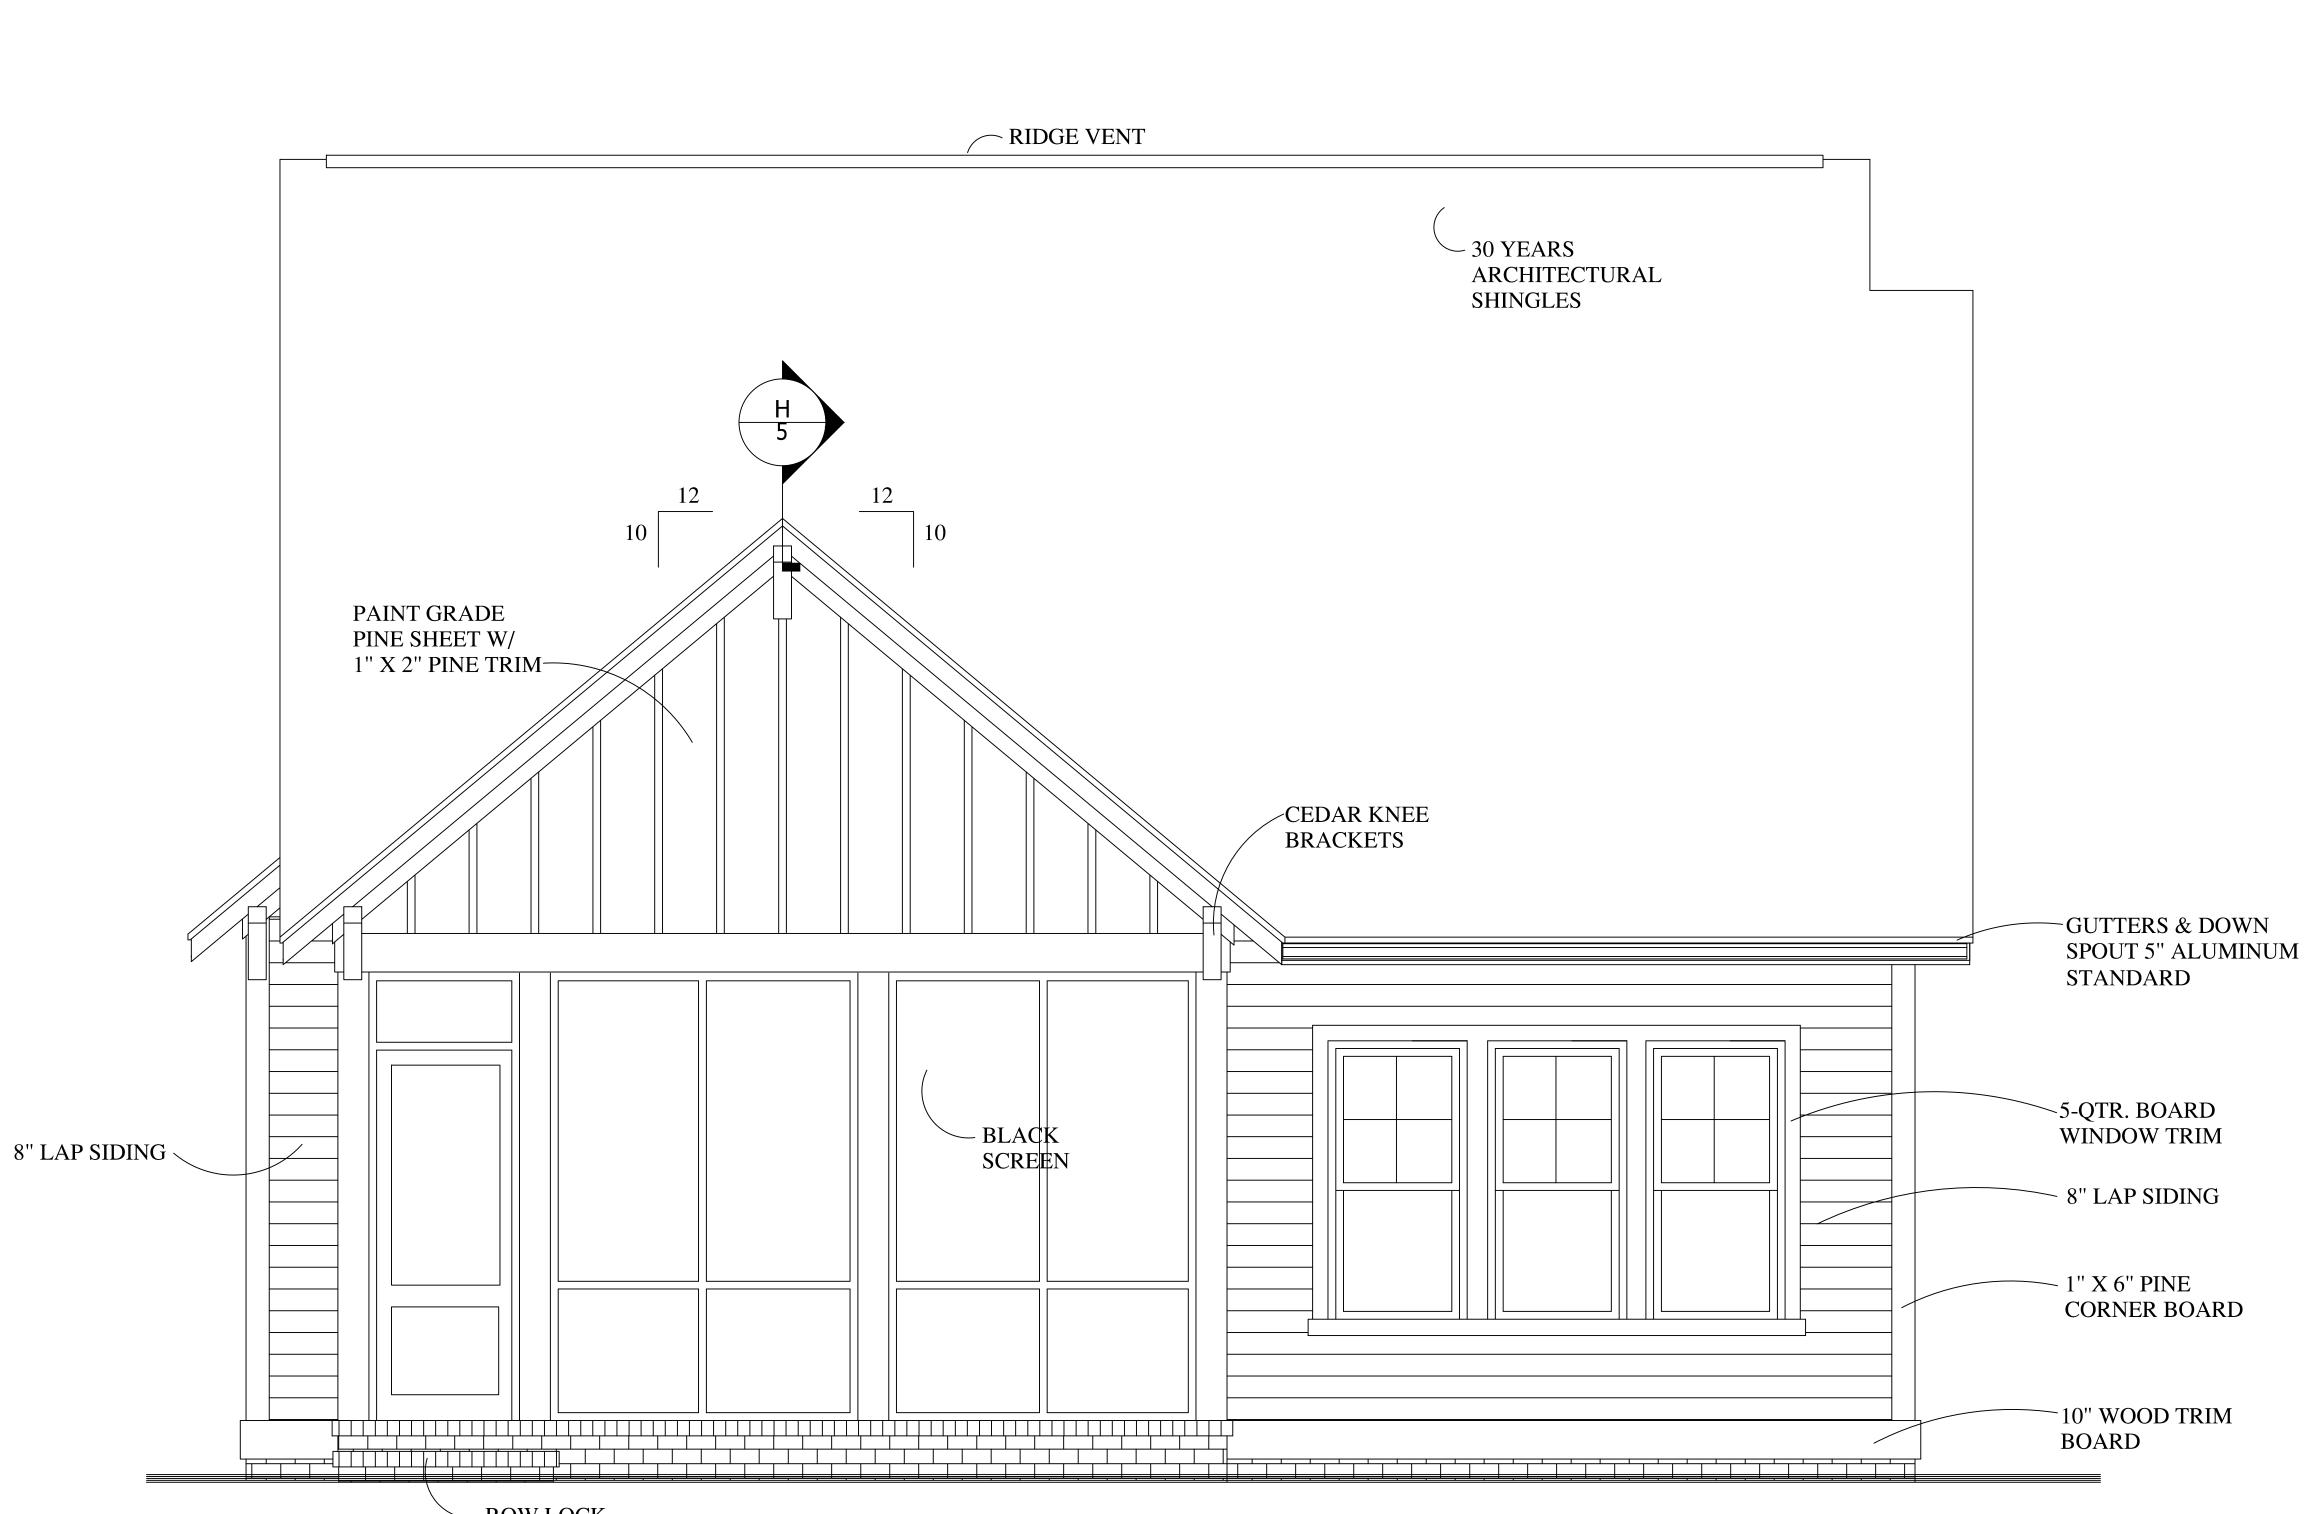


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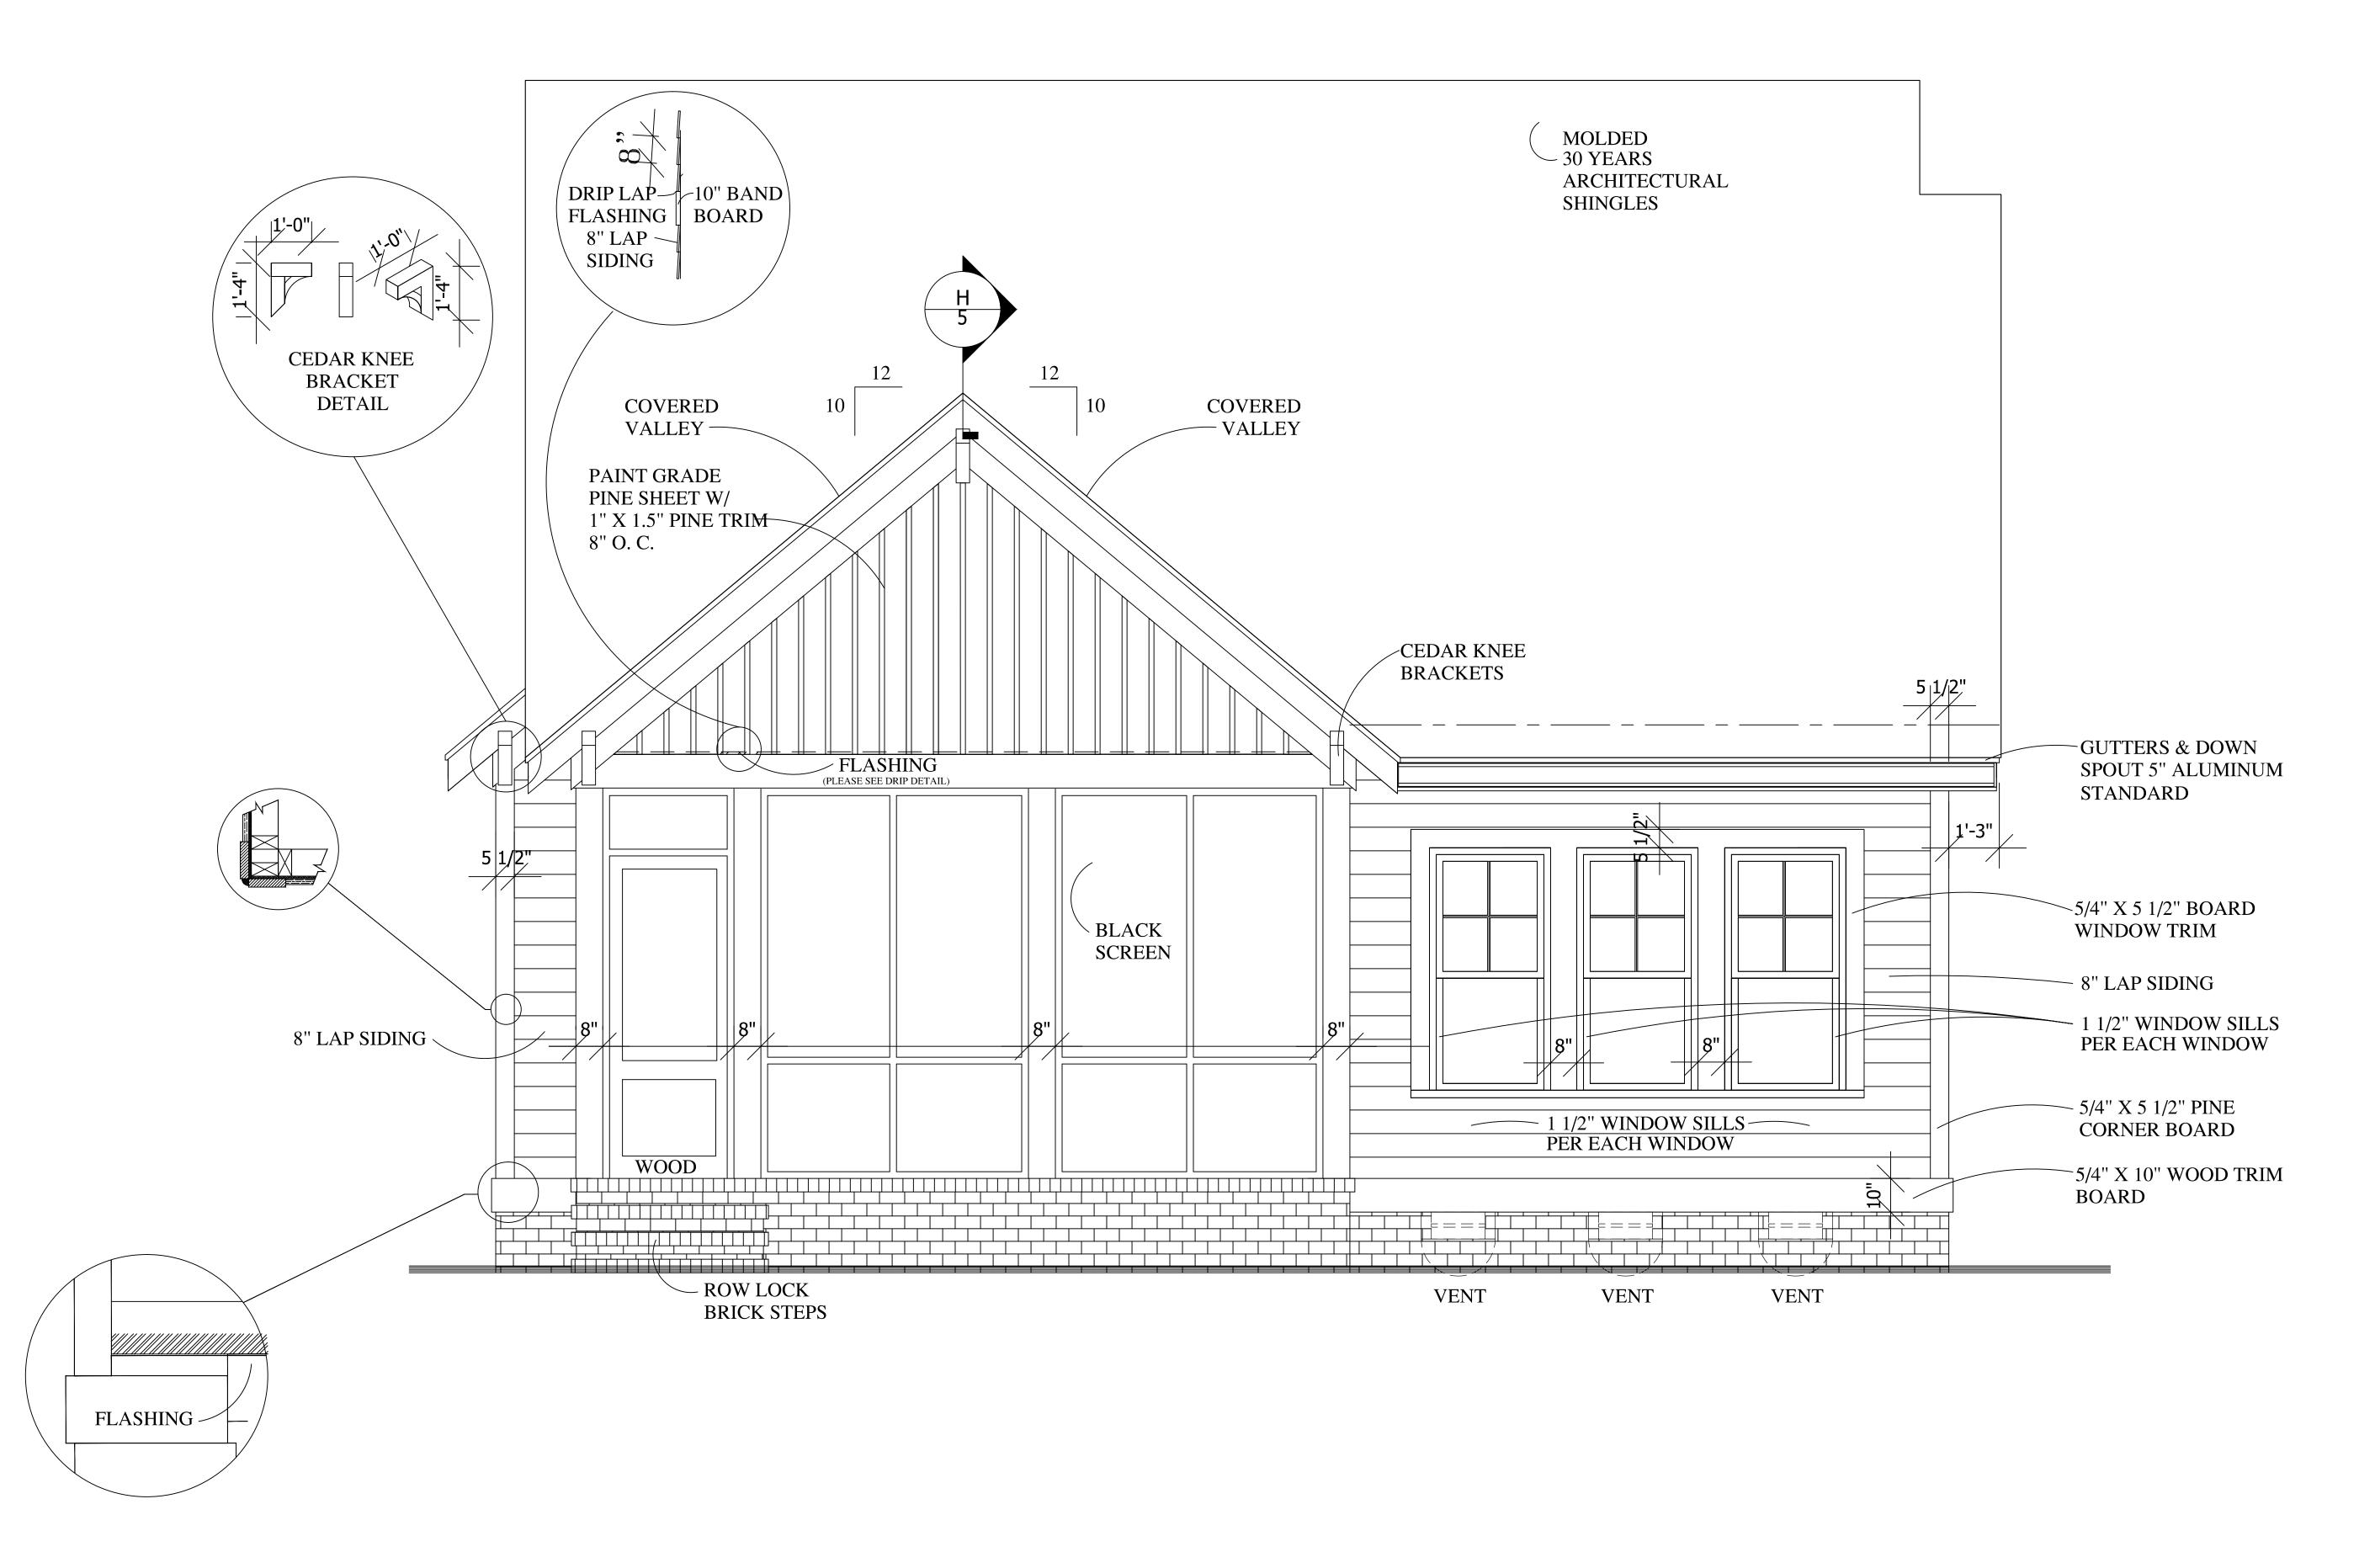
– ROW LOCK BRICK STEPS

REAR ELEVATION

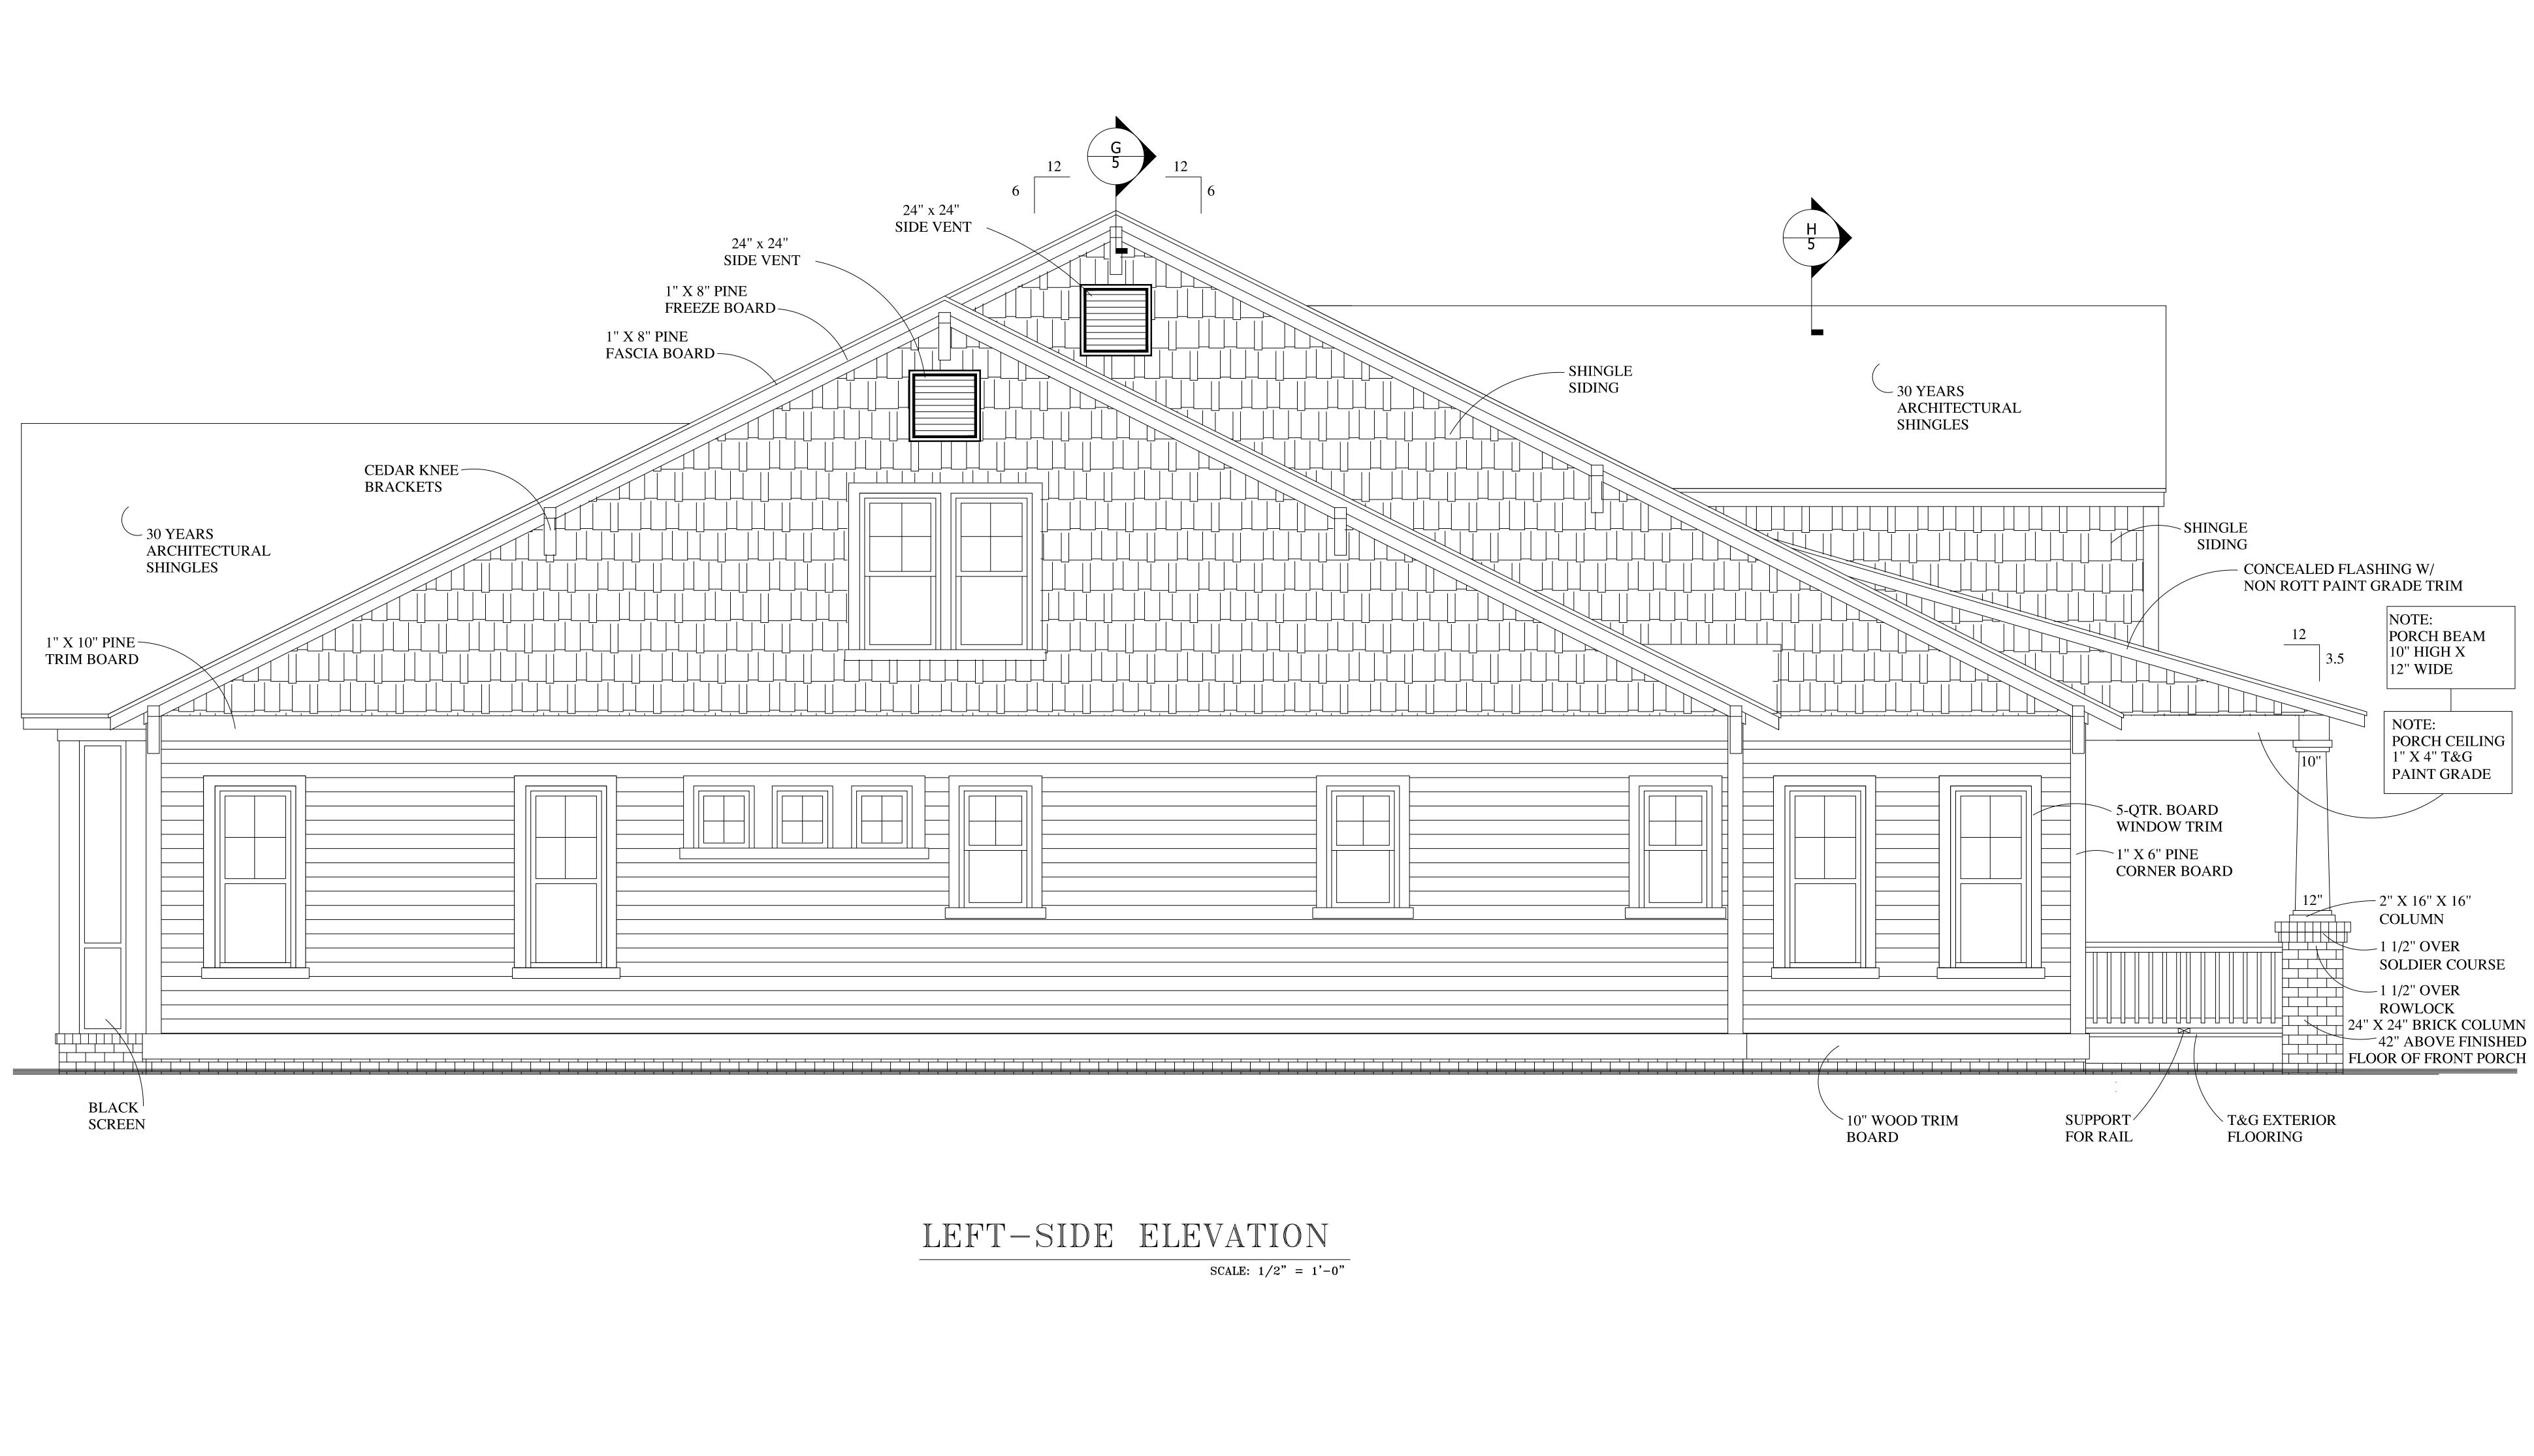

SCALE: 1/2" = 1'-0"


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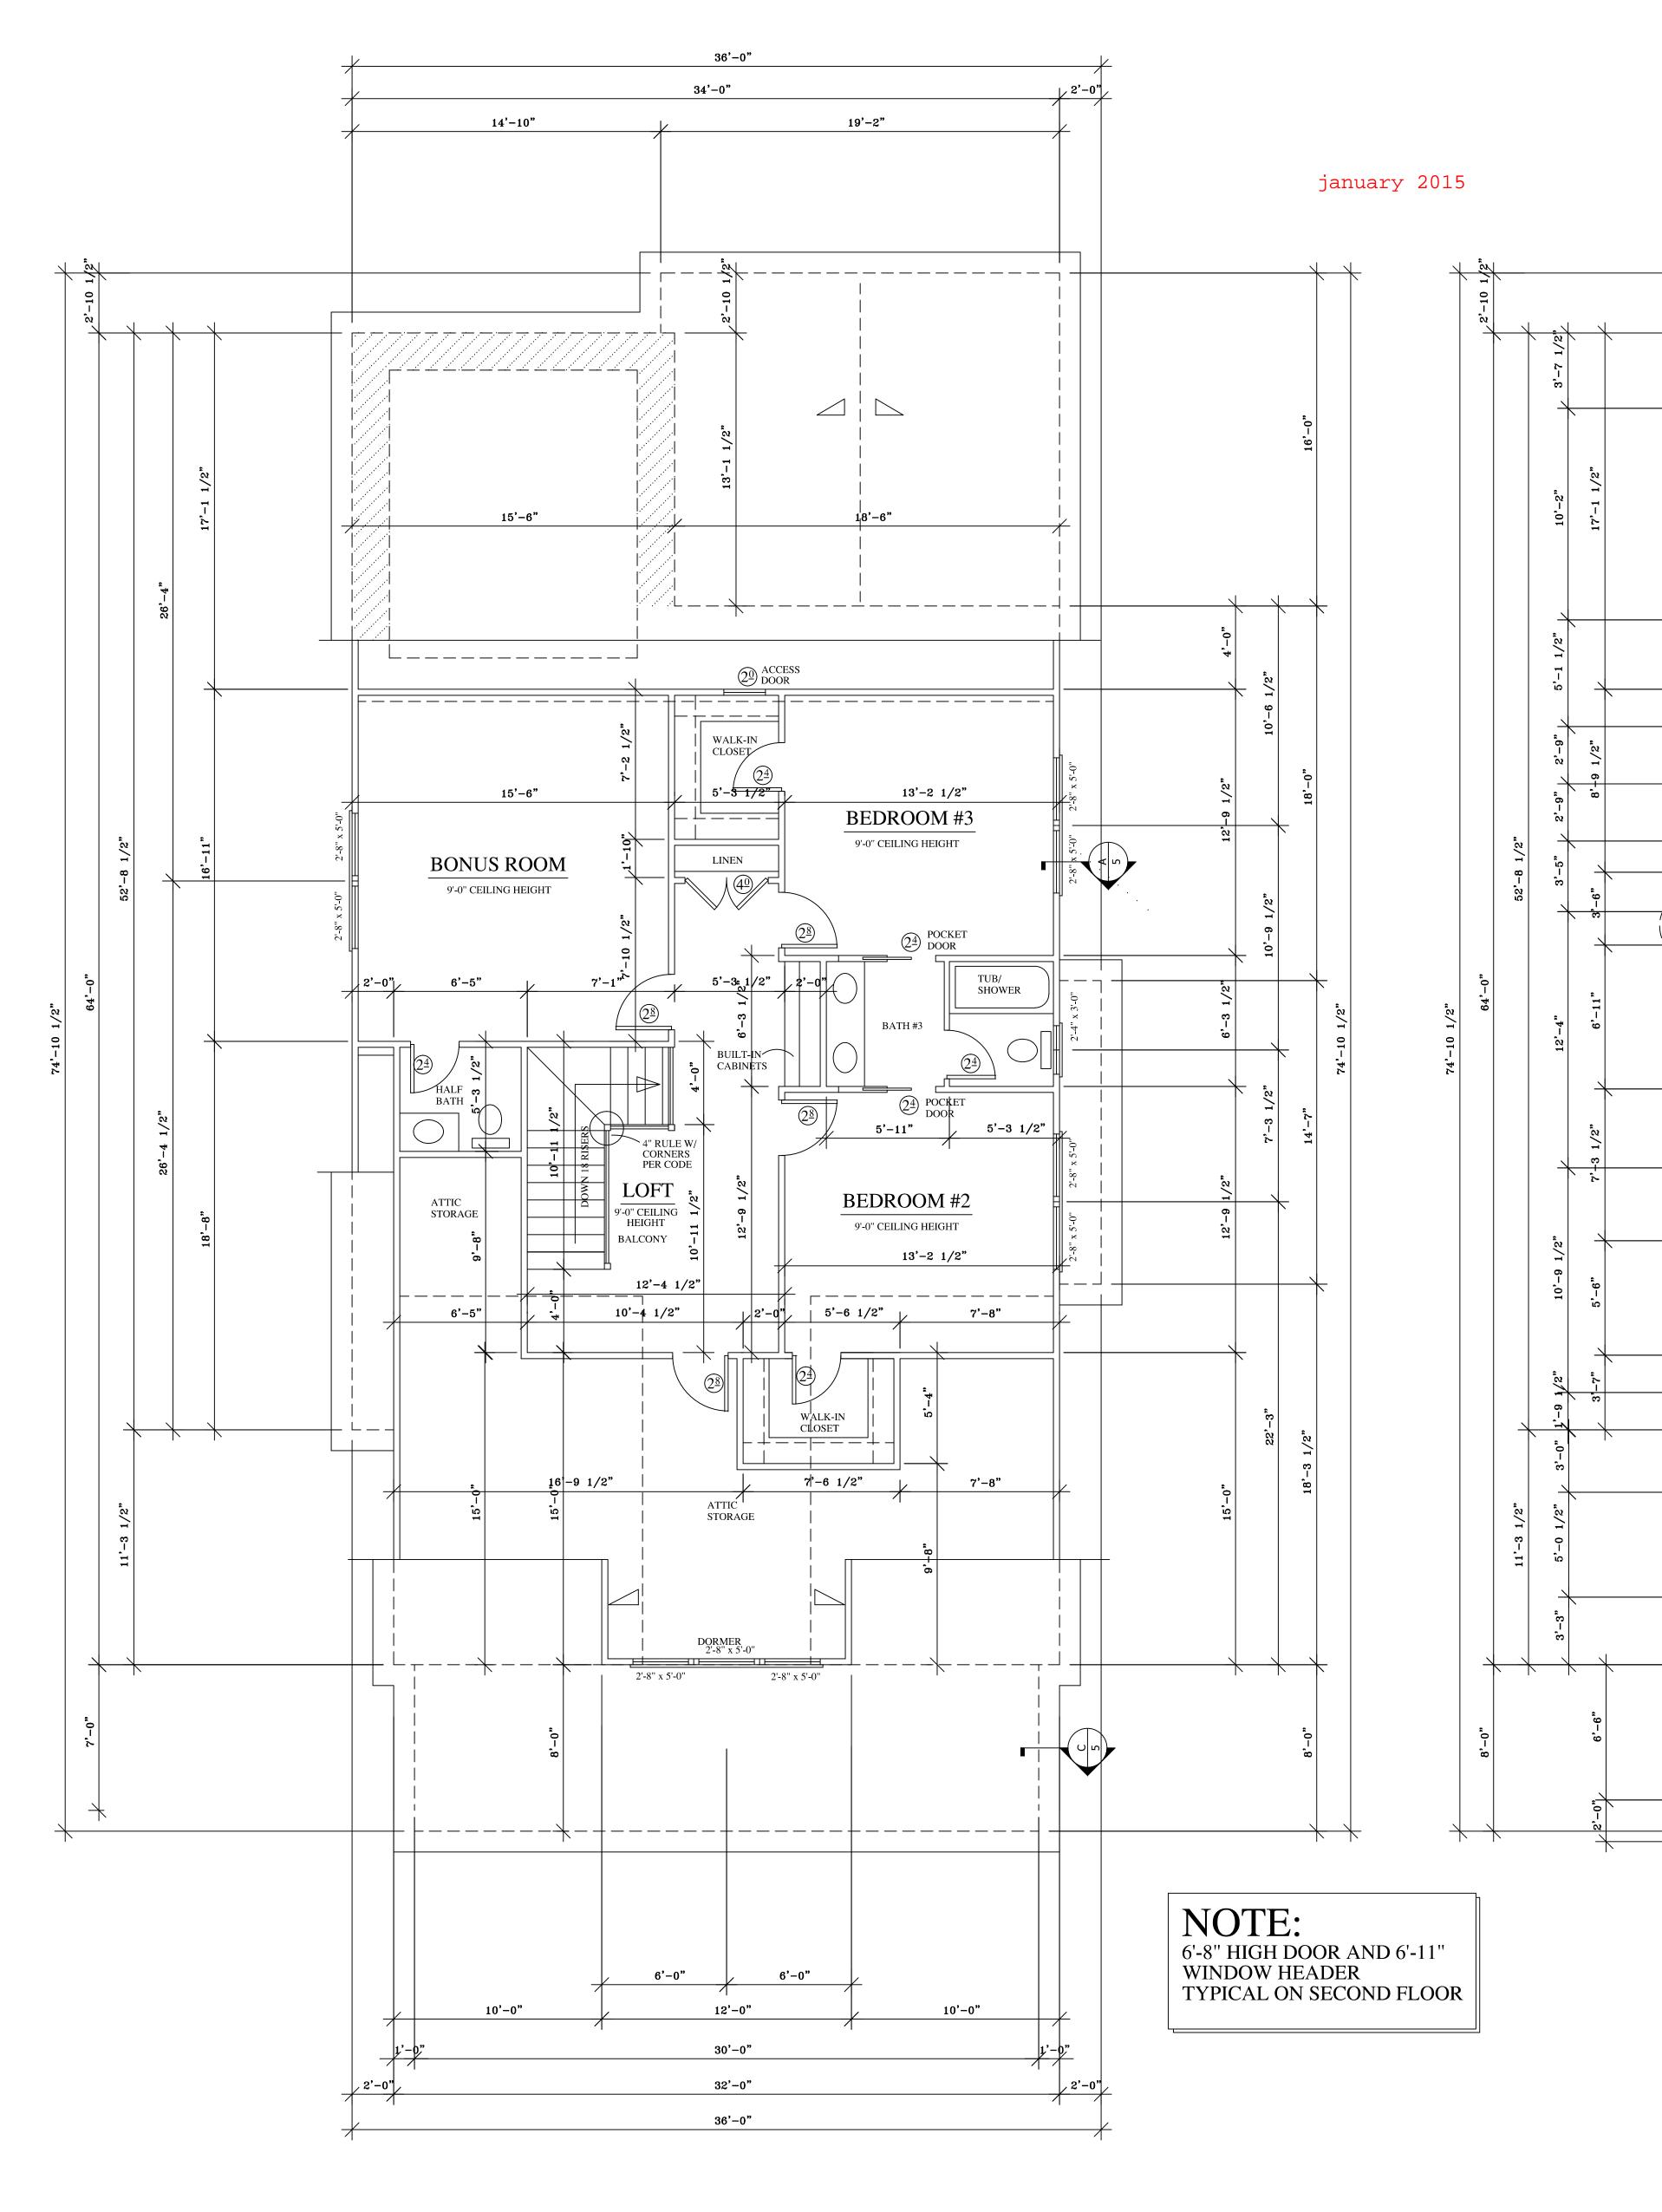


JANUARY 2015

REAR ELEVATION - OPT. A

SCALE: 1/2" = 1'-0"



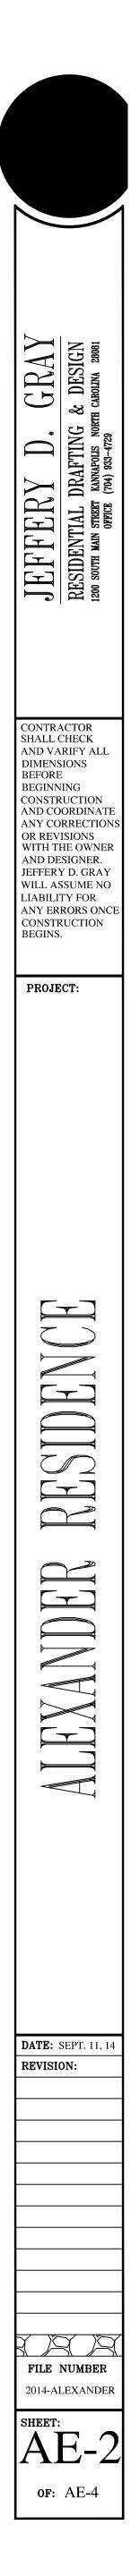

1046 SQ.FT.

SECOND FLOOR PLAN SCALE: 1/4" = 1'-0"


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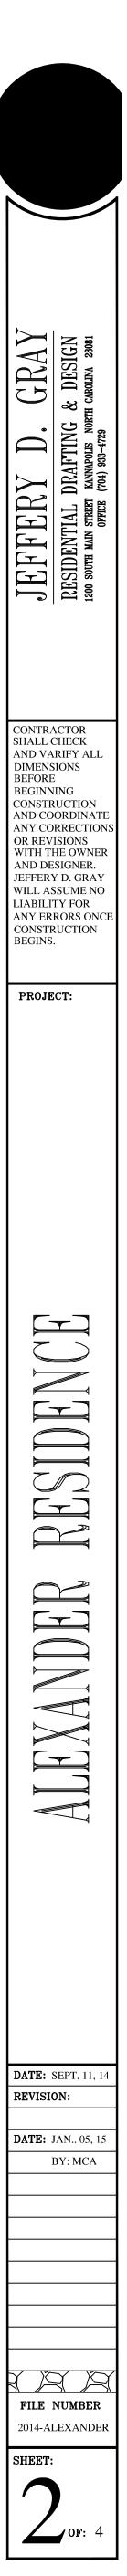
ALL WINDOW AND DOOR HEADERS SHALL BE 2-2" X 10" MIN. SPRUCE PINE UNLESS NOTED ON PLAN ALL FLOOR JOISTS SHALL BE 2" X 10" @ 16" O.C. MIN. SPRUCE PINE UNLESS NOTED ALL CEILING JOISTS SHALL BE 2" X 8" @ 16" O.C. MIN. SPRUCE PINE UNLESS NOTED

SHEATHING 1/2" MIN. GYPSUM BOARD


INSULATION R-19 FLOOR, R-15 EXTERIOR WALLS, R-30 CEILING


FIRST FLOOR PLAN SCALE: 1/4" = 1'-0" 1940 SQ.FT.




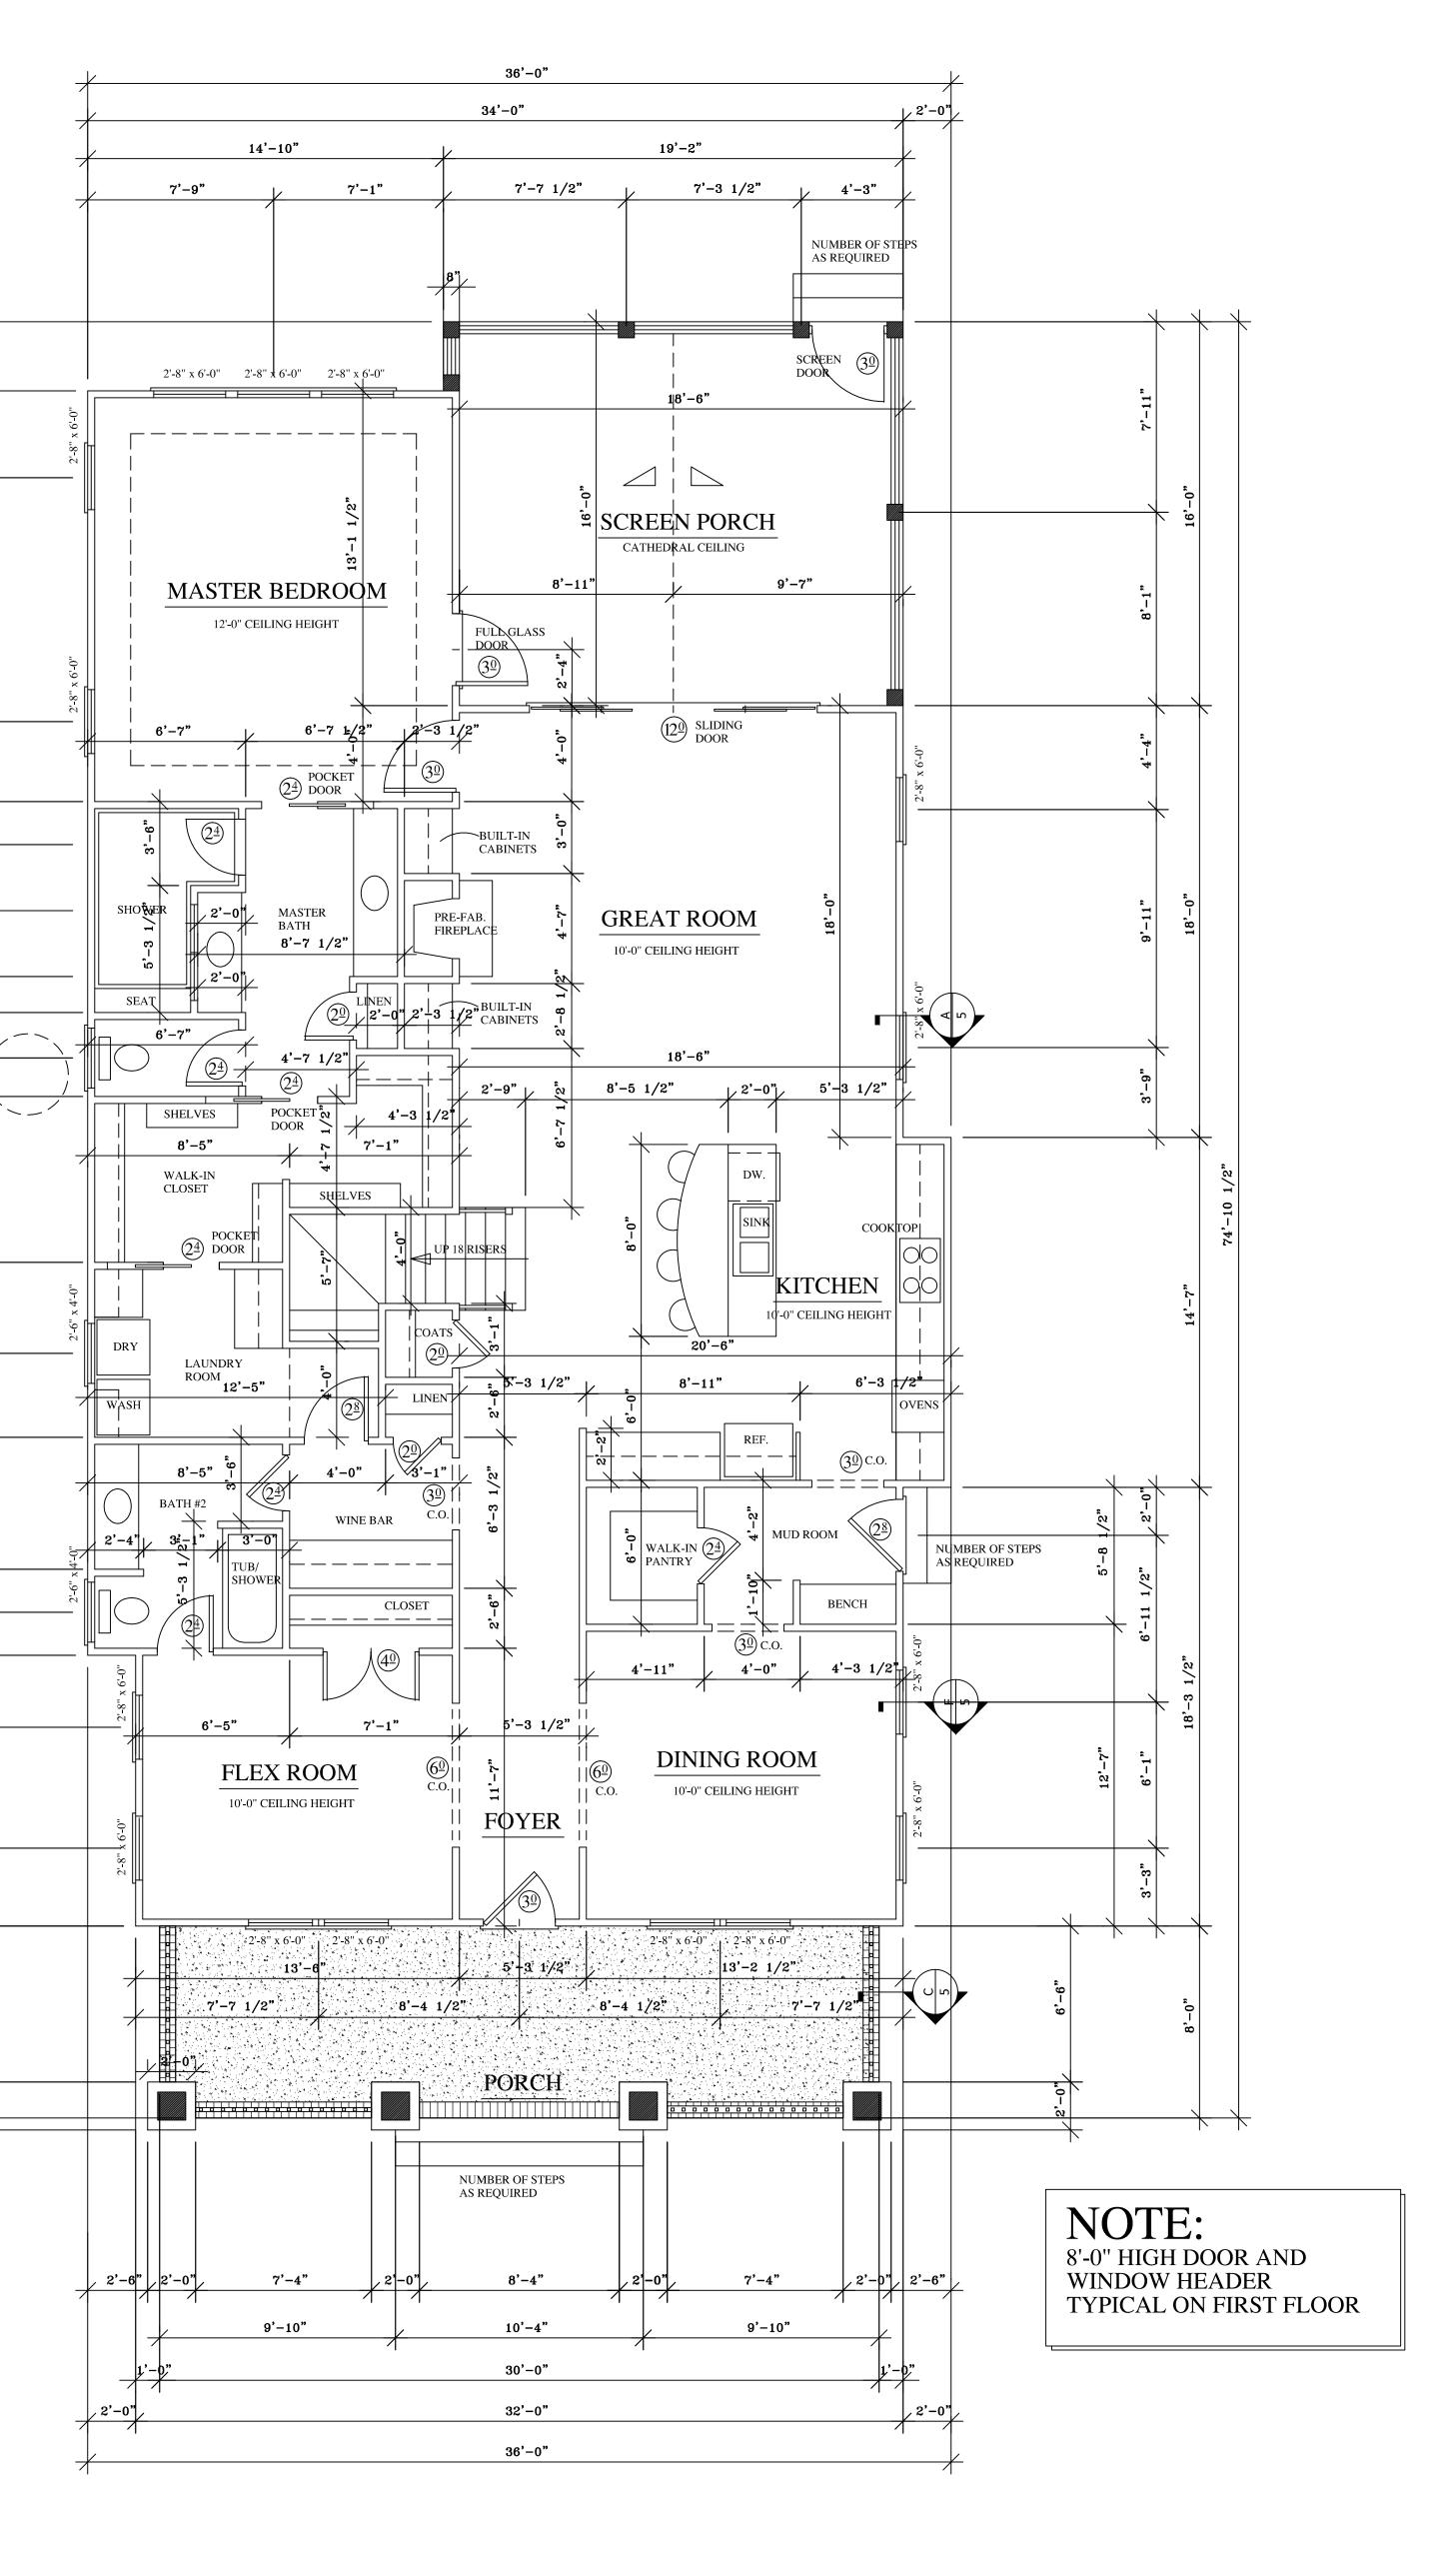



TOTAL HEATED 2986 SQ.FT.

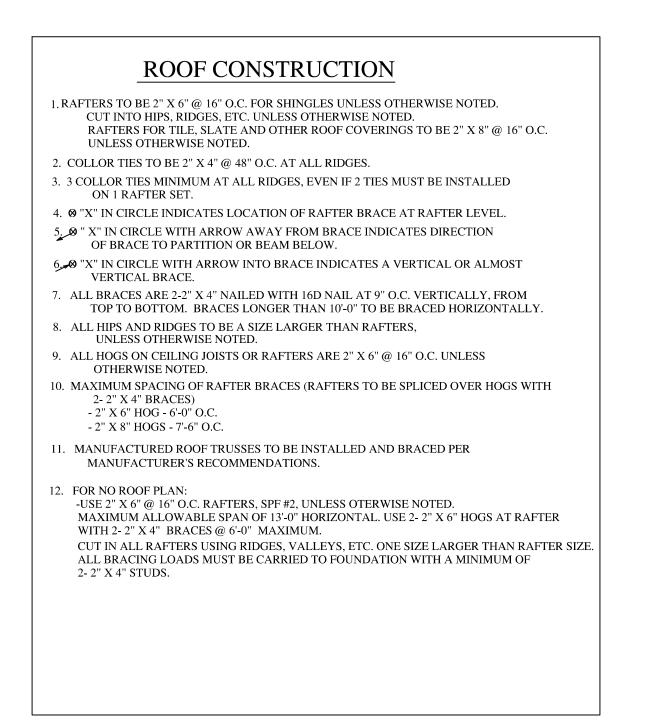

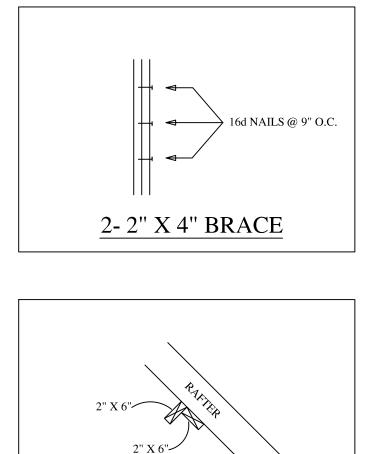


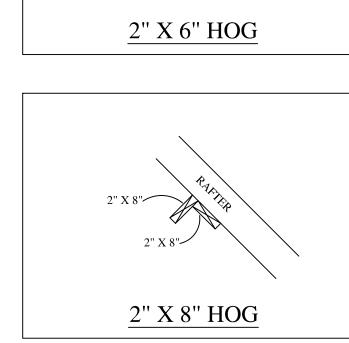

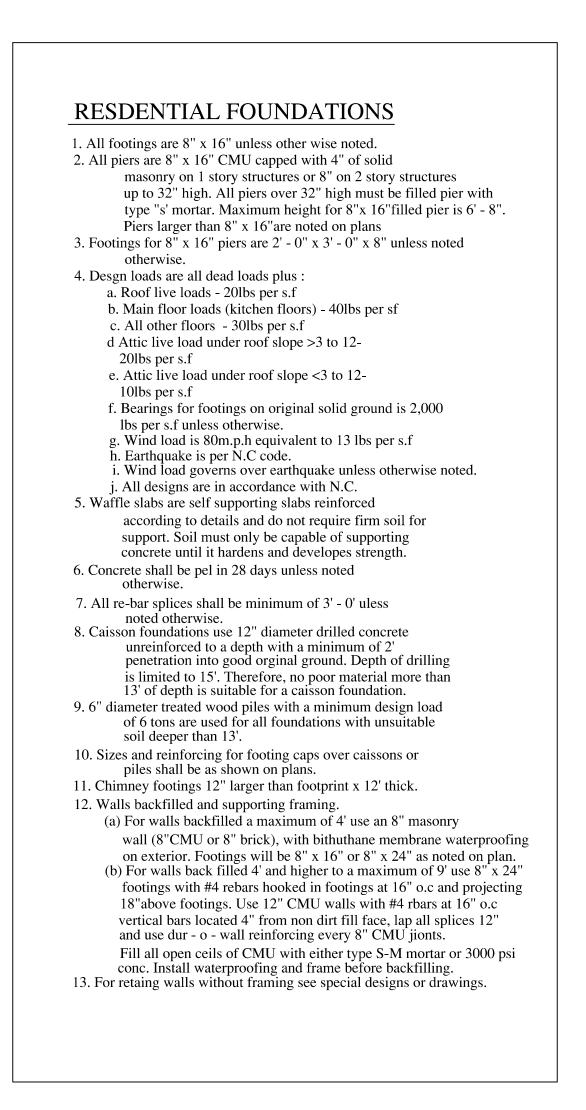

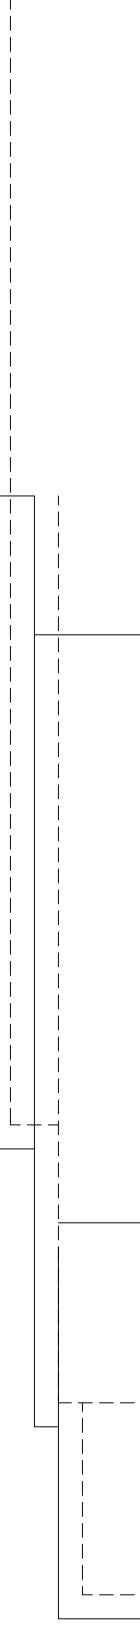



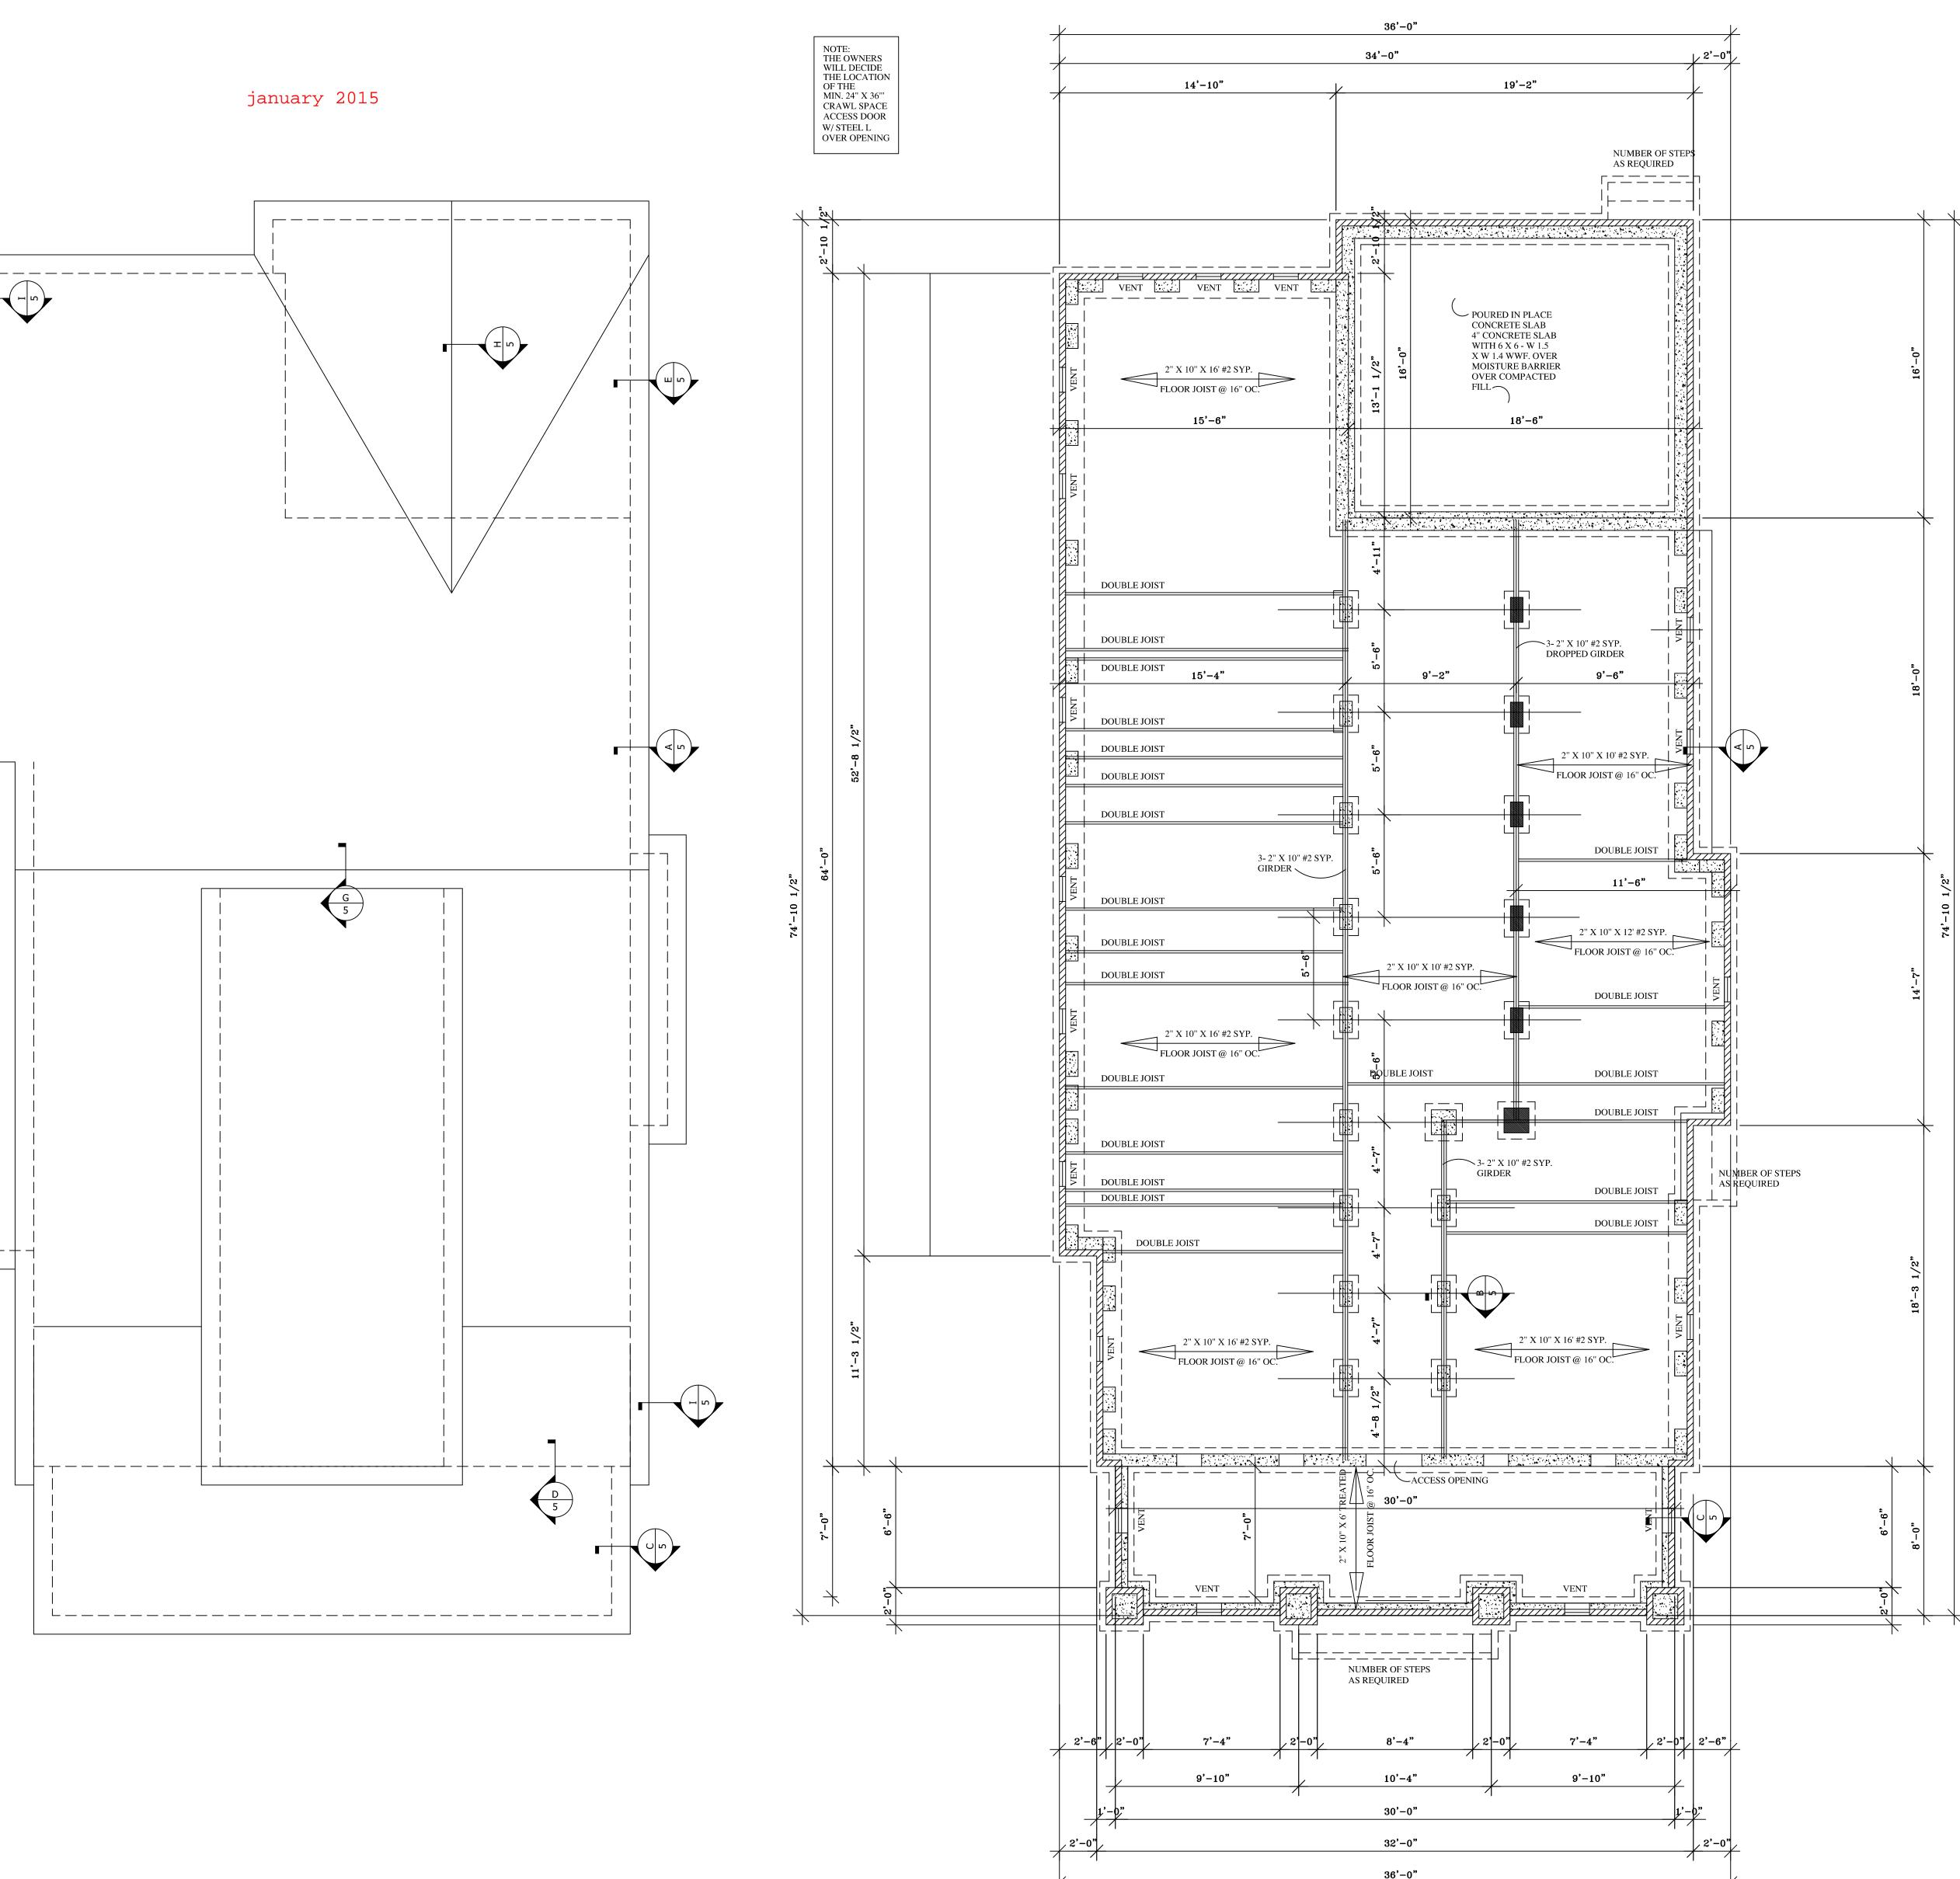


ROOF PLAN


SCALE: 1/4" = 1'-0"


FOUNDATION PLAN


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TOTAL HEATED 31 SHEET: 2986 SQ.FT.

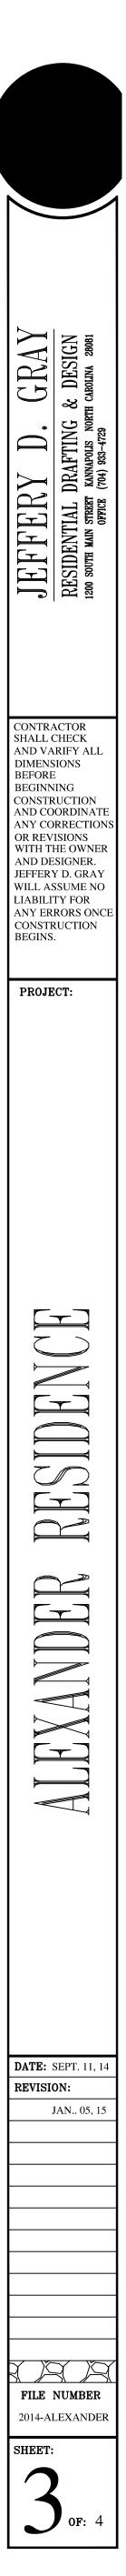



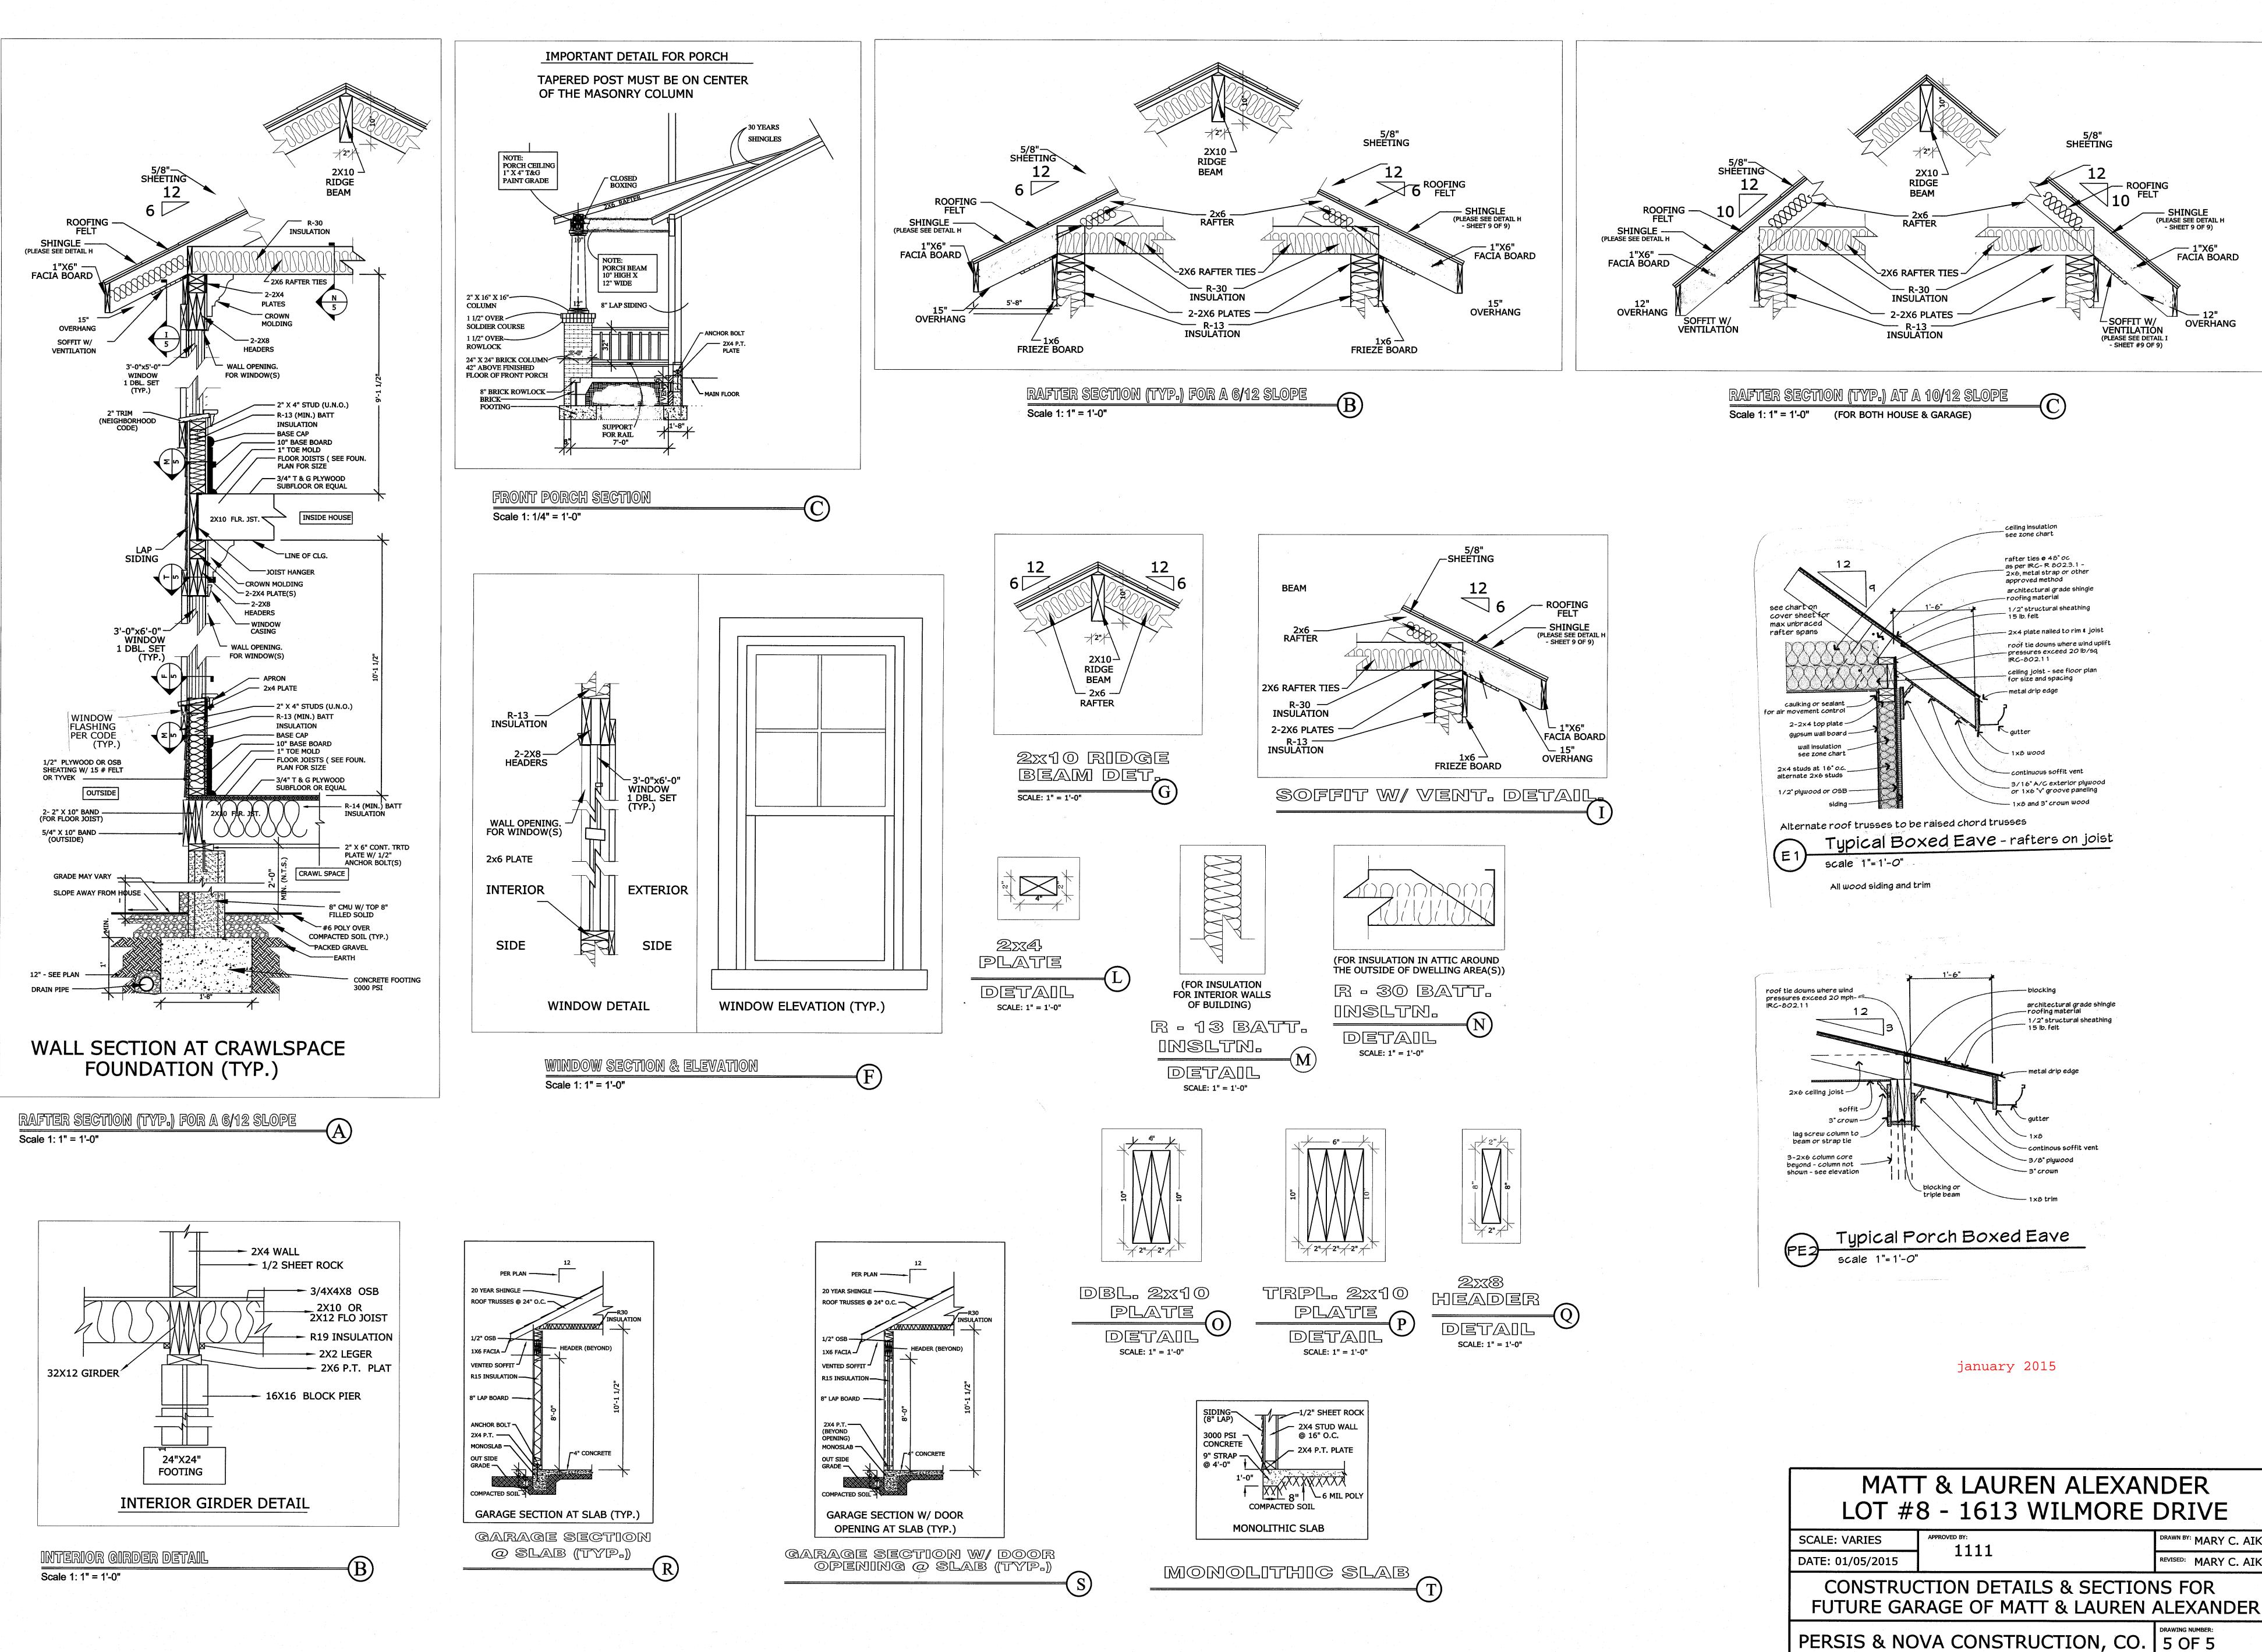


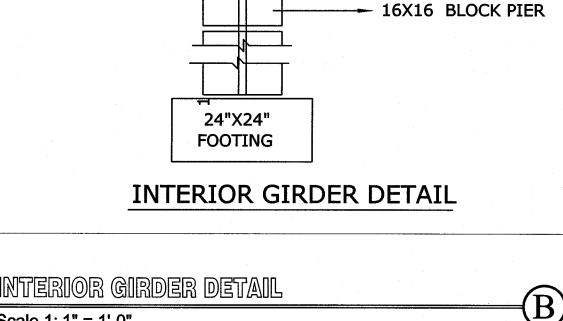5/8" SHEETING ROOFING - SHINGLE (PLEASE SEE DETAIL H - SHEET 9 OF 9) — 1"X6" FACIA BOARD SOFFIT W/ VENTILATION (PLEASE SEE DETAIL I - SHEET #9 OF 9) OVERHANG

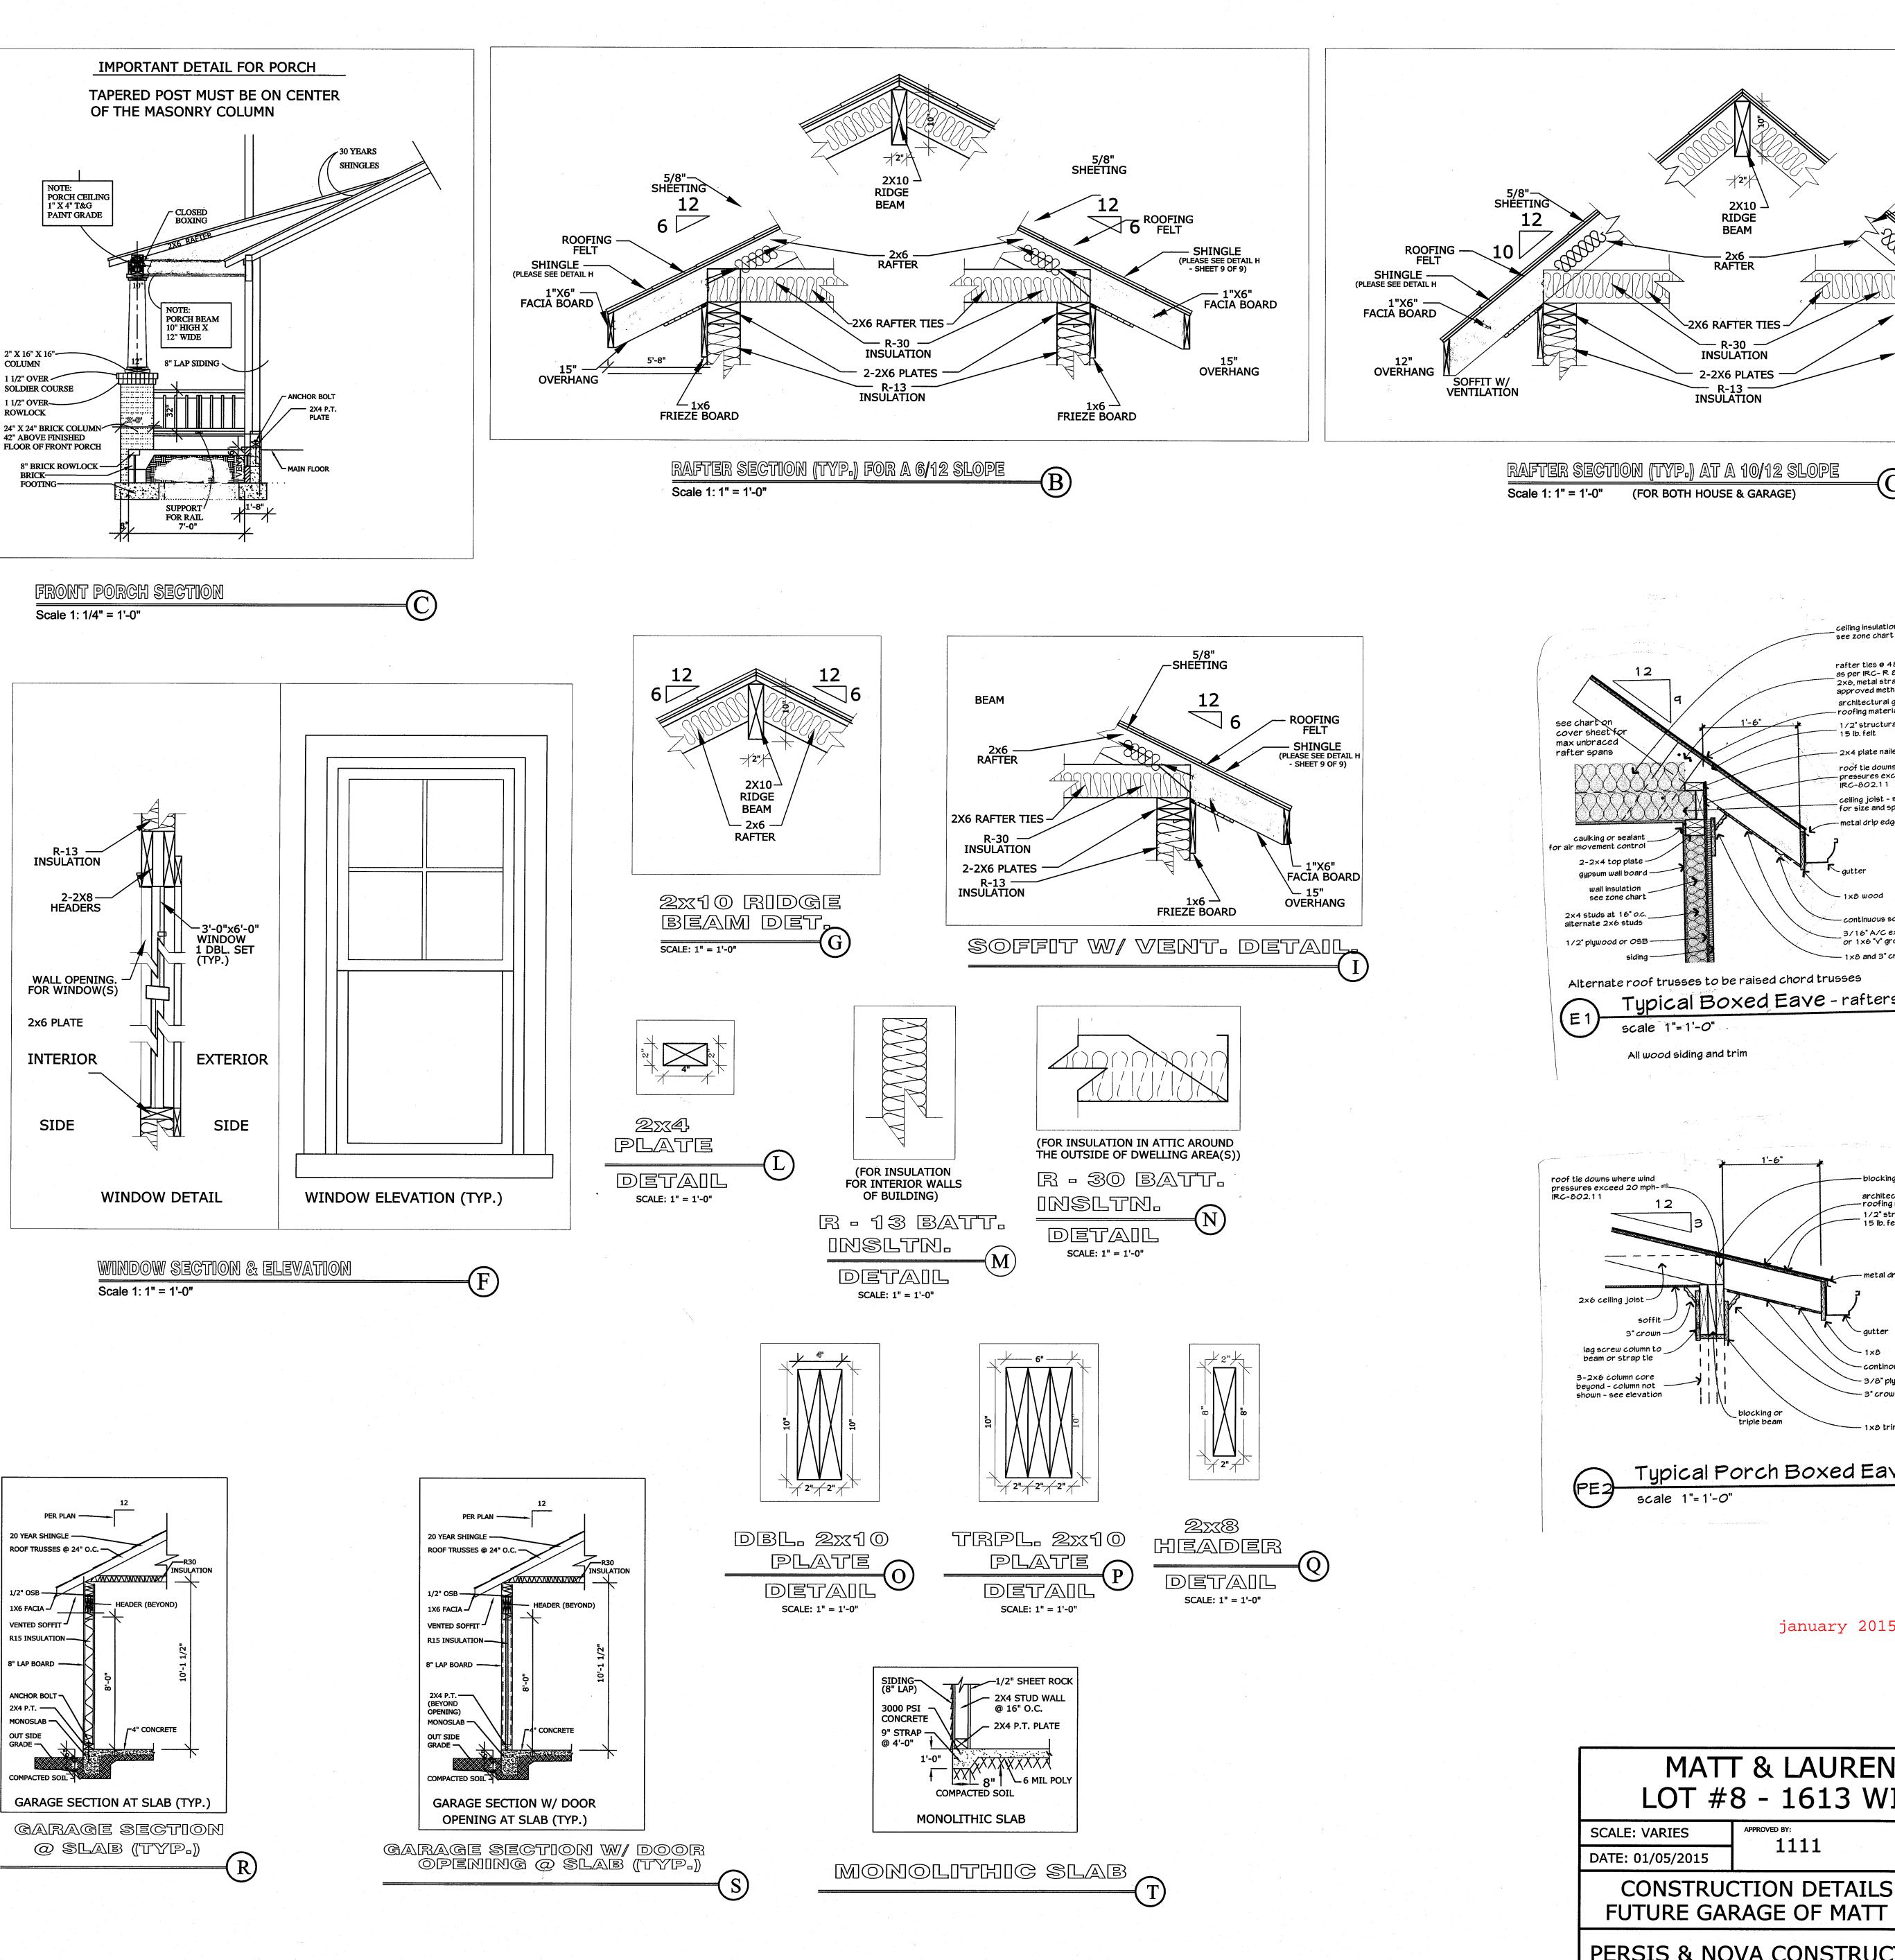architectural grade shingle — roofing material _____1/2" structural sheathing 15 lb. felt

- continous soffit vent


DRAWN BY: MARY C. AIKENS REVISED: MARY C. AIKENS DRAWING NUMBER:

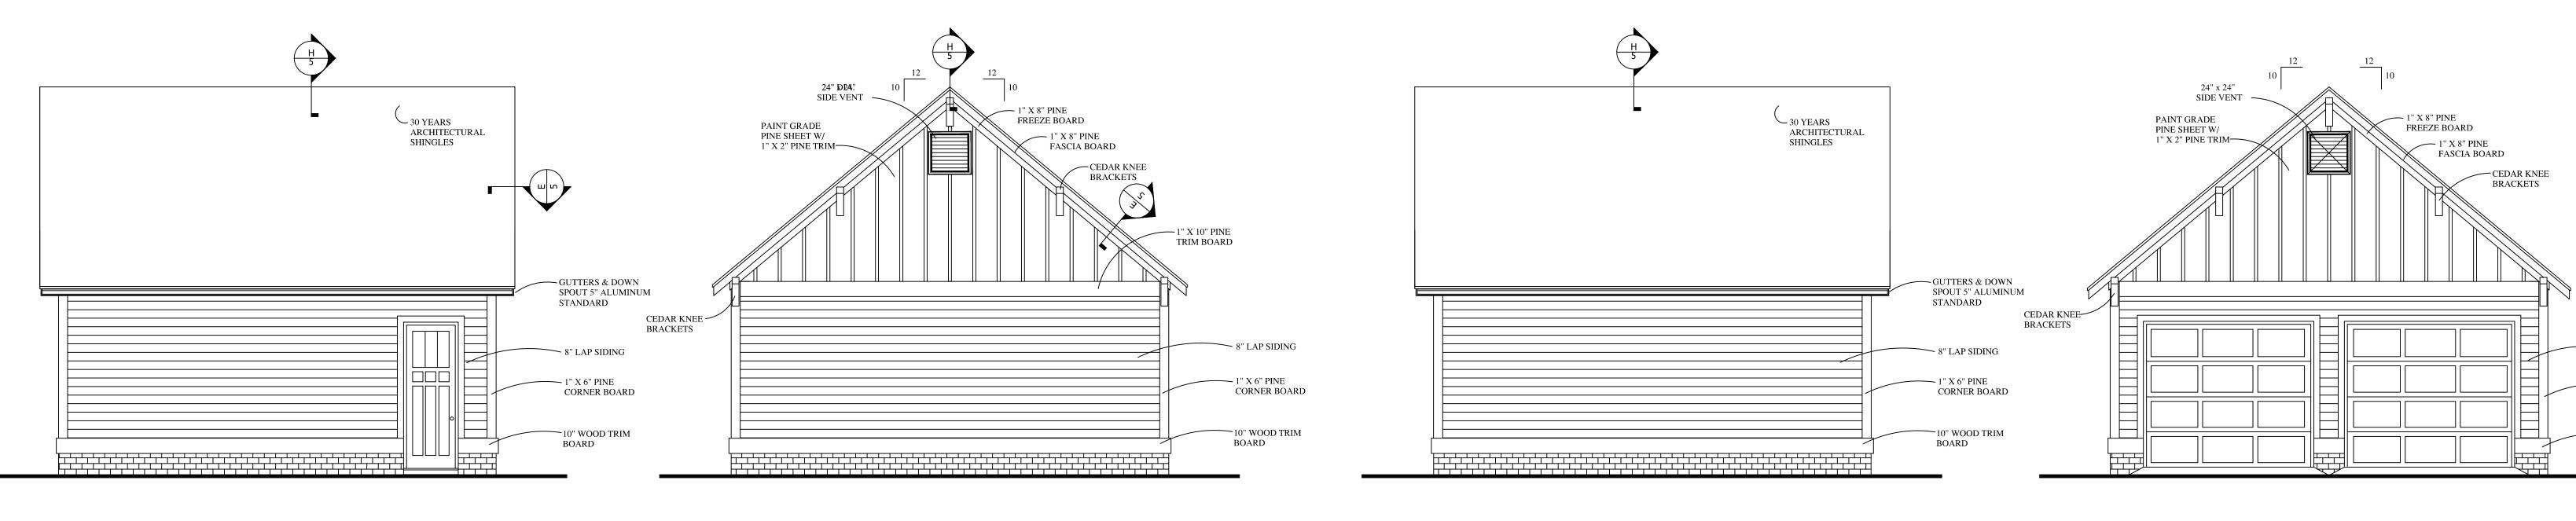


SCALE: 1/4" = 1'-0"

LEFT ELEVATION

SCALE: 1/4" = 1'-0"

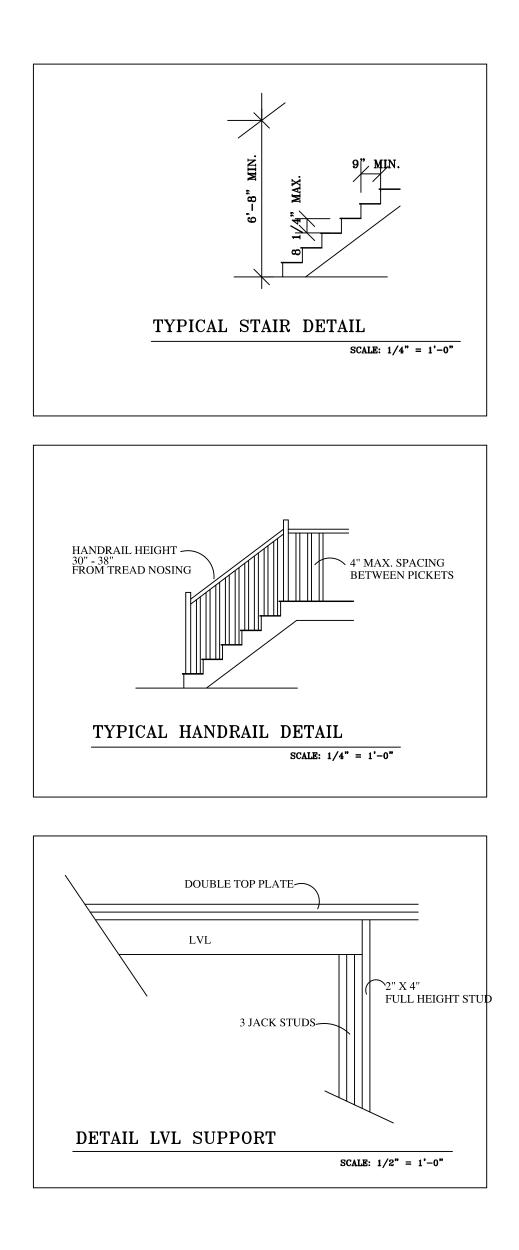

REAR ELEVATION

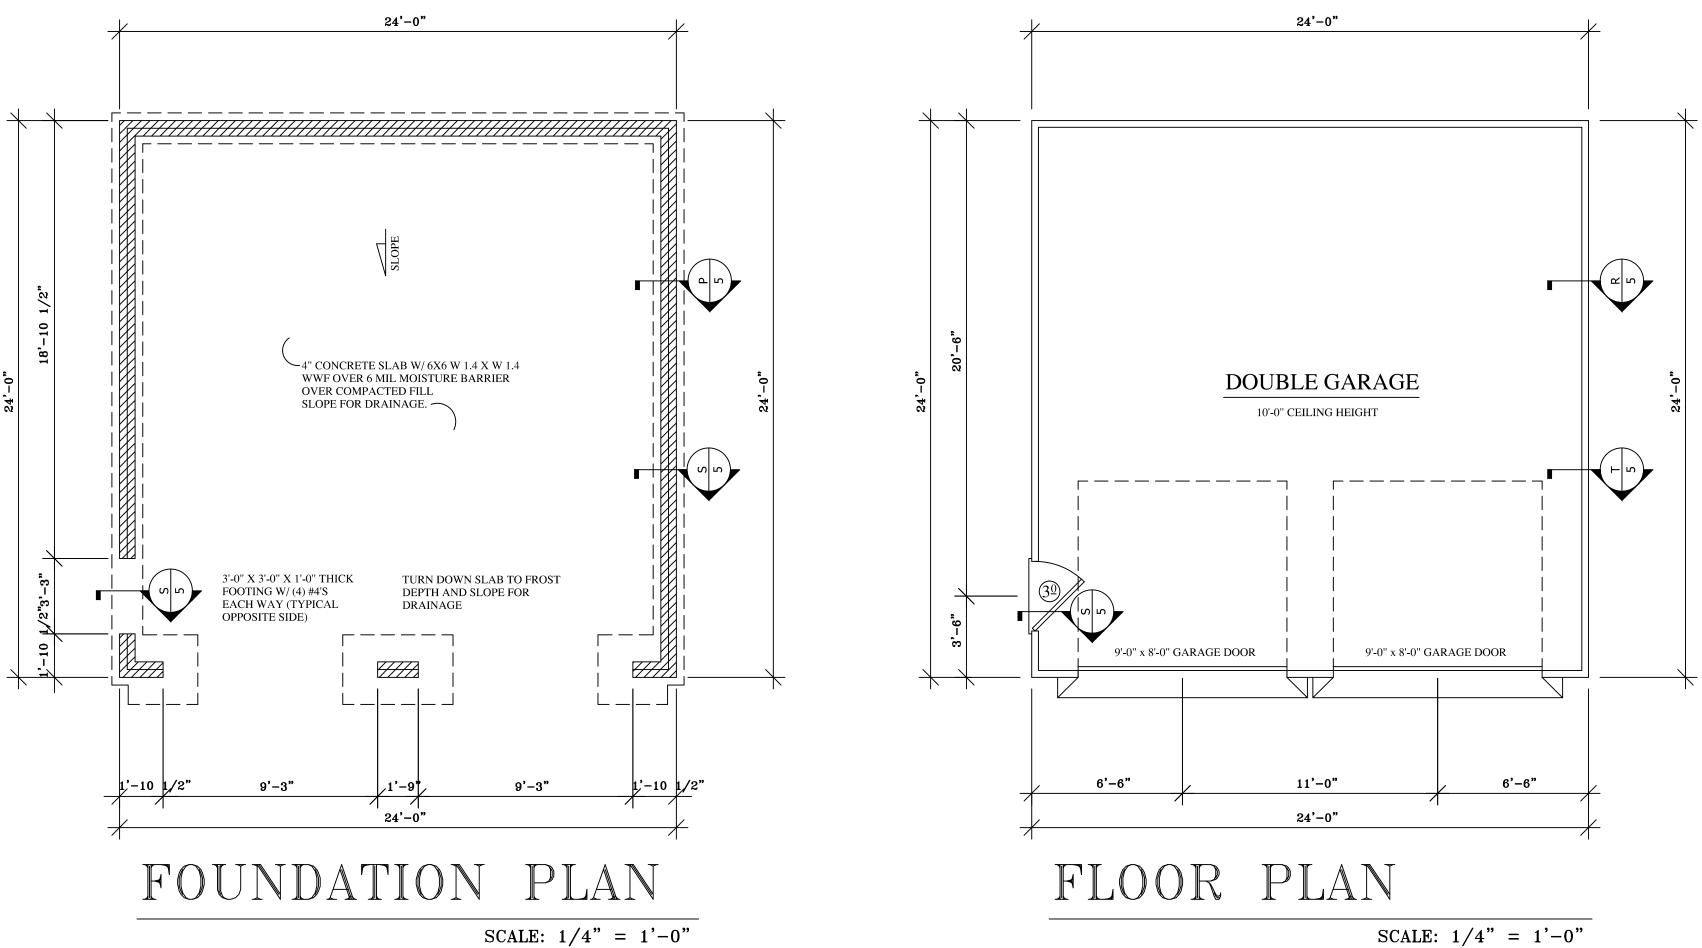

SCALE: 1/4" = 1'-0"


SCALE: 1/4" = 1'-0"

RIGHT ELEVATION

FRONT ELEVATION




- ~ 8" LAP SIDING
- 1" X 6" PINE CORNER BOARD
- —10" WOOD TRIM BOARD
- SCALE: 1/4" = 1'-0"

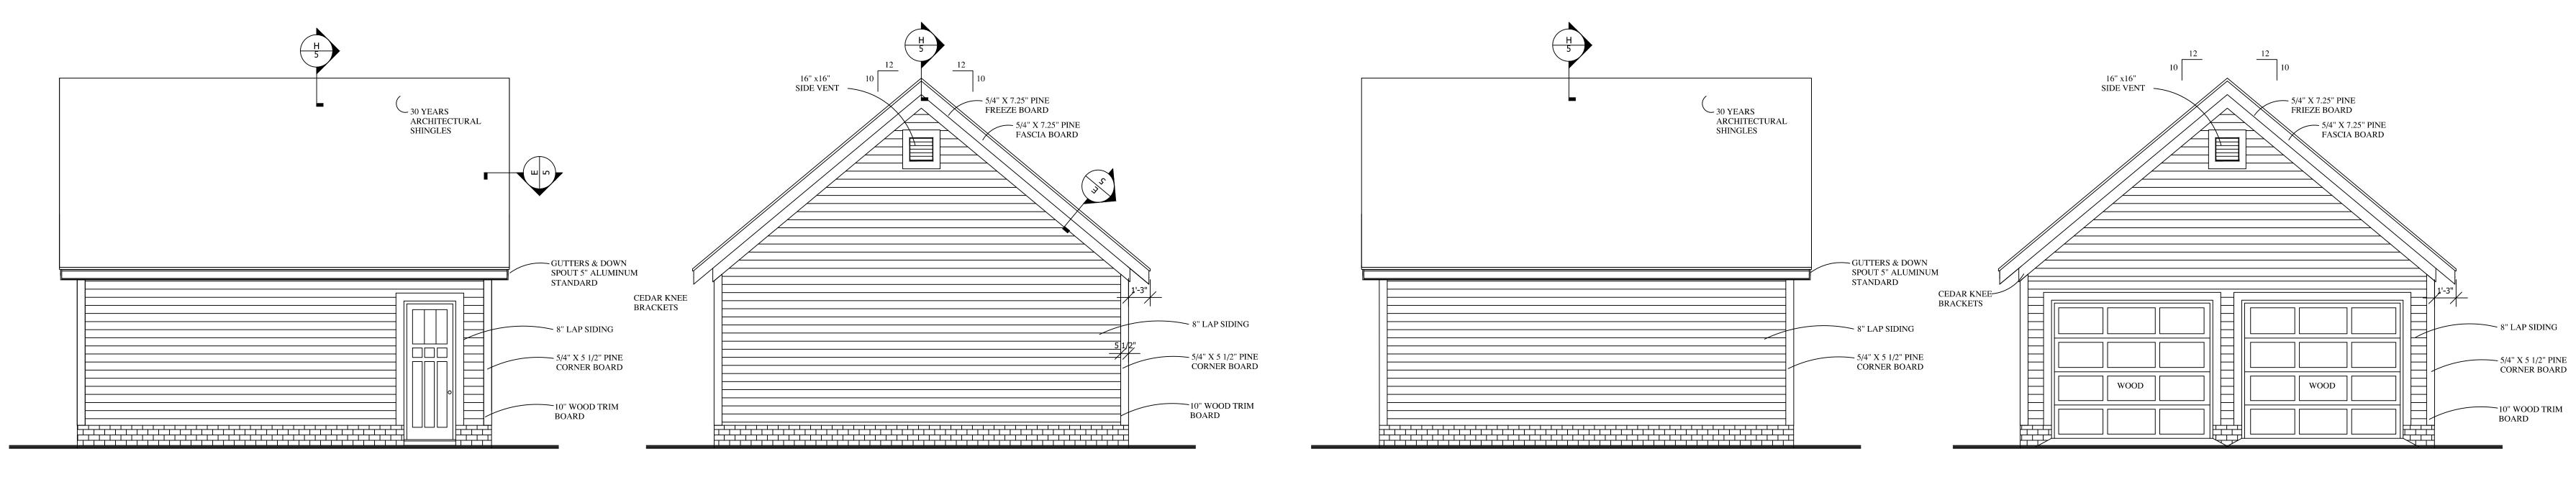


LEFT ELEVATION

SCALE: 1/4" = 1'-0"

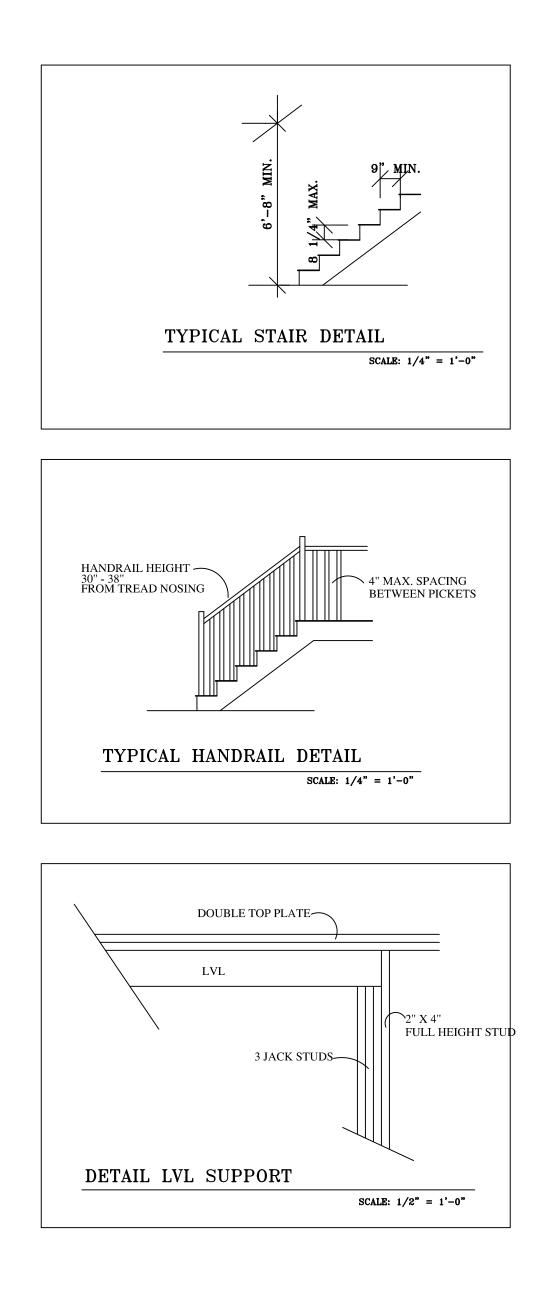

REAR ELEVATION

SCALE: 1/4" = 1'-0"

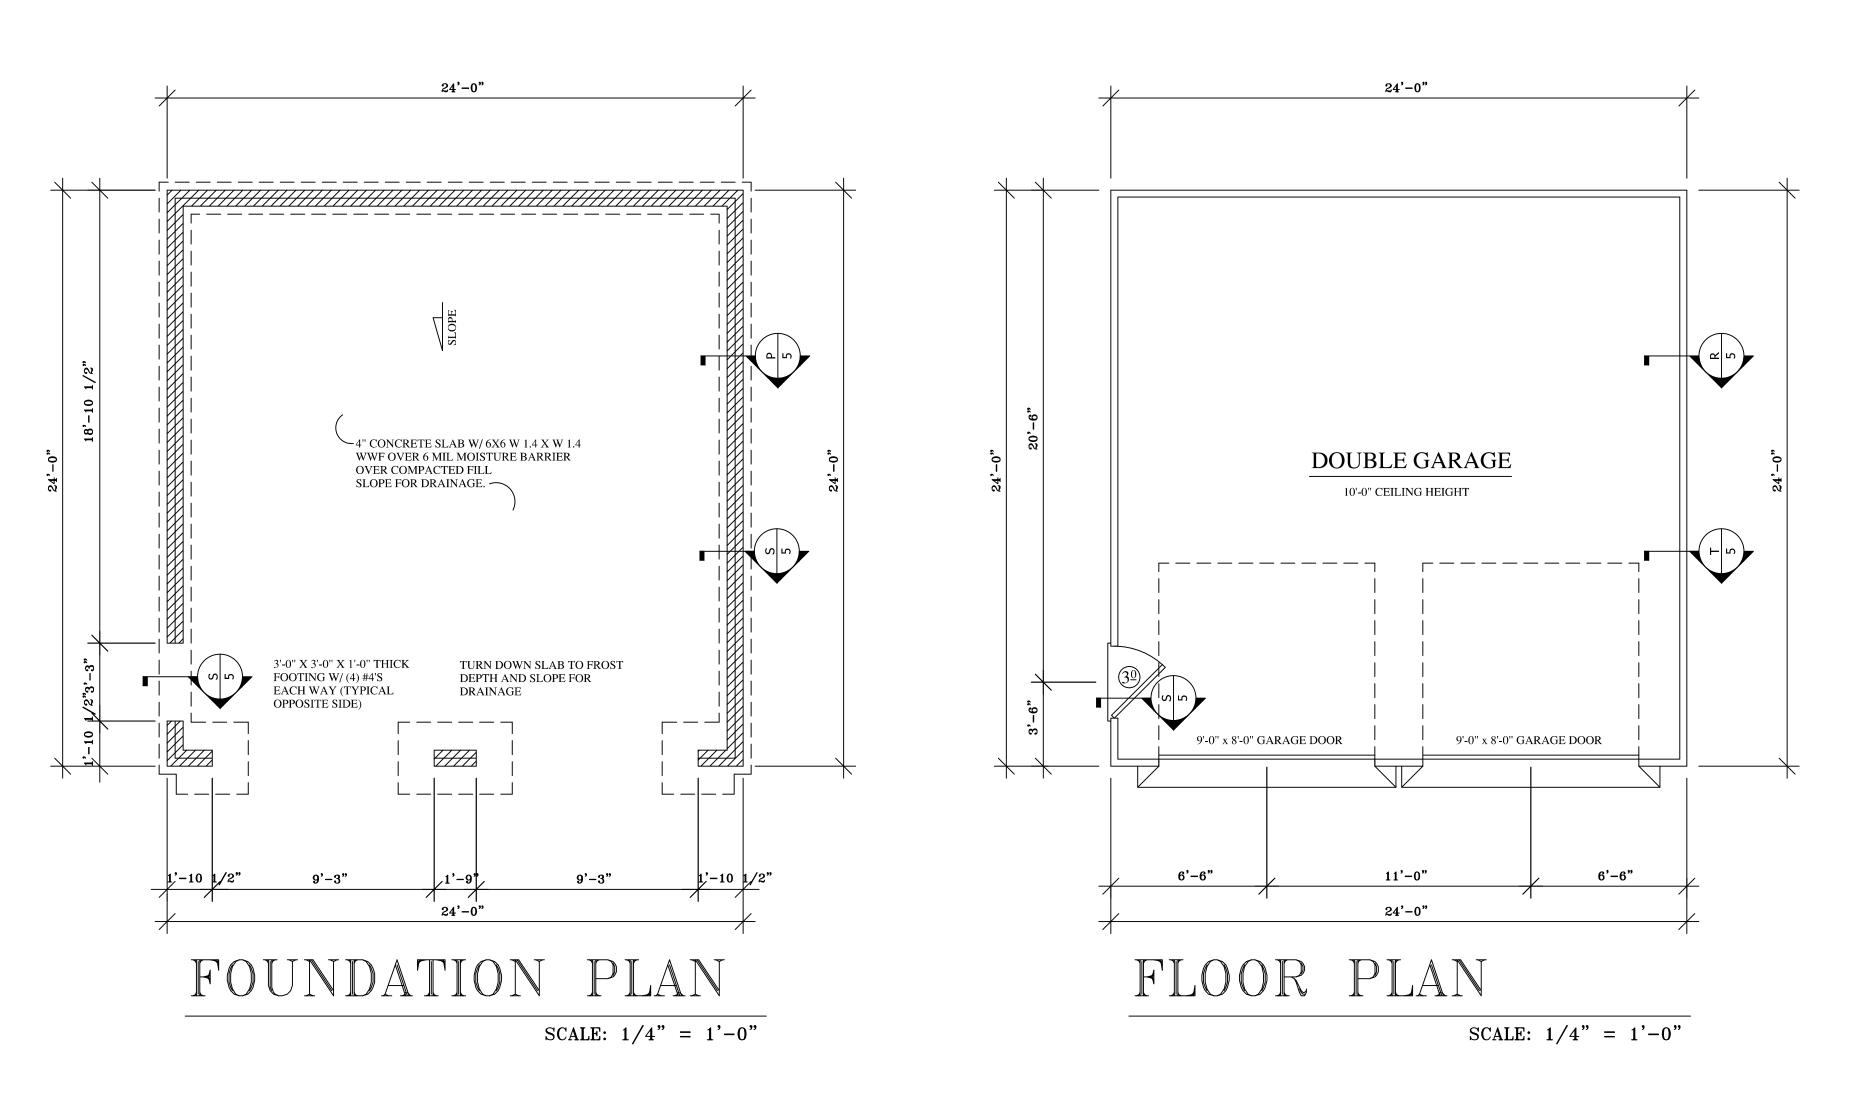

RIGHT ELEVATION

SCALE: 1/4" = 1'-0"

FRONT ELEVATION

SCALE: 1/4" = 1'-0"

GRAY & DESIGN JEFFERER RESIDENTIAL DR/ 1200 SOUTH MAIN STREET KANN 0FFICE (704) CONTRACTOR SHALL CHECK AND VARIFY ALL DIMENSIONS BEFORE BEGINNING CONSTRUCTION AND COORDINATE ANY CORRECTION OR REVISIONS WITH THE OWNER AND DESIGNER. JEFFERY D. GRAY WILL ASSUME NO LIABILITY FOR ANY ERRORS ONCE CONSTRUCTION BEGINS. PROJECT: RESIDEN ALEXANDER DATE: SEPT. 11, 1 REVISION: ŔĔ FILE NUMBER 2014-ALEXANDER SHEET:

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A DOLLAR

711





249 West park Ave.



300 Block West moved here.



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300 Block of West Kingston Ave.





1600 Block Wilmore Dr.

1000







1500 Block of Wilmore Dr. 2

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