LOCAL HISTORIC DISTRICT:	Dilworth
PROPERTY ADDRESS:	809 Mount Vernon Avenue
SUMMARY OF REQUEST:	New Construction
OWNER:	Paul and Krista Tillman
APPLICANT:	Don Duffy

Based on the need for additional information this application was continued from the April 9 meeting for the following:

- Setbacks
- Cross sections
- Show samples of materials
- Tree save plan
- Wall sections

#### **Details of Proposed Request**

#### **Existing Conditions**

The existing structure is a one story brick ranch style home listed as a non-contributing structure in the Dilworth National Register. The home was built in 1950.

#### Proposal

The proposal is a new 1.5 story single family home. On the front façade features include a centered front porch and dormer. The rear elevation includes a center chimney flanked by French doors and a centered dormer. Details include cottage style windows, wood lap siding, cedar shake in the gables, and a combination of wood and cementitious trim materials. The overall height is approximately 24'-6".

#### **Revised** Proposal

The following changes were made based on comments from April (Clarify setback, include cross sections, provide material samples and a tree save plan):

- 1. The setback (42'8" from back of sidewalk) is consistent with the established condition
- 2. Porch and wall section details have are provided
- 3. The two oak trees will remain. The front walkway will curve slightly to protect tree roots.

#### Policy & Design Guidelines for New Construction

New construction in Local Historic Districts has an obligation to blend in with the historic character and scale of the Local Historic District in which it is located. Designs for infill projects and other new construction within designated Local Historic Districts must be designed with the surroundings in mind. <u>The Historic District</u> <u>Commission will not specify a particular architectural style or design for new construction projects. The scale, mass and size of a building are often far more important than the decorative details applied. However, well designed stylistic and decorative elements, as well as building materials and landscaping, can give new</u>

construction projects the attributes necessary to blend in with the district, while creating a distinctive character for the building. New construction projects in Local Historic Districts must be appropriate to their surroundings.

The Historic District Commission will review the building details for all new construction as part of their evaluation of new construction project proposals.

All New Construction Projects Will Be Evaluated For Compatibility By The Following Criteria		
1. Size	the relationship of the project to its site	
2. Scale	the relationship of the building to those around it	
3. Massing	the relationship of the building's various parts to each other	
4. Fenestration	the placement, style and materials of windows and doors	
5. Rhythm	the relationship of fenestration, recesses and projections	
6. Setback	in relation to setback of immediate surroundings	
7. Materials	proper historic materials or approved substitutes	
8. Context	the overall relationship of the project to its surroundings	
9. Landscaping	as a tool to soften and blend the project with the district	

#### **Staff Analysis**

The project meets the guidelines for new construction.

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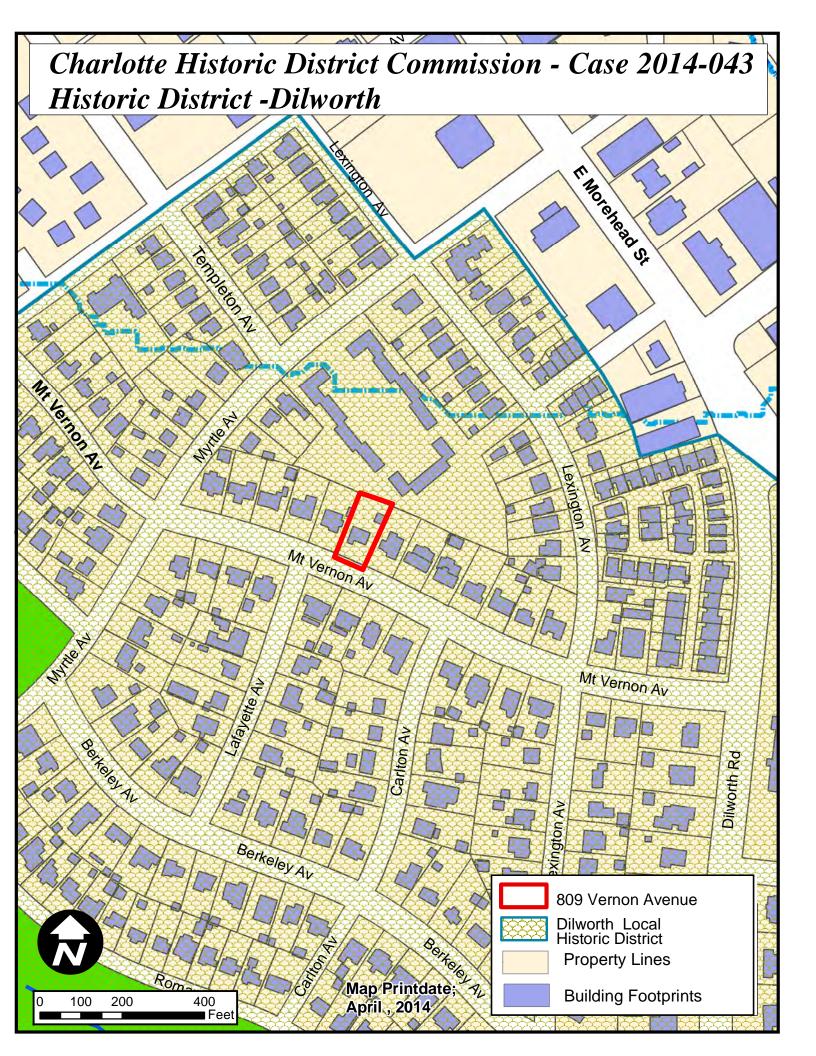
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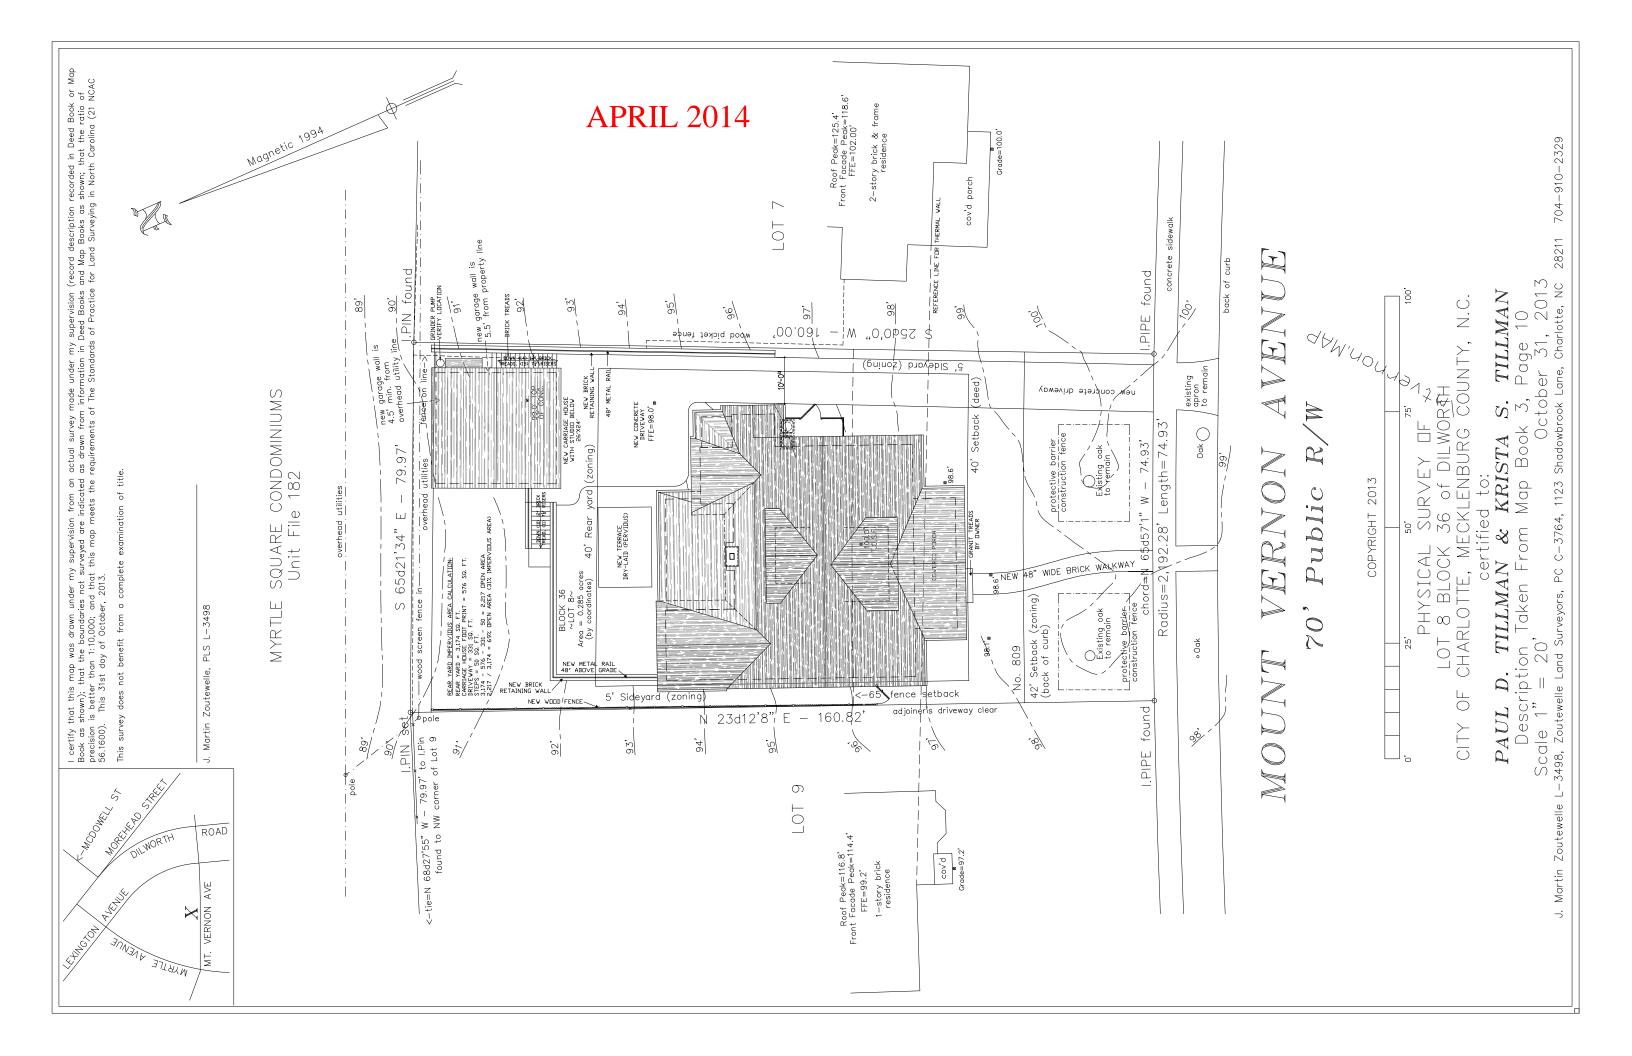
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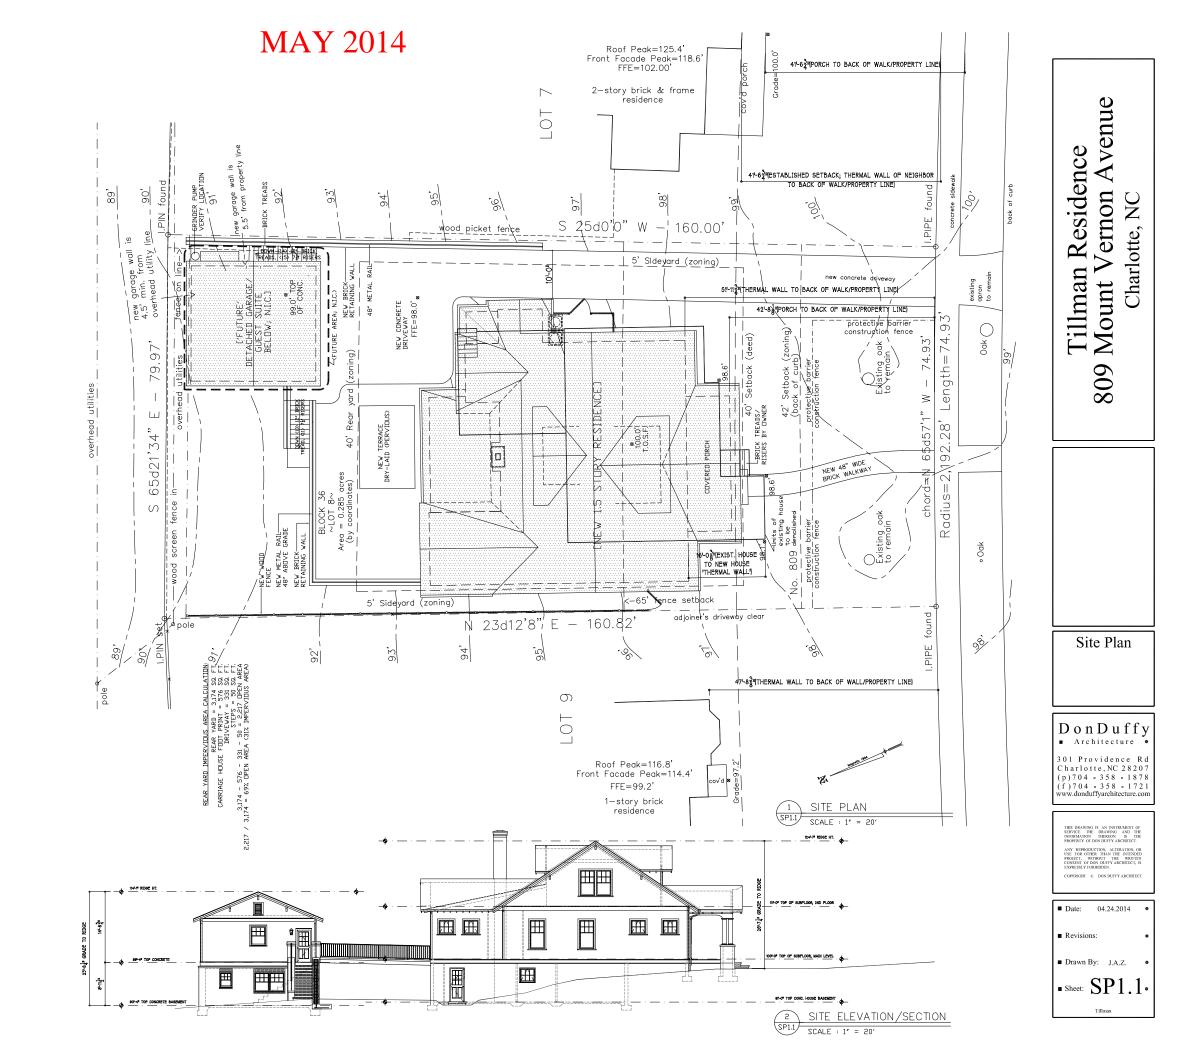
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Tillman Residence, 309 Mount Vernon Avenue 'Existing' (Streetscape Panorama) Don Duffy Architecture March 18, 2014



Tillman Residence, 309 Mount Vernon Avenue 'Existing' (Streetscape Photomontage) Don Duffy Architecture March 18, 2014

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## **APRIL 2014**

-EXPOSED RAFTER TAILS AND BOXING -"COTTAGE STYLE" SDL DOUBLE HUNG WINDOW -WOOD LAP SIDING, 4<sup>J</sup> EXPOSURE, 2 COATS FACTORY FINISH. -MIRTECK 1X4 CASING

MIRTECK \$ X 4 CORNER BOARD W/ ≹ QUARTER ROUND SPLINE ->%X4 ALUMINUM DOWN SPOUT, TYP. --1X10 HARDI BOARD BAND W/ DRIP CAP AND METAL DRIP EDGE -OVER SIZED MACHINE TUMBLED BRICK FOUNDATION

Tillman Residence Mount Vernon Avenue <sup>Charlotte, NC</sup> 809

Elevations

# Don Duff y 301 Providence Rd Charlotte, NC 28207 (p)704 - 358 - 1878 (f)704 - 358 - 1721 www.donduffyarchitecture.com

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■ Date: 03.31.2014

Drawn By: J.A.Z.

• Sheet: A2.1 Tillman

Revisions:



-1X4 WOOD SHINGLE MOLD

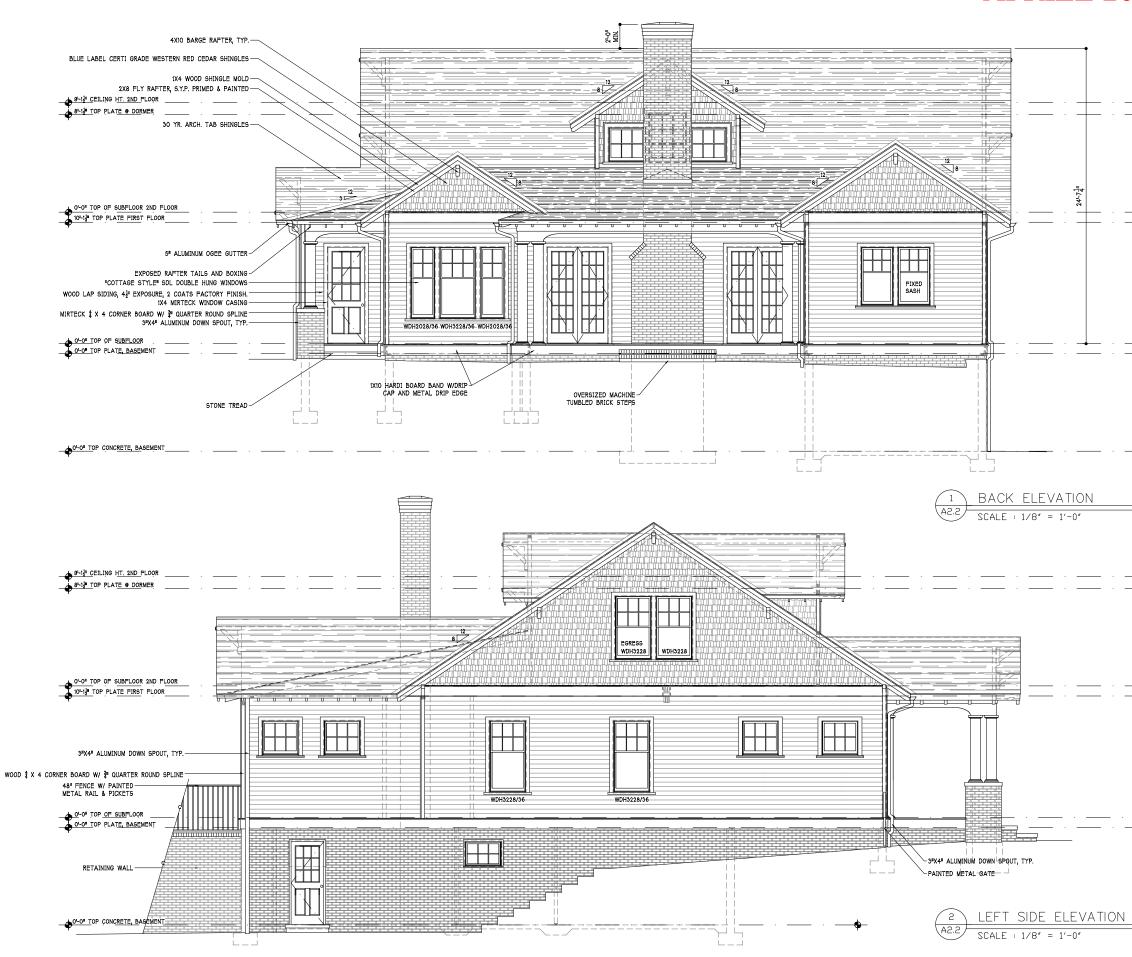
-2X8 FLY RAFTER, S.Y.P. PRIMED & PAINTED



WOOD LAP SIDING, 41 EXPOSURE, 2 COATS FACTORY FINISH. WODD \$ X 4 CORNER BOARD W/ ≹ QUARTER ROUND SPLINE - 3"X4" ALUMINUM DOWN SPOUT, TYP.

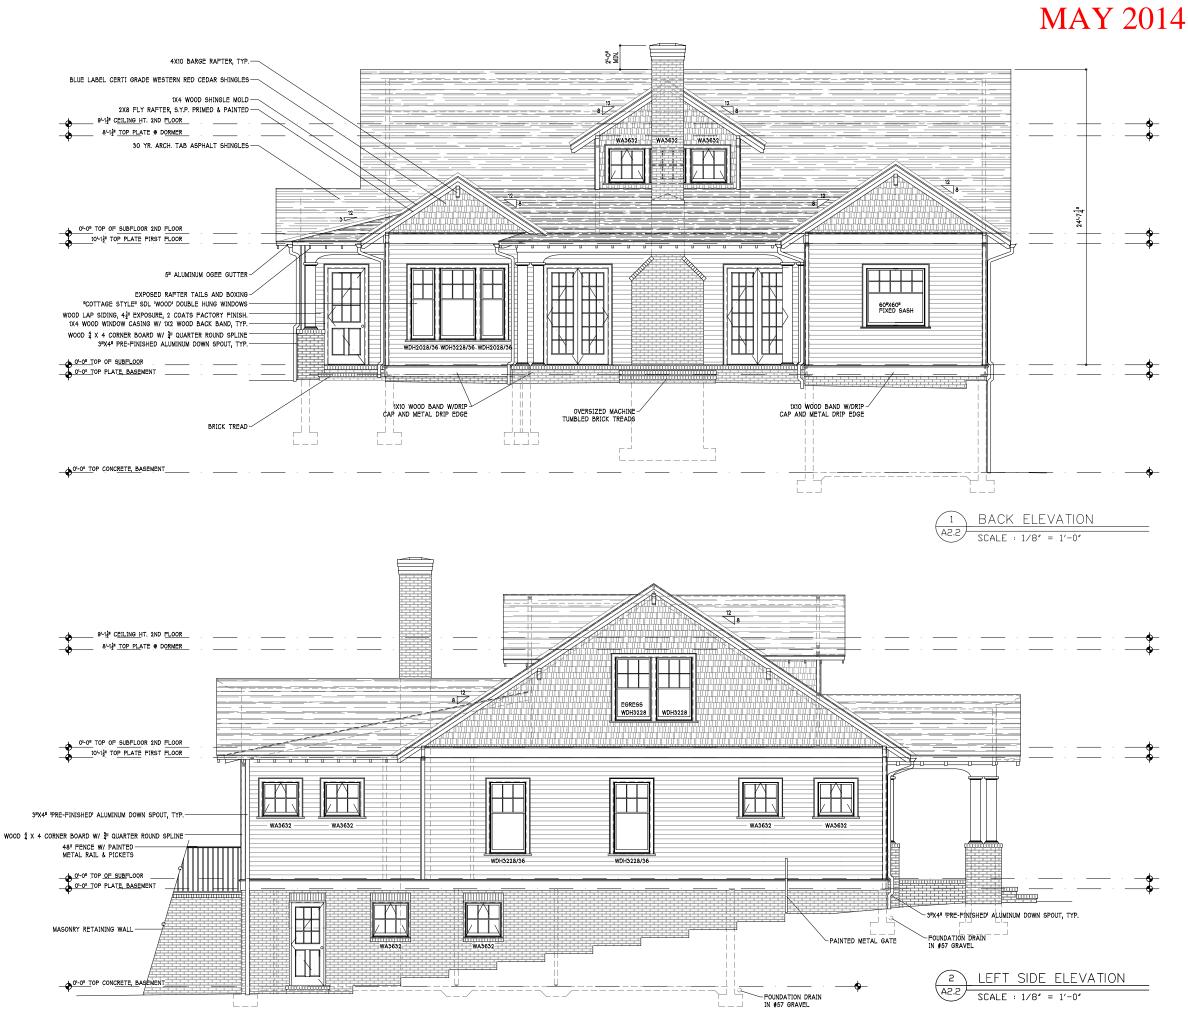
# Mount Vernon Avenue Charlotte, NC Tillman Residence 809 Elevations DonDuffy Architecture • 301 Providence Rd Charlotte, NC 28207 (p)704 - 358 - 1878 (f)704 - 358 - 1721 www.donduffyarchitecture.com THIS DRAWING IS AN INSTRUMENT OF SERVICE. THE DRAWING AND THE INFORMATION THEREON IS THE PROPERTY OF DON DUFFY ARCHITECT. ANY REPRODUCTION, ALTERATION, OR USE FOR OTHER THAN THE INTENDED PROJECT, WITHOUT THE WRITTEN CONSENT OF DON DUFFY ARCHITECT, IS EXPRESSLY FORBIDDEN. COPYRIGHT © DON DUFFY ARCHITEC Date: 04.24.2014 Revisions Drawn By: J.A.Z. • Sheet: A2.1

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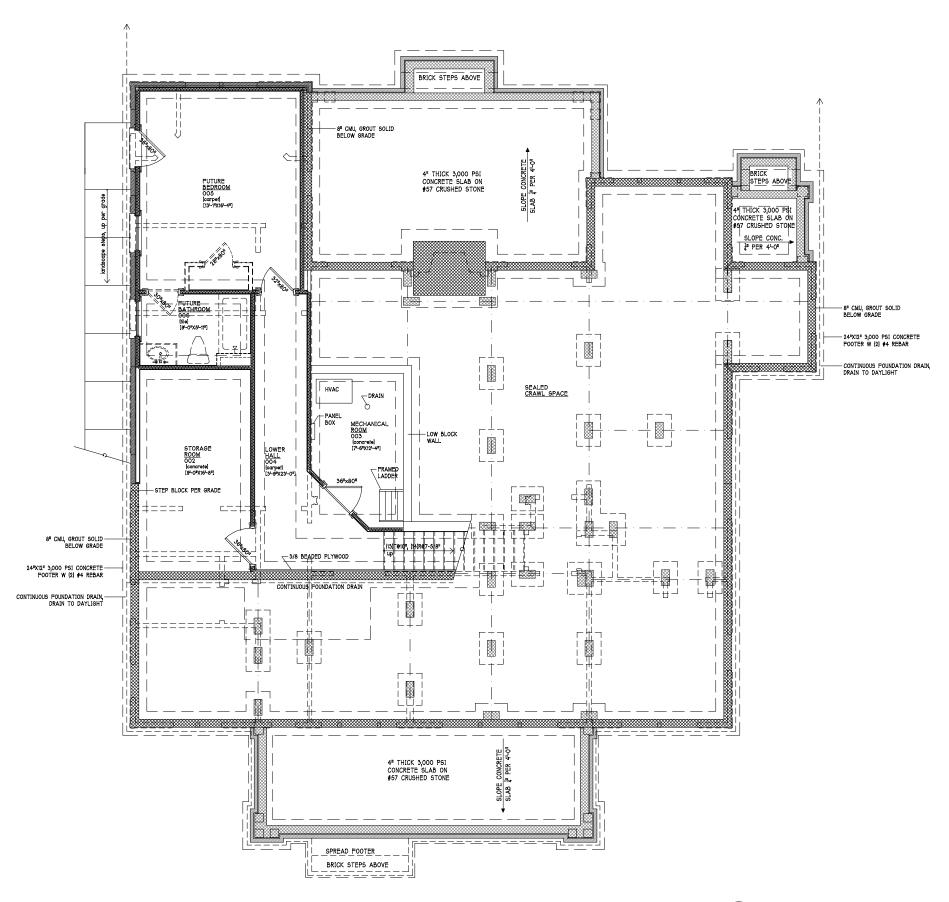


### APRILL 2014

Tillman Residence 809 Mount Vernon Avenue <sup>Charlotte, NC</sup>
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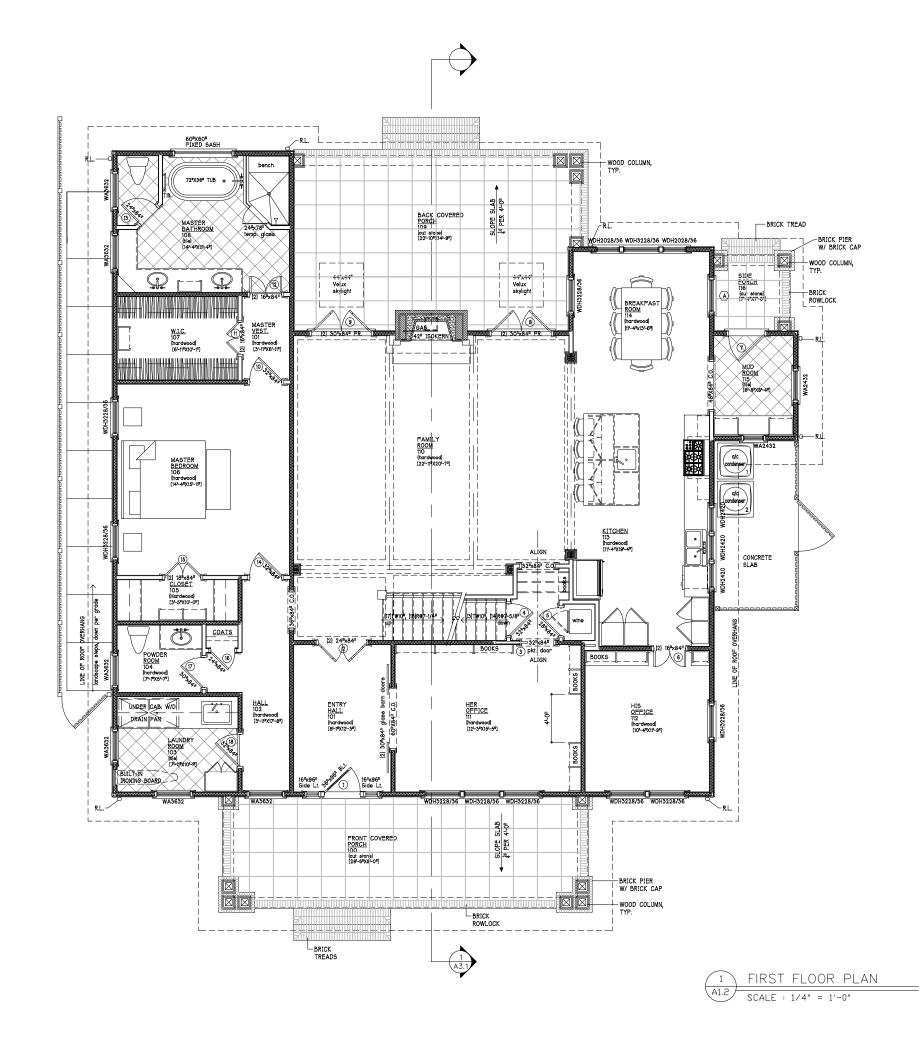


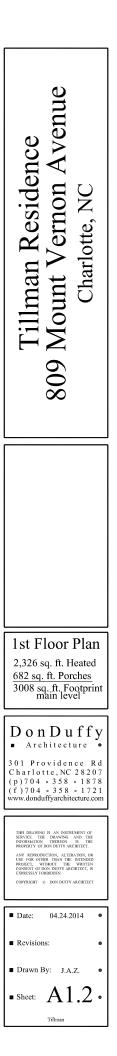
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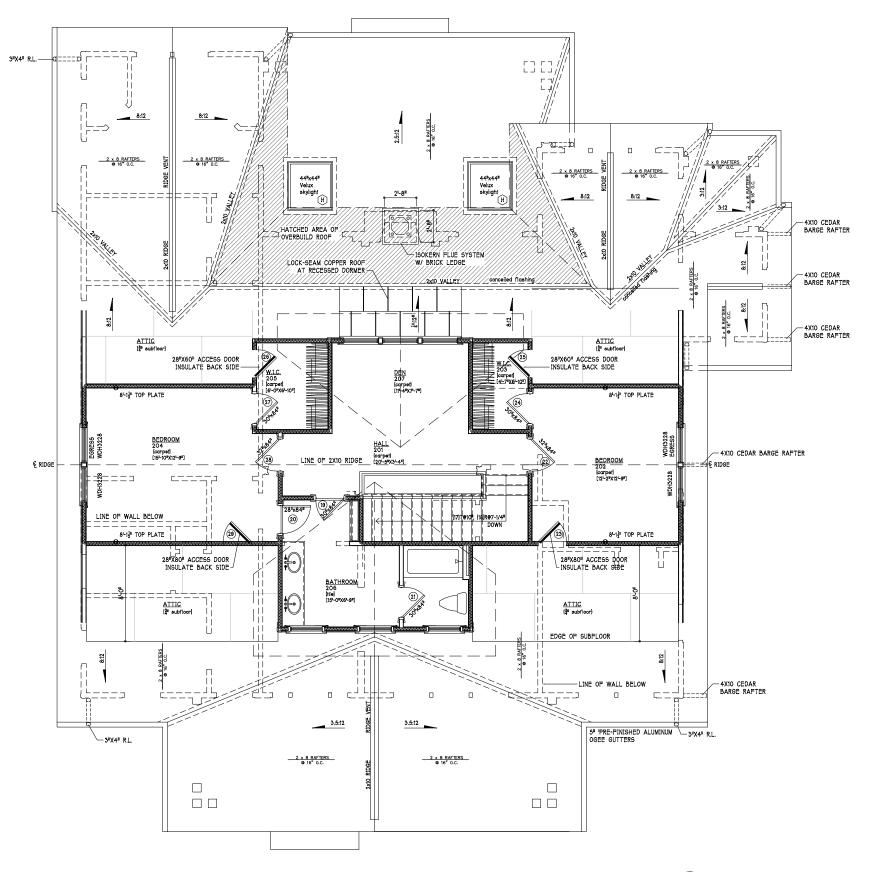


FOUNDATION & BASEMENT PLAN 1 A1.1 SCALE : 1/4" = 1'-0"

Tillman Residence 809 Mount Vernon Avenue <sup>Charlotte, NC</sup>
Basement & Foundation 512 sq. ft. heated 274 sq. ft. storage
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Date: 04.24.2014 •
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 SECOND FLOOR PLAN

 A1.3
 SCALE : 1/4" = 1'-0"

Tillman Residence 809 Mount Vernon Avenue <sup>Charlotte, NC</sup>
$\begin{array}{c} \begin{array}{c} \begin{array}{c} \text{2nd floor Plan} \\ 881 \text{ sq. ft. heated} \\ +524 \text{ basement htd.} \\ \hline +2,326 \text{ 1st flr. htd.} \\ \hline 3,731 \text{ total heated} \end{array} \end{array}$
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