Charlotte Historic District Commission Staff Review HDC 2013-119

Application for a Certificate of Appropriateness Date: September 11, 2013

LOCAL HISTORIC DISTRICT: Wilmore

PROPERTY ADDRESS: 1909 Wilmore Drive

SUMMARY OF REQUEST: Addition

OWNER: James & Melissa King

APPLICANT: Bob McGivern/6:48 Renovations

Details of Proposed Request

Existing Conditions

The existing single story, single family house was built in 1936. It has a single gabled roof extending from the hip roof on the front and covers the porch which has three supporting square columns. The home rests on a sloping site which falls to the rear. The current siding is vinyl and the brick foundation has been painted. The majority of the surrounding homes on the block are single story.

Proposal

The proposal is an addition at the rear of the home resulting in a second story that will tie into the existing roofline due to the slope of the land. The side elevation shows the addition lower than the existing roofline. The front (west) elevation shows a portion of the addition that will be visible from Wilmore Drive. The plan indicates painted brick to match the color of the siding. Existing mature trees would not be disturbed.

Proposal-Updated for September 11, 2013 Hearing

The application was deferred in August to address the siding material and windows along the new staircase. The plans have been revised to add German lap wood siding as a material option. The window on the stairtower matches the window on the new main floor.

Policy & Design Guidelines for Additions

HDC Design Policy for Additions requires that additions be evaluated according to the following:

a. Size	the relationship of the project to its site
b. Scale	the relationship of the building to those around it
c. Massing	the relationship of the building's various parts to each other
d. Fenestration	the placement, style and materials of windows and doors
e. Rhythm	the relationship of fenestration, recesses and projections
f. Setback	in relation to setback of immediate surroundings
g. Materials	proper historic materials or approved substitutes
h. Context	the overall relationship of the project to its surroundings

- 2. Additions must respect the original character of the property, but must be distinguishable from the original construction.
- 3. All additions to the front or side of existing properties must be of a design that is sensitive to the character and massing of the existing structure.
- 4. Additions to the front or side of existing structures that are substantially visible from a street must go before the full Commission.

Staff Analysis

Staff believes the proposal meets all of the Guidelines for Additions, provided wood siding is used as noted.

Regarding materials, the Guidelines (pages 48-49) state:

Traditional Building Materials

- 1. The use of historically traditional building materials is strongly encouraged in all renovation, addition and new construction projects in Local Historic Districts.
- 2. Historic precedents in the visual context of any project indicate appropriate choices for building materials.
- 3. All building materials must match the character of the existing structure and/or the streetscape in design, texture and other visual qualities.

Non-Traditional Building Materials

- 1. The Historic District Commission considers substitute siding to be inappropriate for use in a designated Local Historic District, and does not allow its use on an historic structure within a Local Historic District.
- 2. The use of the following substitute siding materials is considered incongruous with the overall character of local historic districts, and is prohibited.
 - Vinyl
 - Aluminum or other metal sidings
 - Masonite
- 3. Cementitious board products are rarely considered appropriate for the main structure on a property. The Historic District Commission will consider these products on a case by case basis.
- 4. All proposals for the use of other non-traditional building materials for projects in Local Historic Districts will be judged on a case-by-case basis by the full Historic District Commission. The Commission will determine how well the proposed material and its proposed use are contextually appropriate in design, texture and other visual qualities.
- 5. The use of substitute or replacement building materials will not be considered as an alternative to routine maintenance.



The scope of this proposed project is to build an addition off the rear of the client's existing home per the attached plans.

This addition, if approved, will include approximately 600 SF of new lower level (basement / storage) space and 600 SF of corresponding bedrooms and baths upstairs for the growing family. Their son was born in May of this year and they were already in need of more space before his arrival!

Both levels will be tied into the existing structure, which will be accessible from the new space at both the upper and lower levels, as you will note on the plans.

The addition will be very close to in-line with the existing structure with only a 3' offset, which is needed to meet zoning requirements on the right hand side of the home as viewed from the street.

We do not think the offset will impact the street view (or streetscape) <u>whatsoever</u> if it is even visible from the street. Unless one stops to look for it, it will not even be noticed. The reason for this opinion is: The lot slopes significantly from front (street side) to back where we propose to build the addition.

The proposed siding / exterior finish material for this project is vinyl, to match the existing home and windows will

This scope of work does not call for changing any existing rooflines or finish materials on the existing home. We will also not touch landscaping or existing trees.

Respectfully,

Robert E. McGivern, Jr. Family Construction & Remodeling, LLC dba 6:48 Renovations





1909 WILMORE DRIVE CHARLOTTE NC 28203 JKING242@GMAIL.COM KING HOME RENOVATION

SITE PLAN

PROJECT#	2013_01
DATE	2013.07.16
DRAWN BY	JK
REVISION #	-

A105

Scale 1" = 30'-0"

* EXISTING RESIDENCE OF JAMES ; MEUSSA KING DOTTED LINES REPRESENT PROPOSED ADDITION 3' OFFSET TO MEET ZODING REQUIREMENT ON STHERSINE PROPOSED ADDITION EXISTING 21' DEEP * 26' WEDE KITIG RESIDENCE DITE ROUGHLY TO SCALE 1909 WILMORE













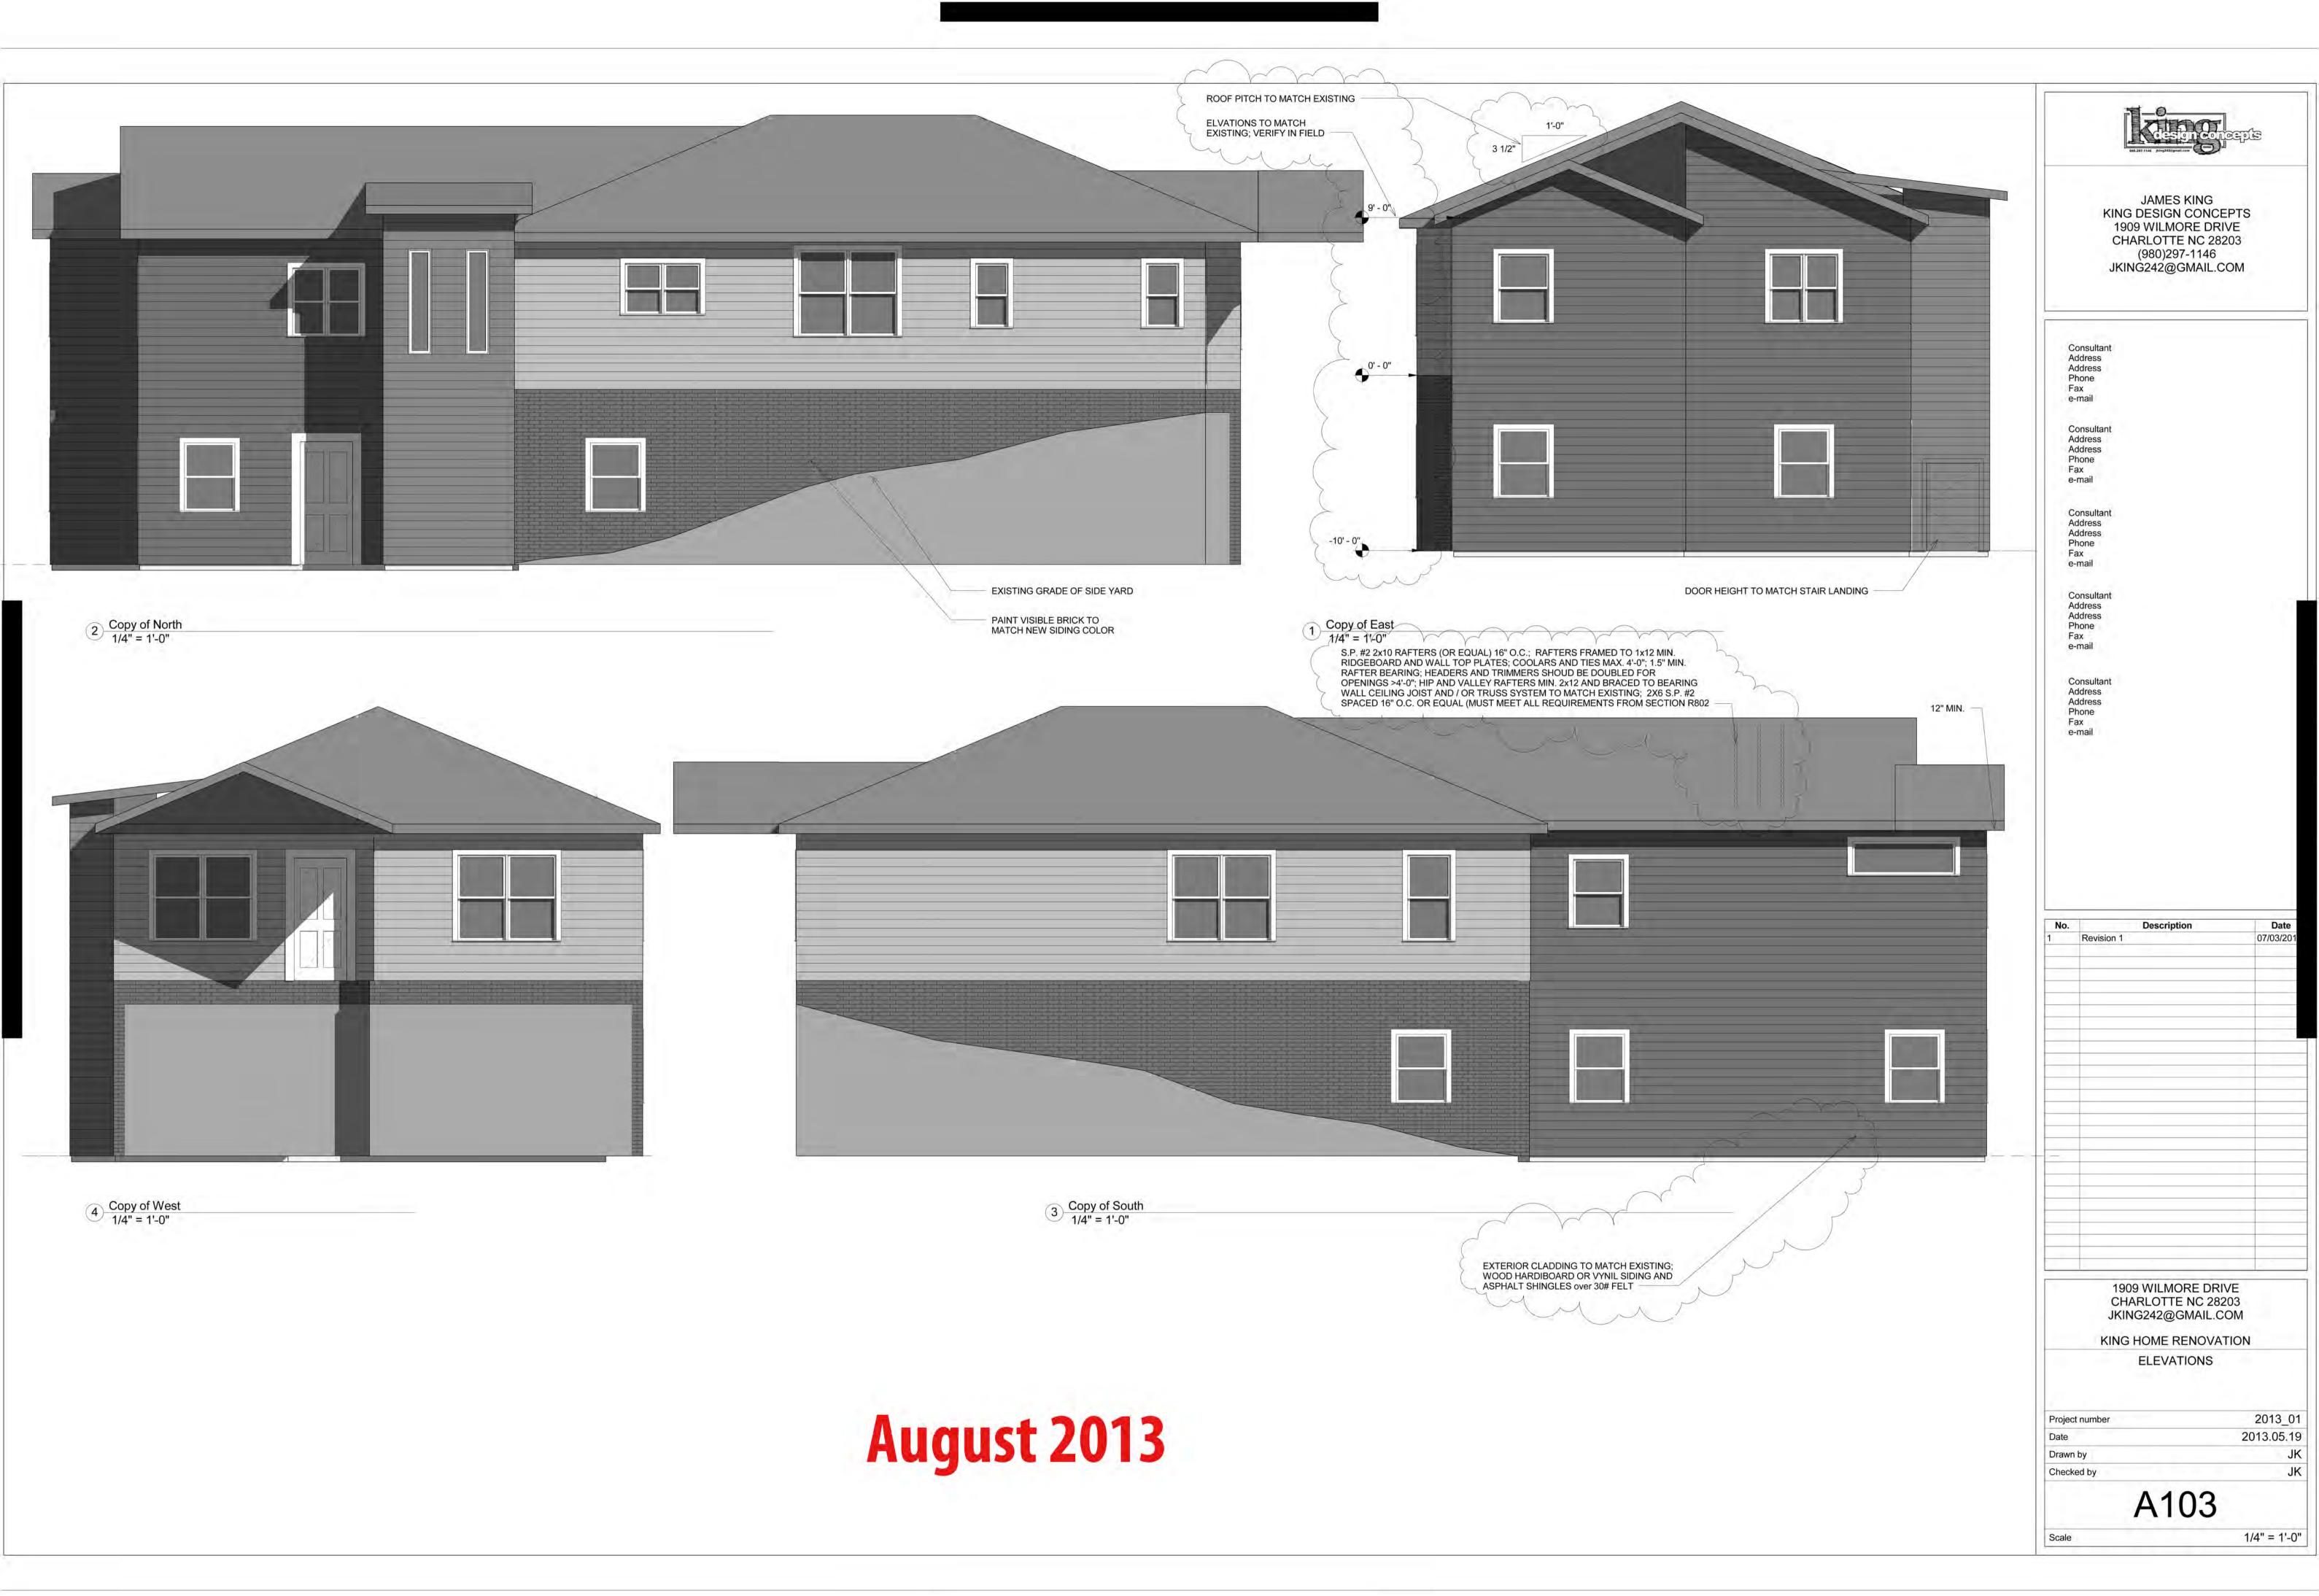

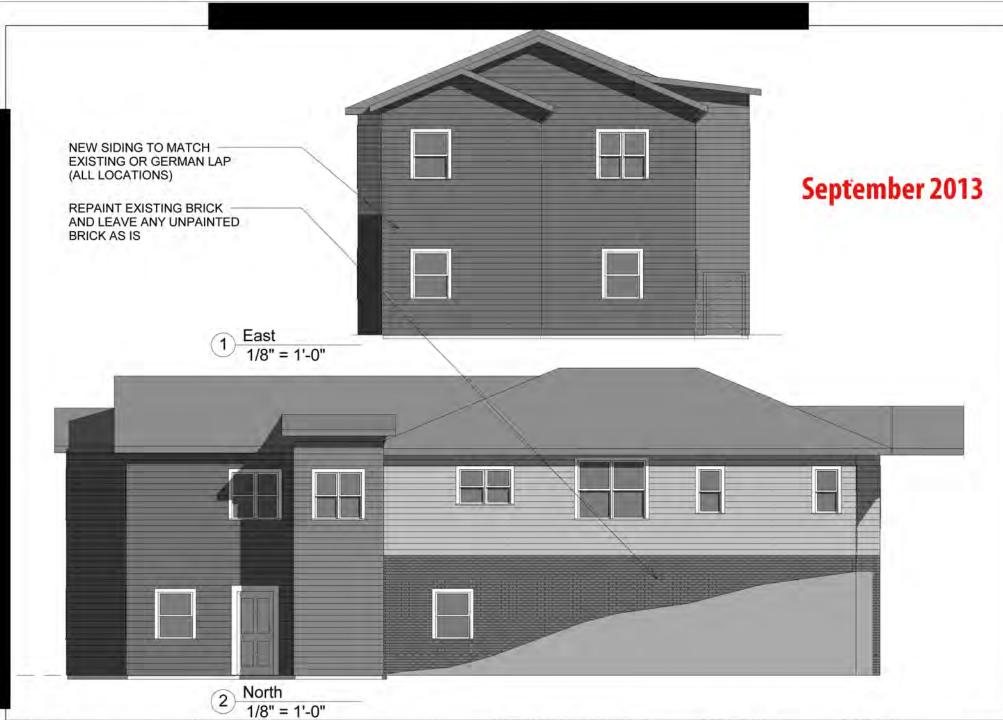

80.257.1146 /king242(synal.com

1909 WILMORE DRIVE CHARLOTTE NC 28203 JKING242@GMAIL.COM KING HOME RENOVATION

ELEVATIONS (E & N)

PROJECT#	2013_01
DATE	2013.07.16
DRAWN BY	JK
REVISION#	0

A03

Scale 1/8" = 1'-0"



September 2013

2 West - 1/8" = 1'-0"



1 South 1/8" = 1'-0"



1909 WILMORE DRIVE CHARLOTTE NC 28203 JKING242@GMAIL.COM KING HOME RENOVATION

ELEVATIONS (W & S)

PROJECT#	2013_01
DATE	2013.07.16
DRAWN BY	JK
REVISION#	01


A04

Scale 1/8" = 1'-0"







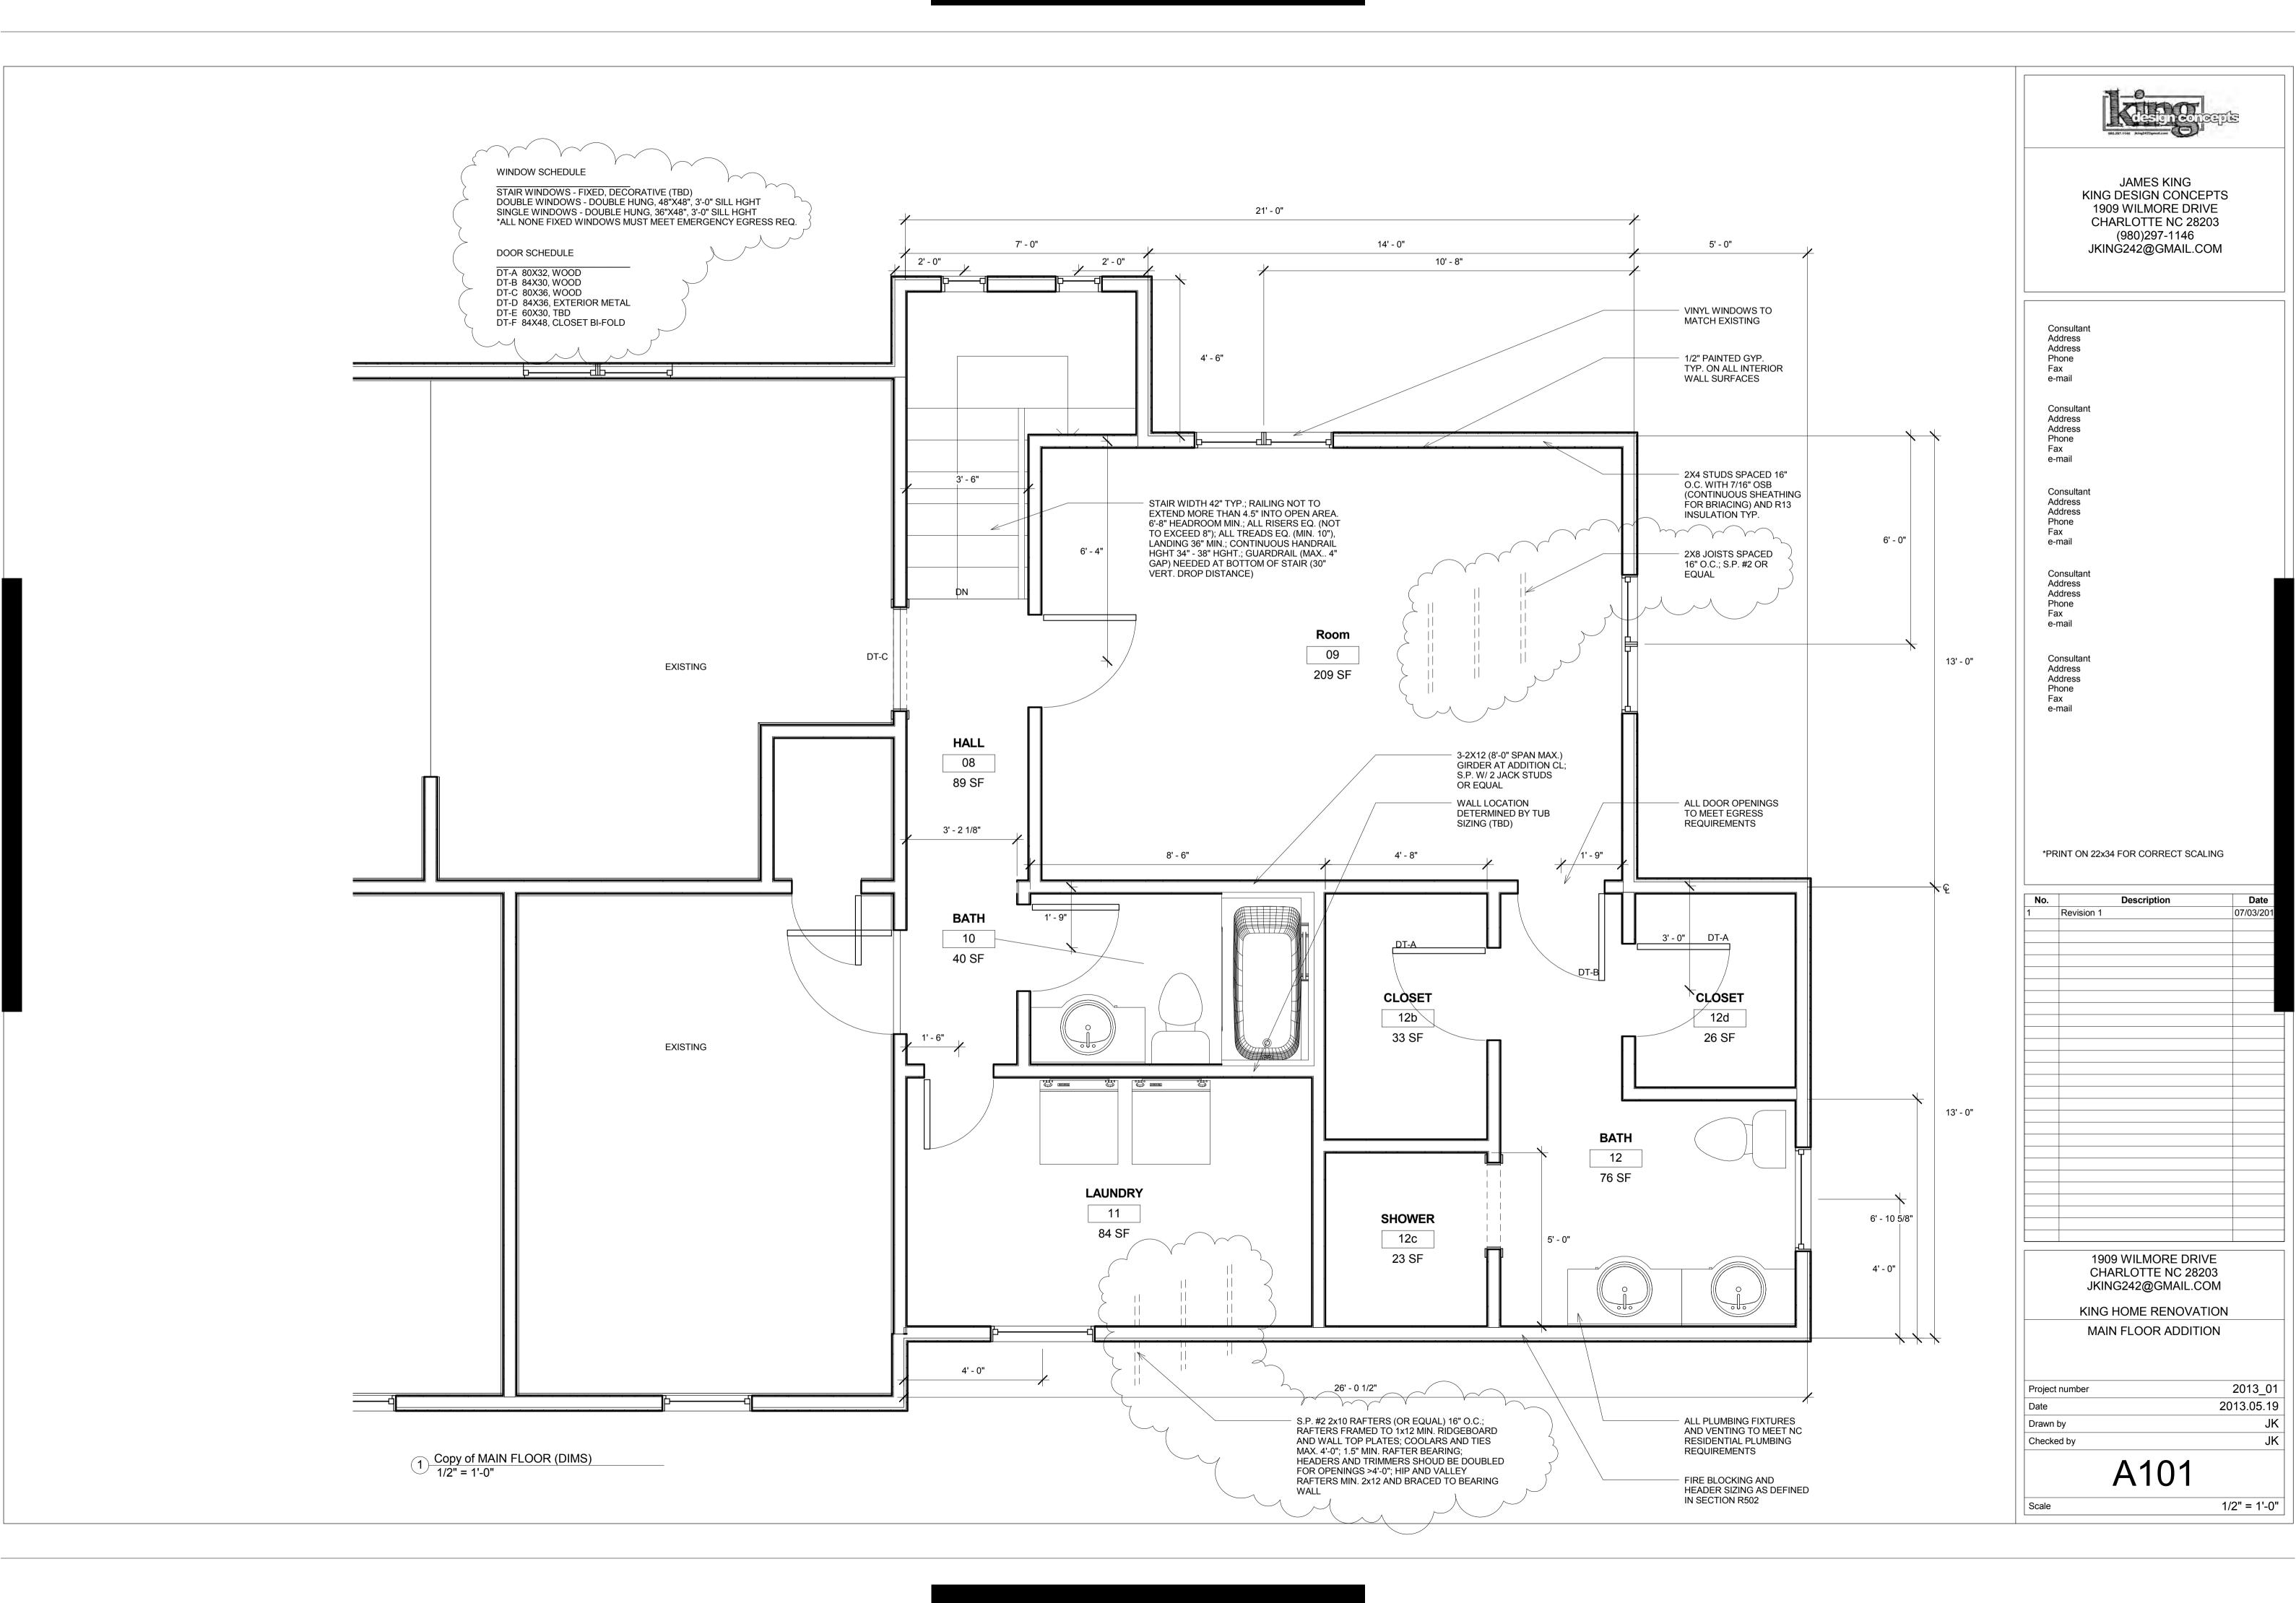

Project Title: 1909 WILMORE DRIVE

Energy Code:

2009 IECC Mecklenburg County, North Carolina Single Family Addition Location:

Construction Type: Project Type:

Bldg. orientation unspecified Building Orientation: Glazing Area Percentage: 9%

Heating Degree Days: Climate Zone:

Designer/Contractor: Construction Site: Owner/Agent:


Compliance: Passes using UA trade-off

Maximum SHGC: 0.30 Your SHGC: 0.30 Compliance: 13.3% Better Than Code Maximum UA: 196 Your UA: 170

The % Better or Worse Than Code index reflects how close to compliance the house is based on code trade-off rules. It DOES NOT provide an estimate of energy use or cost relative to a minimum-code home.

Gross Area or Perimeter	Cavity R-Value	Cont. R-Value	Glazing or Door U-Factor	UA
468	13.0	0.0		34
48			0.320	15
468	13.0	0.0		35
24			0.320	8
21			0.400	8
458	13.0	0.0		34
48			0.320	15
640	30.0	0.0		21
	Area or Perimeter 468 48 468 24 21 458 48	Area or R-Value Perimeter 468 13.0 48 468 13.0 24 21 458 13.0 48	Area or R-Value R-Value Perimeter 468 13.0 0.0 48 468 13.0 0.0 24 21 458 13.0 0.0 48	Area or Perimeter R-Value R-Value or Door U-Factor 468 13.0 0.0 48 0.320 468 13.0 0.0 24 0.320 21 0.400 458 13.0 0.0 48 0.320

Compliance Statement: The proposed building design described here is consistent with the building plans, specifications, and other calculations submitted with the permit application. The proposed building has been designed to meet the 2009 IECC requirements in REScheck-Web and to comply with the mandatory requirements listed in the REScheck Inspection Checklist.

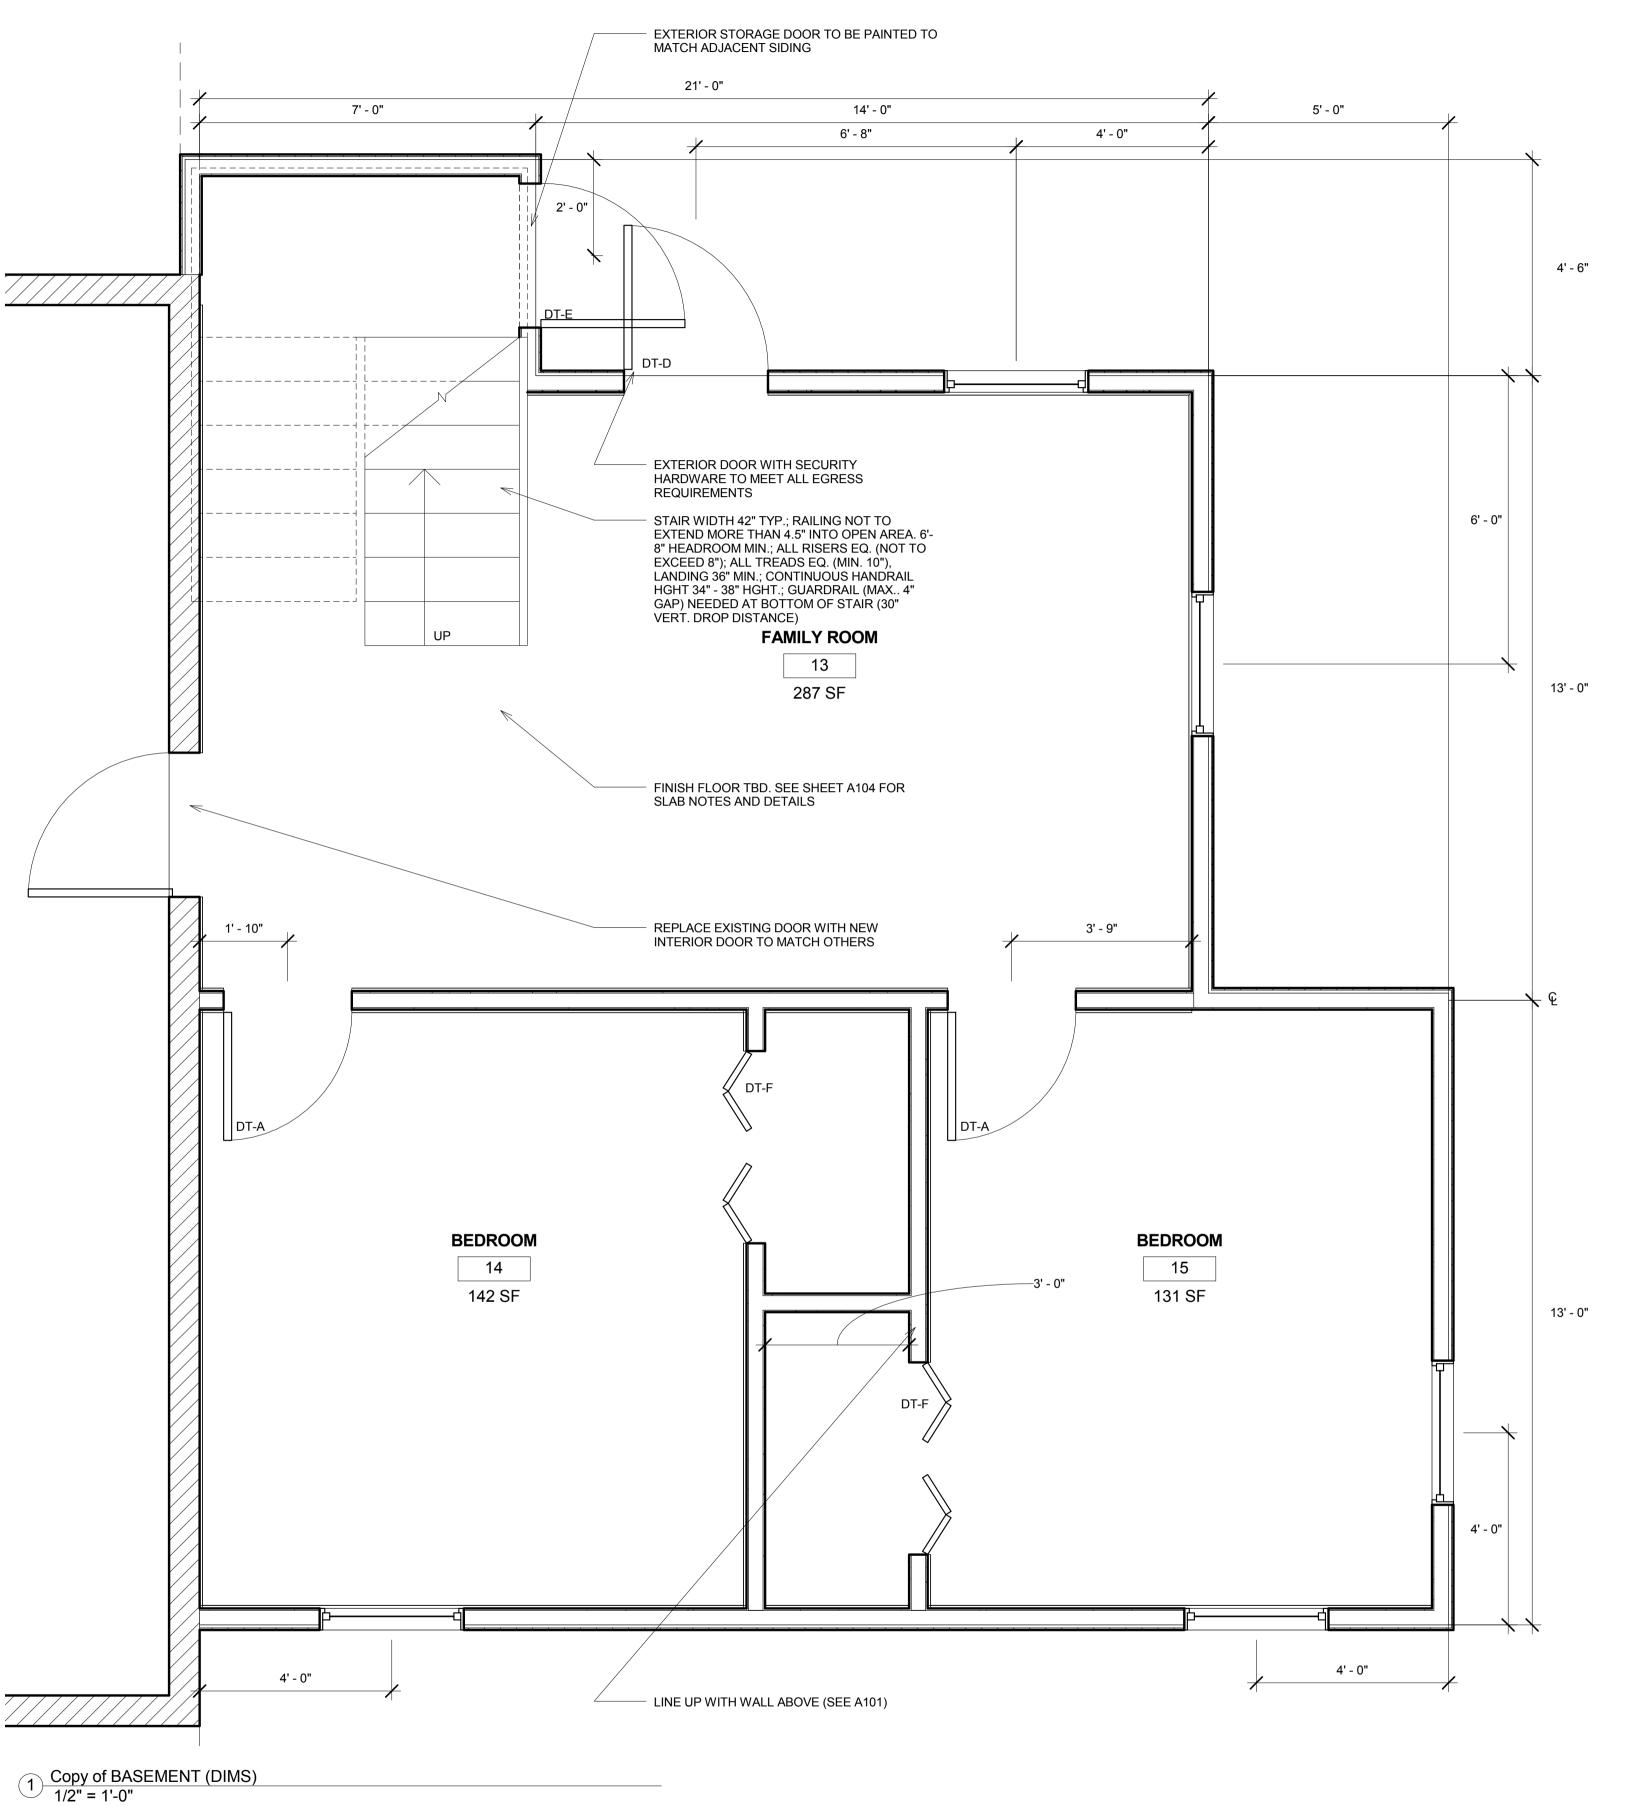



JAMES KING KING DESIGN CONCEPTS 1909 WILMORE DRIVE CHARLOTTE NC 28203 (980)297-1146 JKING242@GMAIL.COM

Consultant Address Address Phone Fax e-mail Consultant Address Address Phone Fax e-mail

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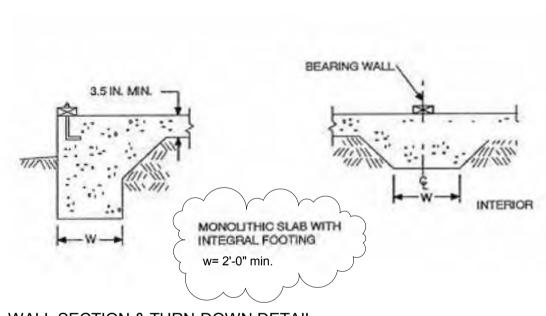
JKING242@GMAIL.COM

KING HOME RENOVATION BASEMENT ADDITION

Project number	2013_0
Date	2013.05.1
Drawn by	J
Checked by	J

A102

1/2" = 1'-0"



2 WALL SECTION & TURN-DOWN DETAIL

01. ALL STRUCTURAL FRAMING TO MEET SECTION R502 REQUIREMENTS
02. TYPICAL WALL CONSTRUCTION IS 2X4 STUDS SPACED 16" O.C. WITH R-13 INSULATION AND 7/16" OSB SHEATHING; 8.0 CONTINUOUS

SHEATHING 30' MIN. OR EQUAL (MUST MEET R602.10.1.2)

03. SEE DRILLING AND NOTCHING PROVISIONS IN SECTIONS R502.8 AND R602.6

04. MINIMUM R-30 INSULATION IN ATTIC SPACE ABOVE NEW ADDITION

05. CEILING JOIST TO MATCH EXISTING; 2X6 S.P. #2 SPACED 16" O.C. OR EQUAL (MUST MEET ALL REQS. FROM SECTION R802)

06. ROOF PITCH TO MATCH EXISTING (SEE ELEVATIONS) 07. ALL FLASHING MUST MEET ASTM E 2112 AND/OR AMMA 711 FOR WINDOWS, DOOR, GUTTER AND WALL / CEILING TRANSITION

LOCATIONS (SECTIONS R703, R903 AND R905)

08. SLAB TURNODOWN IN ALL BEARING LOCATIONS TO BE CONTINUOUS 2'-0" X 8" MIN. (MUST MEET TABLE R403.1 REQUIREMENTS) 09. 8" FOUNDATION WALL THICKNESS MIN.

10. 6 MIL. VAPOR BARRIER AND TERMITE CONTROL TO BE THROUGHOUT THE LOWER SLAB AND FOUNDATIONS AREA AND MEET THE


REQUIREMENTS OF SECTIONS R506.2.3 AND R318.1 11. FOUNDATION TO MEET ALL WATER- / DAMP-PROOFING REQUIREMENTS AS PER SECTION R406

12. UPPER FLOOR SHEATHING TO BE MIN. 5/8" (SPECIES GROUP 2/3)

13. WALL HEADER SIZE TO BE 2-2x8 MIN.; ALL CONCENTRATED LOADS TO BEAR WITHIN 5" OF STUDS BENEATH.

14. ALL CEILING OPENINGS GREATER THAN 4'-0" MUST BE SUPPORTED BY A DOUBLE JOIST

15. JACK STUDS REQUIRED FOR OPENINGS GREATER THAN 4'-0"
16. ATTIC ACCESS FROM EXISTING BUILDING
17. CONTRACTOR IS RESPONSIBLE FOR CHECKING ALL PERTINENT CODE REQUIREMENTS BEFORE INSTALLING AND / OR CONSTRUCTING ANY PORTION OF THE STRUCTURE.

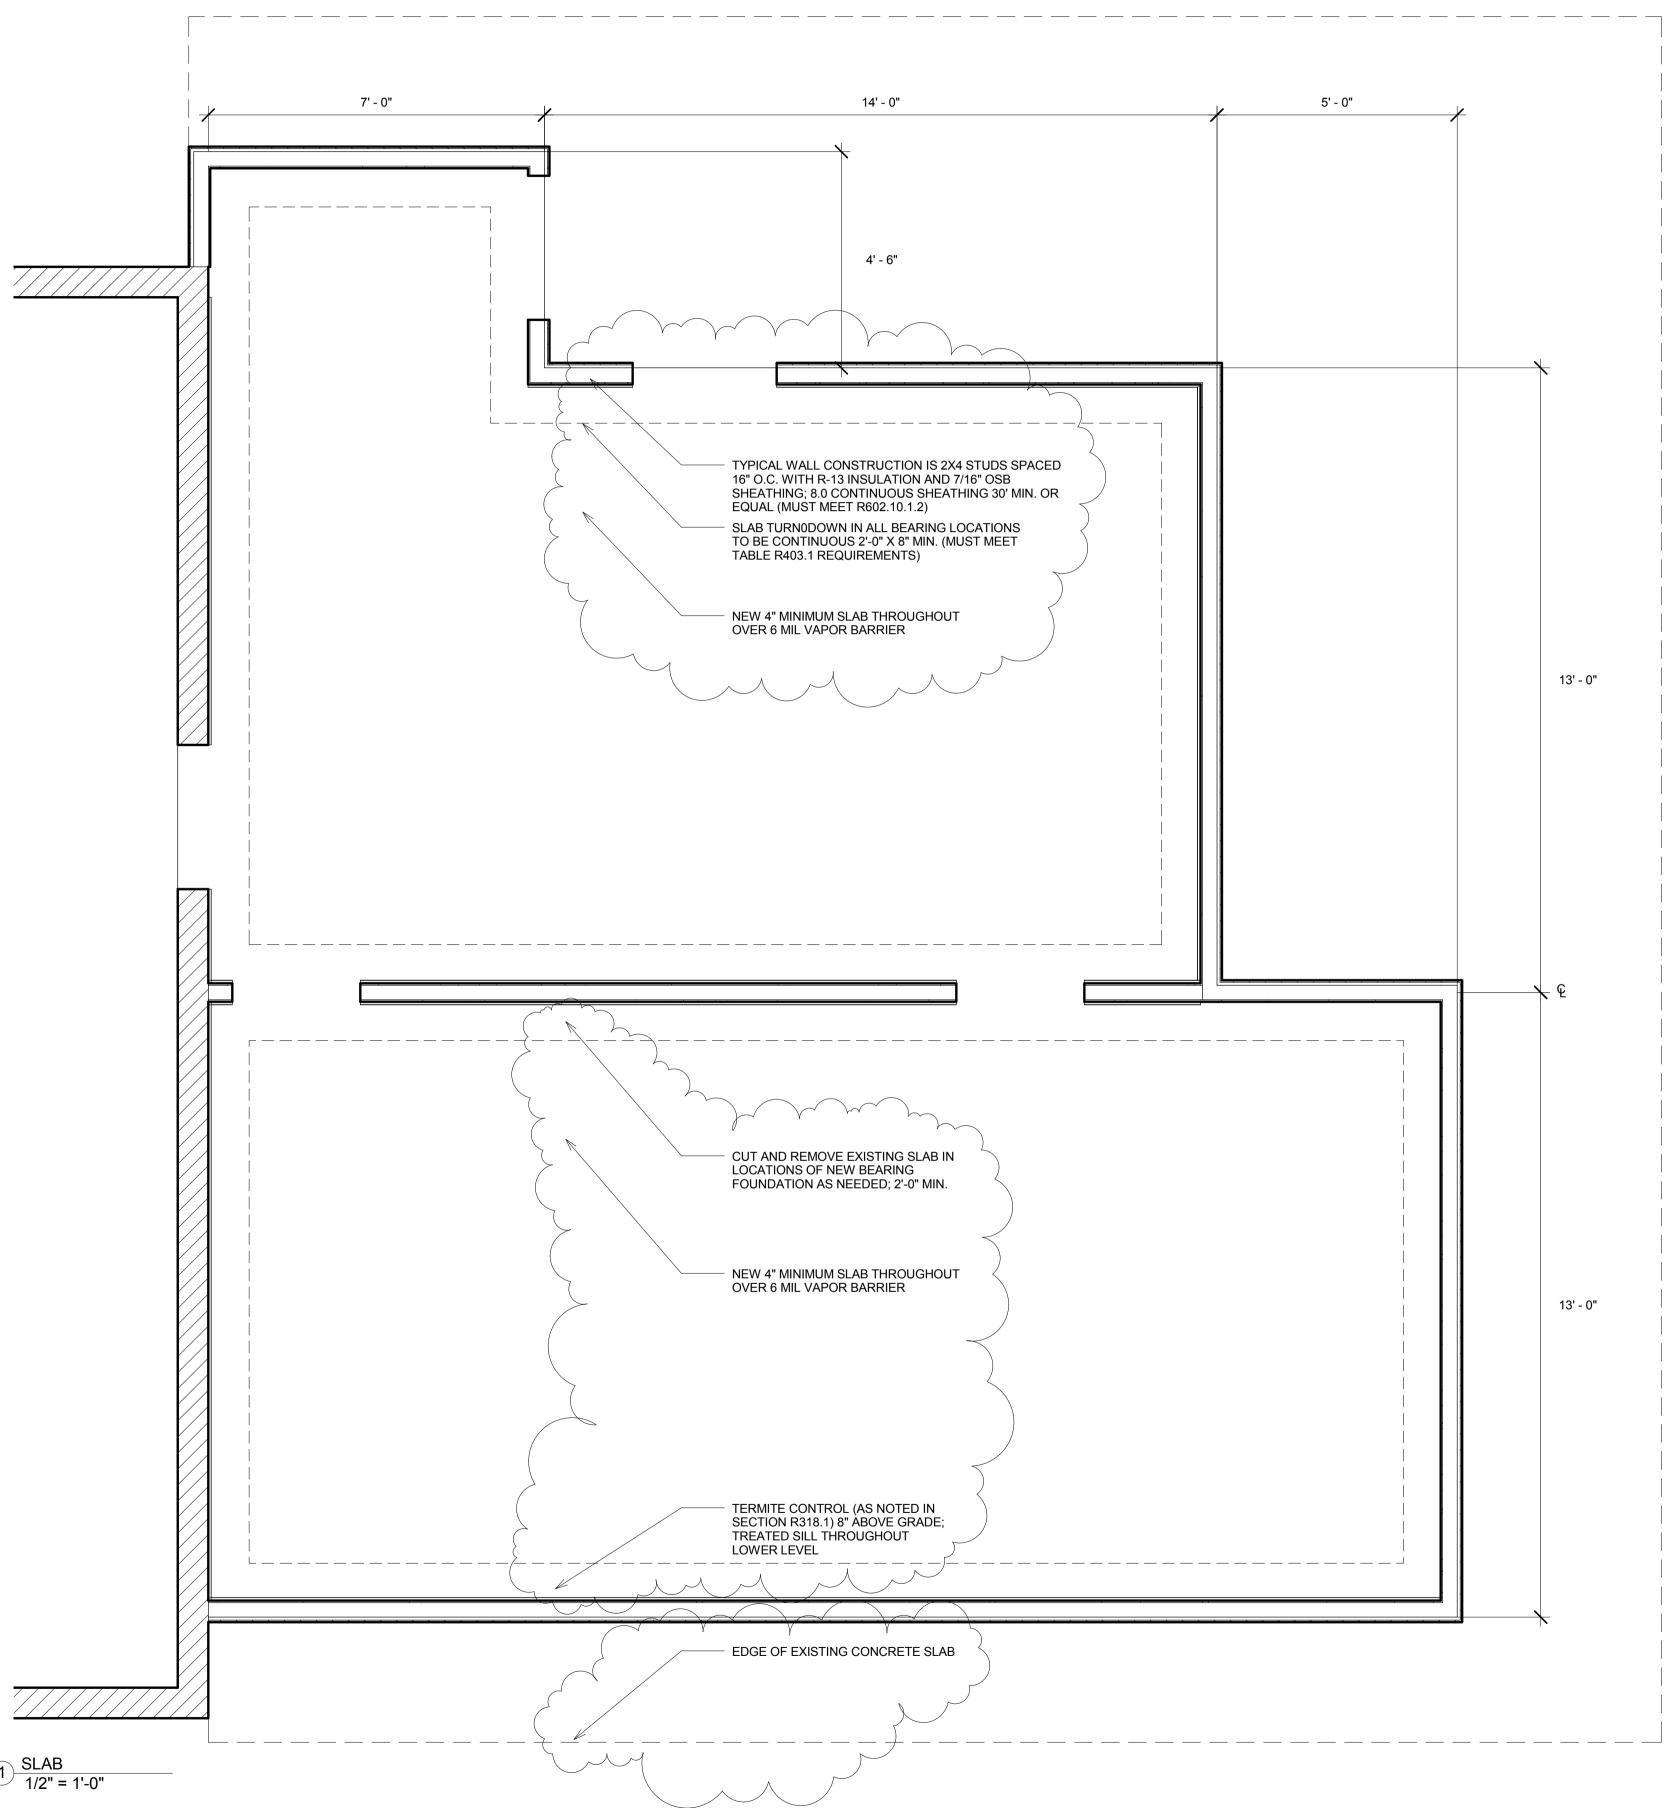



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Consultant Address Address Phone Fax e-mail Consultant Address Address Phone e-mail Consultant Address Address Phone Fax e-mail Consultant Address Address Phone Fax e-mail Consultant Address Address Phone Fax

Description	Date
Revision 1	07/03/201
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1909 WILMORE DRIV	

CHARLOTTE NC 28203 JKING242@GMAIL.COM

KING HOME RENOVATION SLAB AND SECTION

Project number 2013_01 2013.05.19 Date Drawn by Checked by

A104

1/2" = 1'-0"