PCCO SI	UMMARY
Original Parcel ID Number(s):	159-061-03,159-061-75,159-061-80
Development Type:	Single-Family
Subject to PCCO? Y/N	Yes
If NO, why?	
Watershed:	Central Catawba
Disturbed Area (ac):	3.45
Site Area (ac):	6.19
	DA#1
Total on-site Drainage Area (ac):	5.48
Existing Built-upon-area (SF):	0
Existing BUA to be removed (SF):	0
Existing BUA to remain (SF):	0
Proposed New BUA (SF):	78,100
Proposed % BUA:	32.72
Density (High / Low)	High
Total Post—Project BUA for site:	78,100
Development or Redevelopment?	Development
Natural Area Required (ac):	0
Natural Area provided, total (ac):	0
Undisturbed Treed Natural Area Preserved (ac):	0
Total stream buffer protected on-site (ac):	0.33
Transit Station Area? Y/N	No
Distressed Business District? Y/N	Yes
Mitigation Type (if applicable)	1yr 24hr vol & 10yr 6hr peak
Natural Area mitigation? Y/N	N/A
Buffer Mitigation? Y/N	N/A
Total Phosphorous Mitigation? Y/N	N/A

DRAWING INDEX

SHEET NO.	DESCRIPTION
C1	EXISTING CONDITIONS
C1.1	SITE PLAN
C2	ROAD LAYOUT PLAN
C3	GRADING & STORM DRAINAGE PLAN
C4	STORM DRAINAGE PROFILES
C5	ROAD PROFILES
C6	EROSION CONTROL PLAN - PHASE 1
C6.1	EROSION CONTROL PLAN - PHASE 2
C7	SITE DETAILS 1
C8	SITE DETAILS 2
C9	SITE DETAILS 3
C9.1	SITE DETAILS 4
C10	DRY POND DETAILS
C11	LANDSCAPE DETAILS
C12	NOTES STREETS/SIDEWALKS/STORM DRAINAGE

CONSTRUCTION PLANS ROR THE OAKS AT OAKHURST

PLAN REVISION SUBMITTAL MAY 2018


CAROLINA LAND SOLUTIONS, PLLC

CHARLOTTE.


TREE ORDINANCE

CDOT

LICENSE NO. P-0904 PO BOX 49116 CHARLOTTE, NC 28277 PH 704.724.2235 FAX 704.544.3988

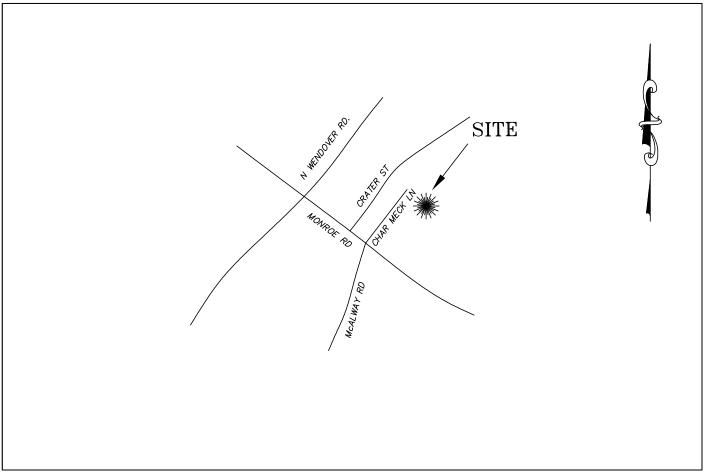

VICINITY MAP NOT TO SCALE

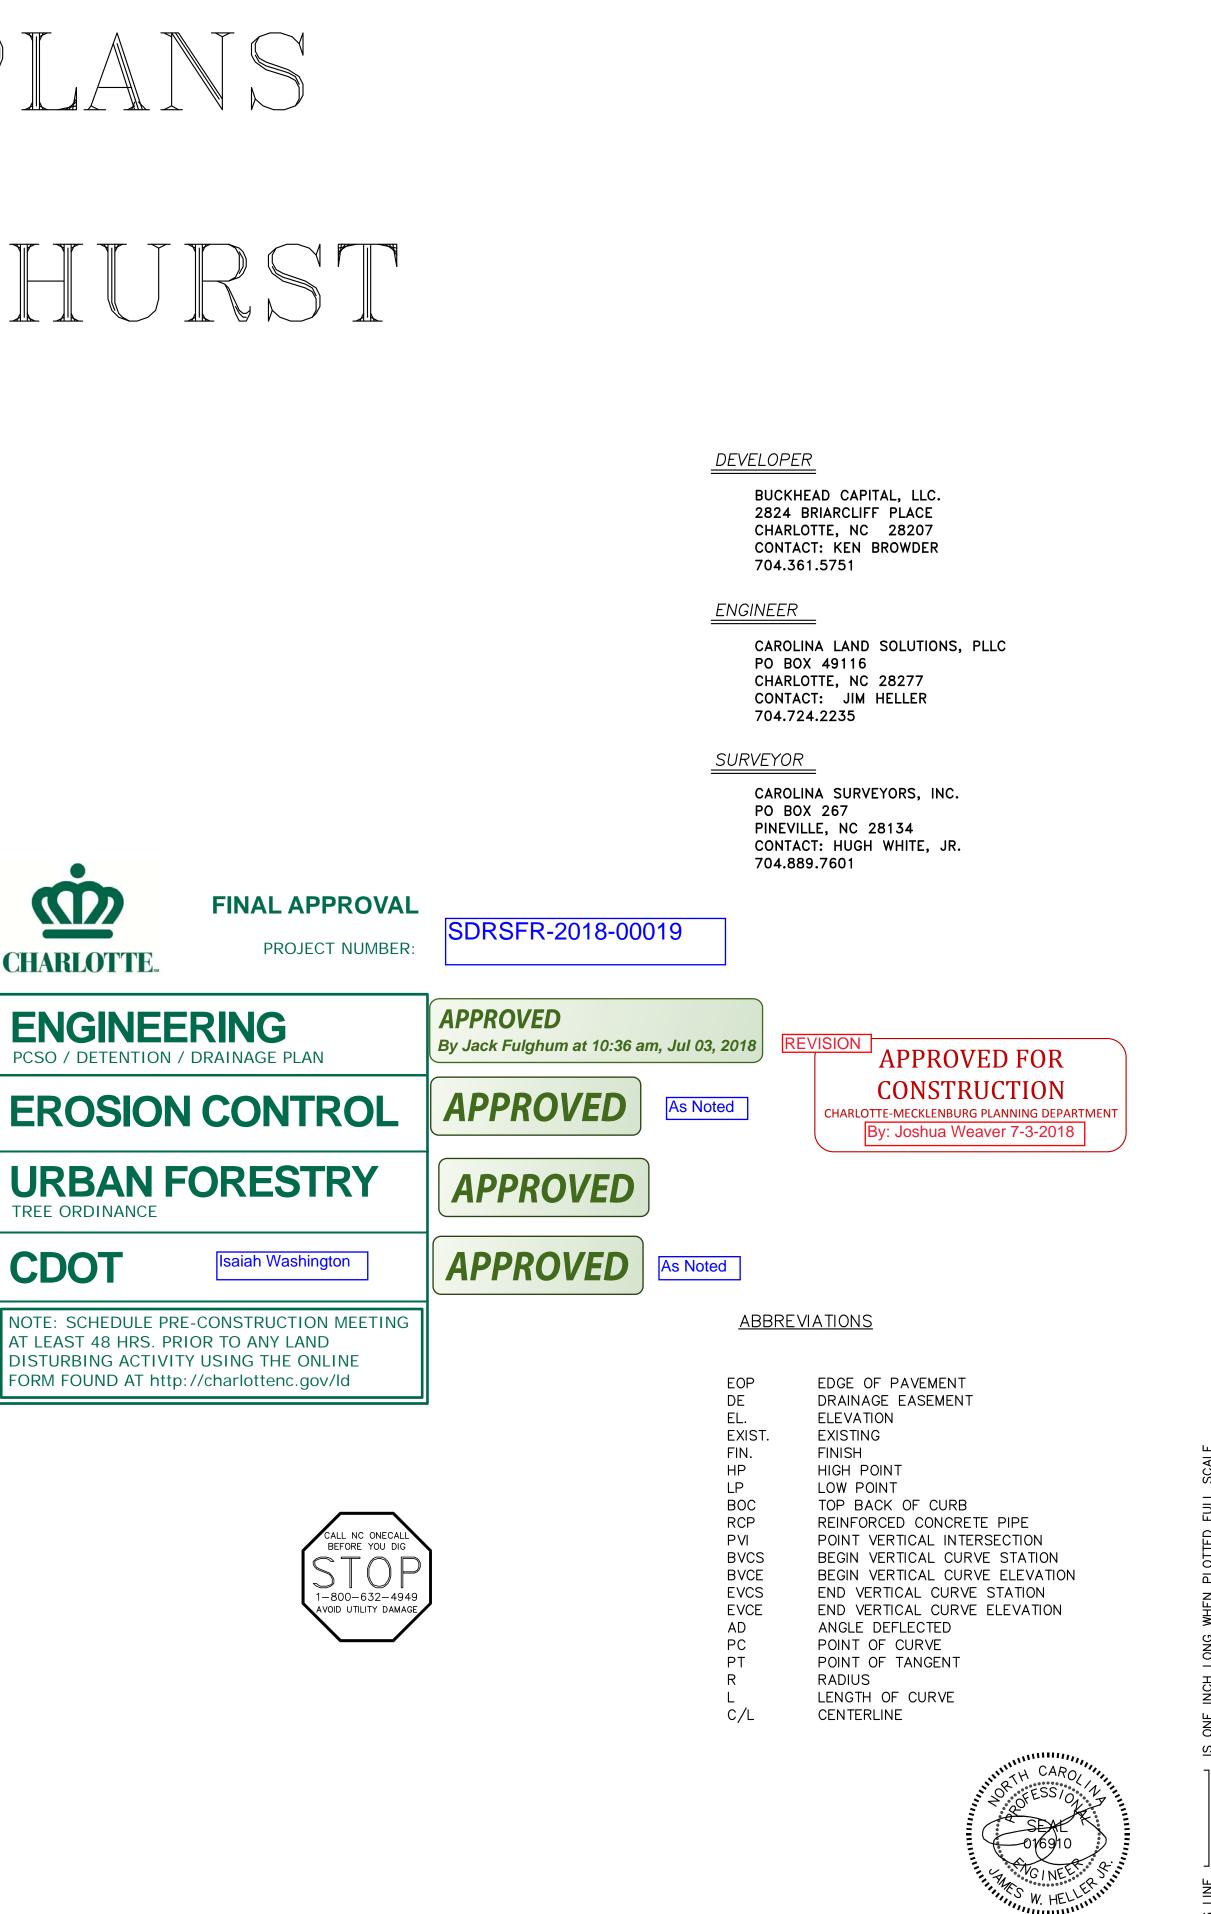

5/14/2018 12-14-2017 REV 1 - Response to cycle 1 plan review eveloper

GENERAL NOTES:

- 1. Parcel Identification Numbers : 159-06-103, 159-06-175, and 159-06-180
- 2. Total project area: 6.19± acres
- 3. Current zoning of this property, from Char-Meck GIS, is R-5 which has the following standards: Minimum Lot Width: 50' Front setback: 17' Side yard: 5' Rear yard: 35' Max. Height: 40' Minimum Lot Area: 6,000 sq.ft. Garage setback: 20'
- 4. Property line and other location information based on survey by Carolina Surveying, Inc. dated September 25, 2017.
- 5. Lot lines, dimensions, and lot areas shown are approximate and subject to change based on final survey
- 7. FEMA Flood Insurance Rate Map (FIRM) 3710456300K dated February 19, 2014 shows these parcels located in Zone X and are not located in a FEMA/Community floodplain.
- 8. Maintenance of the tree save area on each lot will be the responsibility of the lot owner.

IMPERVIOUS CALCULATIONS

BUILDING AREA (16X2,900)	46,400 SQ. FT.
NEW ROAD	24,400 SQ. FT.
NEW SIDEWALK	7,300 SQ. FT.
TOTAL IMPERVIOUS AREA	78,100 SQ. FT. (1.793 AC.)

THE SUBDIVISION IS LOCATED IN THE CENTRAL CATAWBA DISTRICT AND IS CONSIDERED HIGH DENSITY WITH A BUA GREATER THAN 24%.

1.793/5.48 = 32.72%

TREE CALCULATIONS

TOTAL % IMPERVIOUS

LEVY WAY ROAD FRONTAGE 1,350 FT. STUB STREET ROAD FRONTAGE 330 FT.

LEVY	WAY	TRE	ES	RE	QUIRED		1,350/40	=	34
LEVY	WAY	TRE	ES	PR	OVIDED			=	34
STUB	STRE	EET	TRE	ES	REQUIRE	D	330/40	=	8
STUB	STR	EET	TRE	ES	PROVIDE	D		=	8

MAX. IMPERVIOUS PER LOT

BUILDING	FOOTPRINT		SQ. SQ. SQ.	FT.
DRIVEWAY MISC.		2,900	SQ.	FT.
TOTAL				

<u>TREE SAVE AREA</u>

TOTAL SITE AREA MIN. TREE SAVE AREA REQUIRED TREE SAVE AREA PROVIDED

6.19 AC. 26,964 SQ. FT. - 0.619 AC (10%) 27,320 SQ. FT. - 0.627 AC (10.13%)

MONROF ROAD

<u>NATURAL AREA</u>

THIS PROPERTY IS LOCATED IN A DISTRESSED BUSINESS DISTRICT AND QUALIFIES FOR A MITIGATION OPTION THAT ELIMINATES THE NATURAL AREA REQUIREMENT BY PROVIDING 1-YEAR 24 HR. VOLUME CONTROL, 10 YEAR 6-HR. PEAK CONTROL, AND 25 YEAR 6-HR. PEAK CONTROL.

<u>DENSITY</u>

ZONING R5 NO. UNITS ALLOWED BY ZONING: $6.19 \times 5 = 30$ NO. UNITS PROPOSED: 16

CAROLINA LAND SOLUTIONS, PLLC	DATE: OCTOBER 2017	REVISIONS	DATE	BY	
LICENSE NO. P-0904	SCALE : $1" = 50'$	1ST CITY COMMENTS	12-15-17	GDA	PREPARED FOR:
PO BOX 49116	SCALE \cdot = 50	2ND CITY COMMENTS	1-30-18	GDA	
CHARLOTTE, NC 28277	CHECKED BY: JWH	APPROVED PLAN REV1	5-14-18	GDA	BUCKHEAD CAPITAL
704.724.2235	DRAFTED BY: GDA	-			

