

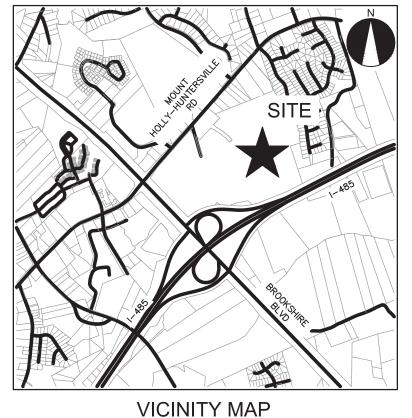
PRELIMINARY PLANNED **MULTI-FAMILY SUBDIVISION APPROVAL** 

CHARLOTTE-MECKLENBURG PLANNING DEPARTMENT

By Brent Wilkinson 2/8/18

CHARLOTTE, NORTH CAROLINA

BROWN INVESTMENT PROPERTIES P.O. BOX 930 GREENSBORO, NC 27402 P: 336-541-5504





TRANSPORTATION PLANNING

CONSTRUCTION

DOCUMENTS

www.drgrp.com

# SCALE: NTS

# SITE CONSTRUCTION DOCUMENTS

- 1. SURVEY INFORMATION OBTAINED BY THE ISAACS GROUP.
- 2. ARCHITECTURAL DIMENSIONS TO BE VERIFIED BY SURVEYOR, REFER TO ARCHITECTURAL PLANS FOR EXACT BUILDING
- 3. SURVEYOR SHALL REPORT ANY ENCROACHMENTS OR DISCREPANCIES GENERATED BY THE SITE PLAN AGAINST ANY SITE DEVELOPMENT REQUIREMENTS SPECIFIED BY THE SITE PLAN TO THE OWNER, LANDSCAPE ARCHITECT OR CIVIL ENGINEER PRIOR TO ANY ACTUAL CONSTRUCTION.
- 4. COORDINATE ALL CURB AND STREET GRADES IN INTERSECTION WITH INSPECTOR. 5. ALL ROAD IMPROVEMENTS ARE TO BE COORDINATED WITH THE CITY OF CHARLOTTE ENGINEERING DEPARTMENT PRIOR
- 6. DEVELOPER WILL PROVIDE STREET SIGNS PER CMLDS# 50.05 (9" SIGNS ONLY)
- 7. SIGHT TRIANGLES SHOWN ARE THE MINIMUM REQUIRED.
- 8. IN ROLLING AND HILLY TERRAINS, SWEEPING OF THE STONE BASE AND/OR APPLICATION OF A TACK COAT MAY BE
- 9. APPROVAL OF THIS PLAN IS NOT AN AUTHORIZATION TO GRADE ADJACENT PROPERTIES. WHEN FIELD CONDITIONS WARRANT OFF-SITE GRADING, PERMISSION MUST BE OBTAINED FROM THE AFFECTED PROPERTY OWNERS.
- 10. IN ORDER TO ENSURE PROPER DRAINAGE, KEEP A MINIMUM OF 0.5% SLOPE ON THE CURB.
- 11. SUBSURFACE DRAINAGE FACILITIES MAY BE REQUIRED IN THE STREET RIGHT-OF-WAY IF DEEMED NECESSARY BY THE 12. CURB AND GUTTER SHOWN ON PLANS ALONG PROPOSED PUBLIC ROADS MAY BE ADJUSTED BASED UPON FIELD
- 13. THE PURPOSE OF THE STORM DRAINAGE EASEMENT (SDE) IS TO PROVIDE STORM WATER CONVEYANCE AND ANY STRUCTURES AND/OR OBSTRUCTION TO STORM WATER FLOW IS PROHIBITED.
- 14. HIGH-DENSITY POLYETHYLENE (HDPE) STORM DRAINAGE PIPE INSTALLED WITHIN EXISTING OR PROPOSED PUBLIC STREET RIGHT-OF-WAY MUST BE APPROVED BY THE CITY'S INSPECTOR PRIOR TO ANY BACKFILL BEING PLACED. BACKFILL MATERIAL MUST BE APPROVED BY THE CITY INSPECTOR PRIOR TO PLACEMENT OF THE MATERIAL WITHIN THE PUBLIC STREET RIGHT-OF-WAY.
- 15. THE DEVELOPER SHALL MAINTAIN EACH STREAM, CREEK, OR BACKWASH CHANNEL IN AN UNOBSTRUCTED STATE AND SHALL REMOVE FROM THE CHANNEL AND BANKS OF THE STREAM ALL DEBRIS, LOGS, TIMBER, JUNK AND OTHER ACCUMULATIONS
- 16. ANY BUILDING WITHIN THE 100+1 BUILDING RESTRICTION FLOODLINE IS SUBJECT TO THE RESTRICTIONS OF THE (CITY OF CHARLOTTE/MECKLENBURG COUNTY) SUBDIVISION ORDINANCE, SECTION 7.200.8.
- 17. ANY CONSTRUCTION OR USE WITHIN THE FUTURE CONDITIONS FLOOD FRINGE LINE IS SUBJECT TO THE RESTRICTIONS
- IMPOSED BY THE FLOODWAY REGULATIONS OF THE CITY OF CHARLOTTE AND MECKLENBURG COUNTY 18. ALL OPENINGS (E.G., DOORS, WINDOWS, VENTS) IN STRUCTURES BUILT ON LOT 033-041-10 SHOULD BE LOCATED A MINIMUM OF ONE FOOT ABOVE THE ADJACENT FINISHED GROUND SURFACE (APPLIES TO LOTS WHICH MAY EXPERIENCE
- SIGNIFICANT OVERLAND FLOW NOT CONSIDERED IN THE 100+1 FLOOD ANALYSIS.)
- 19. PE SEALED SHOP DRAWINGS FOR RETAINING WALL MUST BE SUBMITTED TO CITY ENGINEER PRIOR TO CONSTRUCTION. 20. "AS-BUILT" DRAWINGS AND PLANS OF THE STORM DRAINAGE SYSTEM, INCLUDING DESIGNED DITCHES, MUST BE SUBMITTED PRIOR TO SUBDIVISION FINAL INSPECTION TO THE CITY/COUNTY ENGINEERING DEPARTMENT IN ACCORDANCE
- WITH THE CITY/COUNTY SUBDIVISION ORDINANCE.
- 21. PRIOR TO INSTALLATION, PE SEALED SHOP DRAWINGS FOR UNDERGROUND DETENTION SYSTEMS MUST BE FURNISHED TO CITY OF CHARLOTTE ENGINEERING FOR APPROVAL. 22. PRIOR TO CO, SURVEYOR SEALED AS-BUILT DRAWINGS OF ALL WATER QUALITY BMP'S AND DETENTION SYSTEMS MUST
- 23. PRIOR TO PLAT RECORDATION, OFFSITE R/W AND/OR CONSTRUCTION EASEMENTS ARE REQUIRED TO BE OBTAINED
- ACCORDING TO THE GUIDELINES OF THE "OFFSITE R/W ACQUISITION PROCESS". THESE NEEDED R/W AND CONSTRUCTION LIMITS ARE CLEARLY SHOWN ON THE ROADWAY IMPROVEMENT PLAN. 24. PER SECTION 18-175(E) OF CITY CODE AND SECTION 10.0 OF THE CITY'S POST CONSTRUCTION CONTROLS
- ADMINISTRATIVE MANUAL, ALL REQUIRED NATURAL AREAS AND/OR POST CONSTRUCTION CONTROLS EASEMENTS (PCCEs) MUST BE RECORDED PRIOR TO ISSUANCE OF THE CERTIFICATE OF OCCUPANCY 25. THE DEVELOPER SHALL CONTACT THE CHARLOTTE DEPARTMENT OF TRANSPORTATION (GUS JORDI, 704-336-7086) TO
- IDENTIFY ANY CONFLICTS WITH TRAFFIC SIGNALIZATION EQUIPMENT. 60- 90 DAYS WILL BE REQUIRED TO COORDINATE RELOCATION. DEVELOPER SHALL BE RESPONSIBLE FOR ALL RELATED RELOCATION COST AND/OR ANY REPAIR COST CAUSED BY THE CONTRACTOR/DEVELOPER.
- 26. CERTIFICATION AND STREET CUT PERMITS ARE REQUIRED FOR UTILITY CUTS ON CITY STREETS. ALLOW 7 DAYS PROCESSING FOR PERMIT. FOR INFORMATION CONTACT CHARLOTTE DEPARTMENT OF TRANSPORTATION (704-336-4025) OR VISIT
- HTTP: //WWW.CHARMECK.ORG/DEPARTMENTS/TRANSPORTATION/STREET+MAINTENANCE/HOME.HTM 27. NONSTANDARD ITEMS (IE: PAVERS, IRRIGATION SYSTEMS, ETC.) IN THE RIGHT-OF-WAY REQUIRE A RIGHT-OF-WAY
- ENCROACHMENT AGREEMENT WITH THE CHARLOTTE DEPARTMENT OF TRANSPORTATION/NORTH CAROLINA DEPARTMENT OF TRANSPORTATION BEFORE INSTALLATION. FOR CITY OF CHARLOTTE MAINTAINED STREETS, CONTACT CDOT AT (704) - 336 - 3888.
- 28. SIDEWALK WITHIN THE CITY'S R/W THAT REQUIRES REPLACEMENT AS PART OF THE DEVELOPMENT AND/OR STREET IMPROVEMENTS SHOULD BE PHASED IN SUCH A WAY AS TO MINIMIZE THE DURATION OF THE SIDEWALK CLOSURE TO THE EXTENT FEASIBLE. THE DEVELOPER SHOULD MAKE EVERY ATTEMPT TO HAVE SIDEWALK REPAIRED AND REOPENED FOR PUBLIC USE WITHIN 30 DAYS OF REMOVAL. 29. ANY WORK WITHIN THE CITY'S R/W THAT REQUIRES CLOSURE OF THE SIDEWALK OR TRAVEL LANE FOR LESS THAN 30
- DAYS REQUIRES A R/W USE PERMIT. TRAFFIC CONTROL PLANS FOR SIDEWALK OR TRAVEL LANE CLOSURES MUST BE SUBMITTED AS PART OF THE R/W USE PERMIT REQUEST. TRAFFIC CONTROL PLANS MUST BE IN ACCORDANCE WITH CDOT'S WORK AREA TRAFFIC CONTROL HANDBOOK (WATCH) AND MUST BE REVIEWED AND APPROVED. CONTRACTOR SHALL CONTACT CDOT AT LAST 5 BUSINESS DAYS IN ADVANCE OF BEGINNING OF WORK AT (704)-432-1562.
- 30. RIGHT-OF-WAY CLOSURES LONGER THAN 30 DAYS REQUIRE A R/W LEASE AGREEMENT WHICH WILL INCLUDE THE SUBMITTAL OF A TRAFFIC CONTROL PLAN. TRAFFIC CONTROL PLANS REQUIRED THROUGH A LEASE AGREEMENT MAY BE DIFFERENT FROM THE ONE REQUIRED DURING THE LAND DEVELOPMENT PLAN REVIEW AND ARE SUBJECT TO REVISIONS. THE REVISED TRAFFIC CONTROL PLANS MUST BE SUBMITTED AS PART OF THE LEASE AGREEMENT PROCESS FOR APPROVAL PRIOR TO START OF R/W CLOSURES. CONTRACTOR SHALL CONTACT CDOT AT (704)-336-8348.
- 31. CONSTRUCTION STAGING WITHIN CITY R/W LASTING MORE THAN 30 DAYS REQUIRES A R/W LEASING AGREEMENT. CONTRACTOR SHALL CONTACT CDOT AT (704)-336-8348. 32. DEVELOPER TO CONTACT CDOT (STEPHEN BOLT, (704)-432-5561) DURING SITE PLAN PREPARATION TO DISCUSS
- STREET LIGHTING REQUIREMENTS, IF ANY, FOR THIS PROJECT. COORDINATE WITH DUKE ENERGY AND CDOT AS NECESSARY TO DETERMINE LIGHTING LEVELS, LIGHTING LAYOUT, AND REQUIREMENTS FOR INSTALLATION.
- 33. PIPE SYSTEMS AND/OR CHANNELS LOCATED WITHIN PUBLIC DRAINAGE EASEMENTS ARE THE MAINTENANCE RESPONSIBILITY OF THE INDIVIDUAL PROPERTY OWNER.
- 34. ALL CONSTRUCTION TO CONFORM TO CHARLOTTE / MECKLENBURG LAND DEVELOPMENT STANDARDS. 35. FIRE HYDRANT LOCATIONS SHALL BE REVIEWED AND APPROVED BY THE COUNTY FIRE MARSHALL DURING THE BUILDING PERMIT PROCESS.

## **ENGINEER'S NOTES:**

- CONTRACTOR SHALL NOTIFY THE ENGINEER OF WORK 48 HOURS PRIOR TO COMMENCEMENT OF CONSTRUCTION
- CONTRACTOR SHALL BE RESPONSIBLE FOR OBTAINING INTERPRETATIONS FOR ANY QUESTIONS REGARDING THESE DRAWINGS PRIOR TO COMMENCEMENT OF WORK OR ORDERING OF MATERIALS AND SHALL BEAR THE COST OF ALL
- 3. CONTRACTOR SHALL PROVIDE ENGINEER RECORD DRAWING INFORMATION FROM A REGISTERED LAND SURVEYOR UPOI
- 4. CONTRACTOR SHALL OBTAIN A PERMIT FOR ANY EXCAVATION PERFORMED WITHIN THE PUBLIC RIGHT-OF-WAY 5. THE ENGINEER OF WORK SHALL NOT BE RESPONSIBLE FOR THE ENFORCEMENT OF SAFETY MEASURES OR REGULATIONS. THE CONTRACTOR SHALL DESIGN, CONSTRUCT, AND MAINTAIN ALL SAFETY DEVICES AND SHALL BE SOLELY RESPONSIBLE FOR CONFORMING TO ALL LOCAL, STATE, AND FEDERAL SAFETY STANDARDS, LAWS AND
- 6. CONTRACTOR SHALL ADJUST ALL PROPOSED AND EXISTING FACILITIES TO FINAL GRADE.
- CONTRACTOR SHALL NOTIFY THE ENGINEER OF ANY DISCREPANCIES BETWEEN THE FIELD DATA AND THE INFORMATION SHOWN HEREON. ENGINEER SHALL NOT BE RESPONSIBLE FOR ANY WORK DONE WITHOUT PROPER NOTIFICATION AND COORDINATION.
- 8. THE ENGINEER PREPARING THESE PLANS SHALL NOT BE RESPONSIBLE FOR, OR LIABLE FOR, UNAUTHORIZED CHANGES TO OR USES OF THESE PLANS. ALL CHANGES MUST BE IN WRITING AND MUST BE APPROVED BY THE DESIGN ENGINEER PRIOR TO IMPLEMENTATION.
- 9. PRIVATE WATER AND SANITARY SEWER SYSTEMS SHALL BE TESTED IN ACCORDANCE WITH N.C.D.E.N.R. REGULATIONS IN THE PRESENCE OF THE ENGINEER PRIOR TO ACTIVATION OF FACILITIES.
- EXISTING PUBLIC UTILITY INFORMATION IS SHOWN FOR REFERENCE ONLY AND EXISTING SIZES, INVERTS AND LOCATIONS SHALL BE FIELD VERIFIED.
- 11. IT SHALL BE THE RESPONSIBILITY OF THE CONTRACTOR TO LOCATE ALL SUBSTRUCTURES, WHETHER SHOWN HEREON OR NOT, AND PROTECT FROM DAMAGE DURING INSTALLATION. THE EXPENSE OF REPAIR OR REPLACEMENT OF SAID STRUCTURES SHALL BE BORNE BY THE CONTRACTOR.
- 12. A LICENSED UTILITY CONTRACTOR WILL INSTALL THE TAPS AND METERS. THE CONTRACTOR IS RESPONSIBLE FOR INSTALLING THE TAPS AND METERS TO CMUD STANDARDS AND REGULATIONS. 13. SANITARY YARD HYDRANTS SHALL NOT BE 'STOP AND DRAIN', 'STOP AND WASTE', OR 'WEEP HOLE' TYPE
- 14. IF CONTRACTOR OPTS TO INSTALL PRECAST STRUCTURES, CONTRACTOR SHALL BE REQUIRED TO VERIFY RIM ELEVATIONS AND LAYOUT OF ALL PIPES, INCLUDING SIZE AND INVERTS OF EXISTING FACILITIES, PRIOR TO THE
- 15. IT SHALL BE THE RESPONSIBILITY OF THE INSTALLER TO ADJUST ALL PRECAST STRUCTURES TO FINISHED GRADE IN ACCORDANCE WITH AGENCY SPECIFICATIONS AND MANUFACTURER RECOMMENDATIONS. NO ADDITIONAL PAYMENT WILL BE MADE FOR ADJUSTING FACILITIES TO FINISHED GRADE.
- 16. FIRE HYDRANTS ARE TO BE 10' CLEAR OF ANY OBSTRUCTIONS.
- 17. FDC LOCATIONS SHALL BE IN ACCORDANCE W/ CFD REQUIREMENTS.
- 18. FIRE SPRINKLER SIZING AND FDC CONNECTIONS TO BE SIZED AND LOCATED PER THE RECOMMENDATIONS OF THE FIRE SPRINKLER CONSULTANT. ALL REFERENCES SHOWN HEREON ARE FOR SCHEMATIC PURPOSES ONLY.
- 20. CONTRACTOR SHALL FLUSH ALL ONSITE STORM DRAINAGE AND HAUL OFF ALL ACCUMULATED MATERIAL AT COMPLETION OF CONSTRUCTION. CONTRACTOR SHALL PROTECT DOWN STREAM PROPERTIES AND BMP INSTALLATIONS FROM EXCESSIVE SEDIMENT ACCUMULATION. UPON COMPLETION OF CLEANING, CONTRACTOR SHALL PROVIDE WRITTEN CONFIRMATION TO OWNER AND REQUEST INSPECTION OF PROJECT BY ENGINEER FOR FINAL INSPECTION.

NO COMBUSTILBE MATERIALS ARE ALLOWED ON SITE UNTIL THE WATER SUPPLY AND THE ACCESS ROADS ARE IN SERVICE ARE INSPECTED BY THE FIRE INSPECTOR.



FINAL APPROVAL

PROJECT NUMBER:

## **ENGINEERING** PCSO / DETENTION / DRAINAGE PLAN **EROSION CONTROL**

**URBAN FORESTRY** 

**CDOT** 

NOTE: SCHEDULE PRE-CONSTRUCTION MEETING AT LEAST 48 HRS. PRIOR TO ANY LAND DISTURBING ACTIVITY USING THE ONLINE FORM FOUND AT http://charlottenc.gov/ld

**APPROVED** By mark chapman at 10:56 am, Feb 08, 2018

UNITS ALLOWED IN AREA E: PROPOSED UNITS: 266 UNITS UNITS REMAINING IN AREA E 234 UNITS 22.87 DUA TOTAL GROSS FLOOR AREA: 329,745 SF

MAXIMUM F.A.R.: 2.0 PER ORDINANCE PROPOSED F.A.R.: BUILDING HEIGHT:

FOUR STORY MAXIMUM (PER APPROVED BLDG. TYPE IA = 47'-2'' ABOVE AVG. GRADE BLDG. TYPE IB = 53'-1" ABOVE AVG. GRADE BLDG. TYPE IC = 48'-2" ABOVE AVG. GRADE BLDG. TYPE IIA = 50'-10" ABOVE AVG. GRADE BLDG TYPE IIB = 51'-10" ABOVE AVG. GRADE BLDG. TYPE III = 50'-1" ABOVE AVG. GRADE

033-041-10

NS (SPA) (LWPA)

MULTI-FAMILY APARTMENTS

PROVIDED OFFSITE FOR OVERALL DEVELOPMENT

BLDG. TYPE IV = 49'-9" ABOVE AVG. GRADE

±15.09 ACRES

2016-128

SITE SHEET SCHEDULE

RZ3.0 DEVELOPMENT NOTES

SITE PLAN

TECHNICAL DATA SHEET

SCHEMATIC SITE DESIGN

DEVELOPMENT NOTES

ACCESSIBLE ROUTE PLAN

BUILDING FRONTAGE PLAN

EROSION CONTROL OVERALL

EROSION CONTROL PHASE I

C3.04 | EROSION CONTROL NOTES

C4.00 OVERALL GRADING PLAN

GRADING PLAN

C4.10 | STORM DRAINAGE PLAN

C4.12 | SECONDARY DRAINAGE

C4.13 | STORM DRAINAGE TABLES

C5.00 OVERALL UTILITY PLAN

C5.02 PRIVATE SEWER PLAN

C5.03 | PRIVATE SEWER PLAN

C6.00 REQUIRED PLANTING PLAN

OVERLOOK MOUNTAIN DRIVE PLAN AND PROFILE

C7.01 | SUGAR MAGNOLIA DRIVE PLAN AND PROFILE

C7.02 SUGAR MAGNOLIA DRIVE PLAN AND PROFILE

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C5.04 | FIRE PLAN

C7.10 | ISD PROFILE

C7.11 | ISD PROFILE

C7.12 | ISD PROFILE

C7.13 | ISD PROFILE

C7.14 | ISD PROFILE

C7.15 | ISD PROFILE

C7.16 | ISD PROFILE

C7.17 | ISD PROFILE

|C8.00 |SITE DETAILS

C8.01 | SITE DETAILS

C8.02 | SITE DETAILS

C8.03 | SITE DETAILS

C8.04 | SITE DETAILS

C8.05 | SITE DETAILS

C9.00 | CIVIL DETAILS

C9.01 | CIVIL DETAILS

C9.02 | CIVIL DETAILS

C9.03 | CIVIL DETAILS

C4.14 SECONDARY DRAINAGE TABLES

C4.15 | SECONDARY DRAINAGE TABLES

PRIVATE SEWER PLAN

STORM DRAINAGE AREA MAP

C4.02 | GRADING PLAN

C4.03 GRADING PLAN

C4.04 | GRADING PLAN

C4.05 GRADING PLAN

C4.01

EROSION CONTROL PHASE I

EROSION CONTROL PHASE III

VEHICULAR MANEUVERING PLAN

URBAN OPEN SPACE & PEDESTRIAN EASEMENTS

CORNING SITE PLAN (CONCEPTUAL SITE PLAN)

DEVELOPMENT WATERSHED CALCULATIONS

SMALL SHOPS BUILDING ELEVATION

CO.00 | COVER SHEET

BUILDING SEPARATION: 16' MINIMUM

PARKING SPACE(S) REQUIRED: MINIMUM:

BICYCLE PARKING REQUIRED:

BICYCLE PARKING PROVIDED:

RECYCLING AREA PROVIDED:

MAXIMUM:

TAX PARCEL ID NO .:

REZONING PETITION:

OVERALL SITE AREA:

PROPOSED USE:

SITE AREA (EXCLUDING NEW R/W):

REQUIRED TREE SAVE AREA:

1.0 SPACE(S) PER UNIT (266 SPACES)

PARKING SPACE(S) PROVIDED: 357 STANDARD SPACES 14 ACCESSIBLE SPACES 4 ACCESSIBLE VAN SPACES

> 31 GARAGE SPACES 2 ACCESSIBLE GARAGE SPACE 60 ON STREET SPACES 4 ACCESSIBLE ON STREET SPACES 472 SPACES TOTAL 1 SPACE PER 20 UNITS (13)

> > 13 SPACES AROUND SITE

SETBACK:

16' FROM PROPOSED BACK OF CURB

REAR YARD: N/A

OVERALL IMPERVIOUS AREA: 431,215.5 SF (9.89 ACRES) IMPERVIOUS AREA (MINUS NEW R/W): 327,038.9 SF (7.51 ACRES)

TRASH PICK UP REQUIRED: 8 CU.YD. COMPACTOR/EACH 90 UNITS TRASH PICK UP PROVIDED: (1) 30 CY COMPACTOR 4 X 144 SF (576 SF TOTAL) RECYCLE AREA REQUIRED:

ALL UTILITIES TO BE UNDERGROUND ESTIMATED TIME OF COMPLETION:

DEVELOPER:

ARCHITECT:

BROWN INVESTMENT PROPERTIES P.O. BOX 930 GREENSBORO, NC 27402 336.541.5504

NARMOUR WRIGHT ARCHITECTURE 1815 S. TRYON STREET SUITE A

CHARLOTTE, NC 28203

704.332.5668

LANDSCAPE ARCH .:

DESIGN RESOURCE GROUP, PA 2459 WILKINSON BOULEVARD SUITE 200 CHARLOTTE, NC 28208 704.343.0608

CIVIL ENGINEER: DESIGN RESOURCE GROUP, PA 2459 WILKINSON BOULEVARD SUITE 200 CHARLOTTE, NC 28208 704.343.0608

> THE ISAACS GROUP 8720 RED OAK BOULEVARD CHARLOTTE, NC 28217 704.527.3440

* No. 1237 \$ * * * * * * * * * * * * * * * * * *
THE STOCKET
11/15/17

ARCHITECTURALS SHEET SCHEDULE		
A0.0	TYPICAL BUILDING ENTRY PERSPECTIVE	
A1.0	BUILDING TYPE I-A PLAN AND PERSPECTIVE	
A1.1	BUILDING TYPE I—A ELEVATIONS	
A1.2	BUILDING TYPE I-B ELEVATIONS	
A1.3	BUILDING TYPE I-C ELEVATIONS	
A2.0	BUILDING TYPE II-A FLOOR PLAN AND PERSPECTIVE	
A2.1	BUILDING TYPE II-A ELEVATIONS	
A2.2	BUILDING TYPE II-B ELEVATIONS	
A3.0	BUILDING TYPE III PLAN AND PERSPECTIVE	
A3.1	BUILDING TYPE III ELEVATIONS	
A4.0	BUILDING TYPE IV PLAN AND PERSPECTIVE	
A4.1	BUILDING TYPE IV ELEVATIONS	
A5.0	CLUBHOUSE BASEMENT FLOOR PLAN	
A5.1	CLUBHOUSE FIRST FLOOR PLAN	
A5.2	CLUBHOUSE ELEVATIONS	
A5.3	CLUBHOUSE ELEVATIONS	

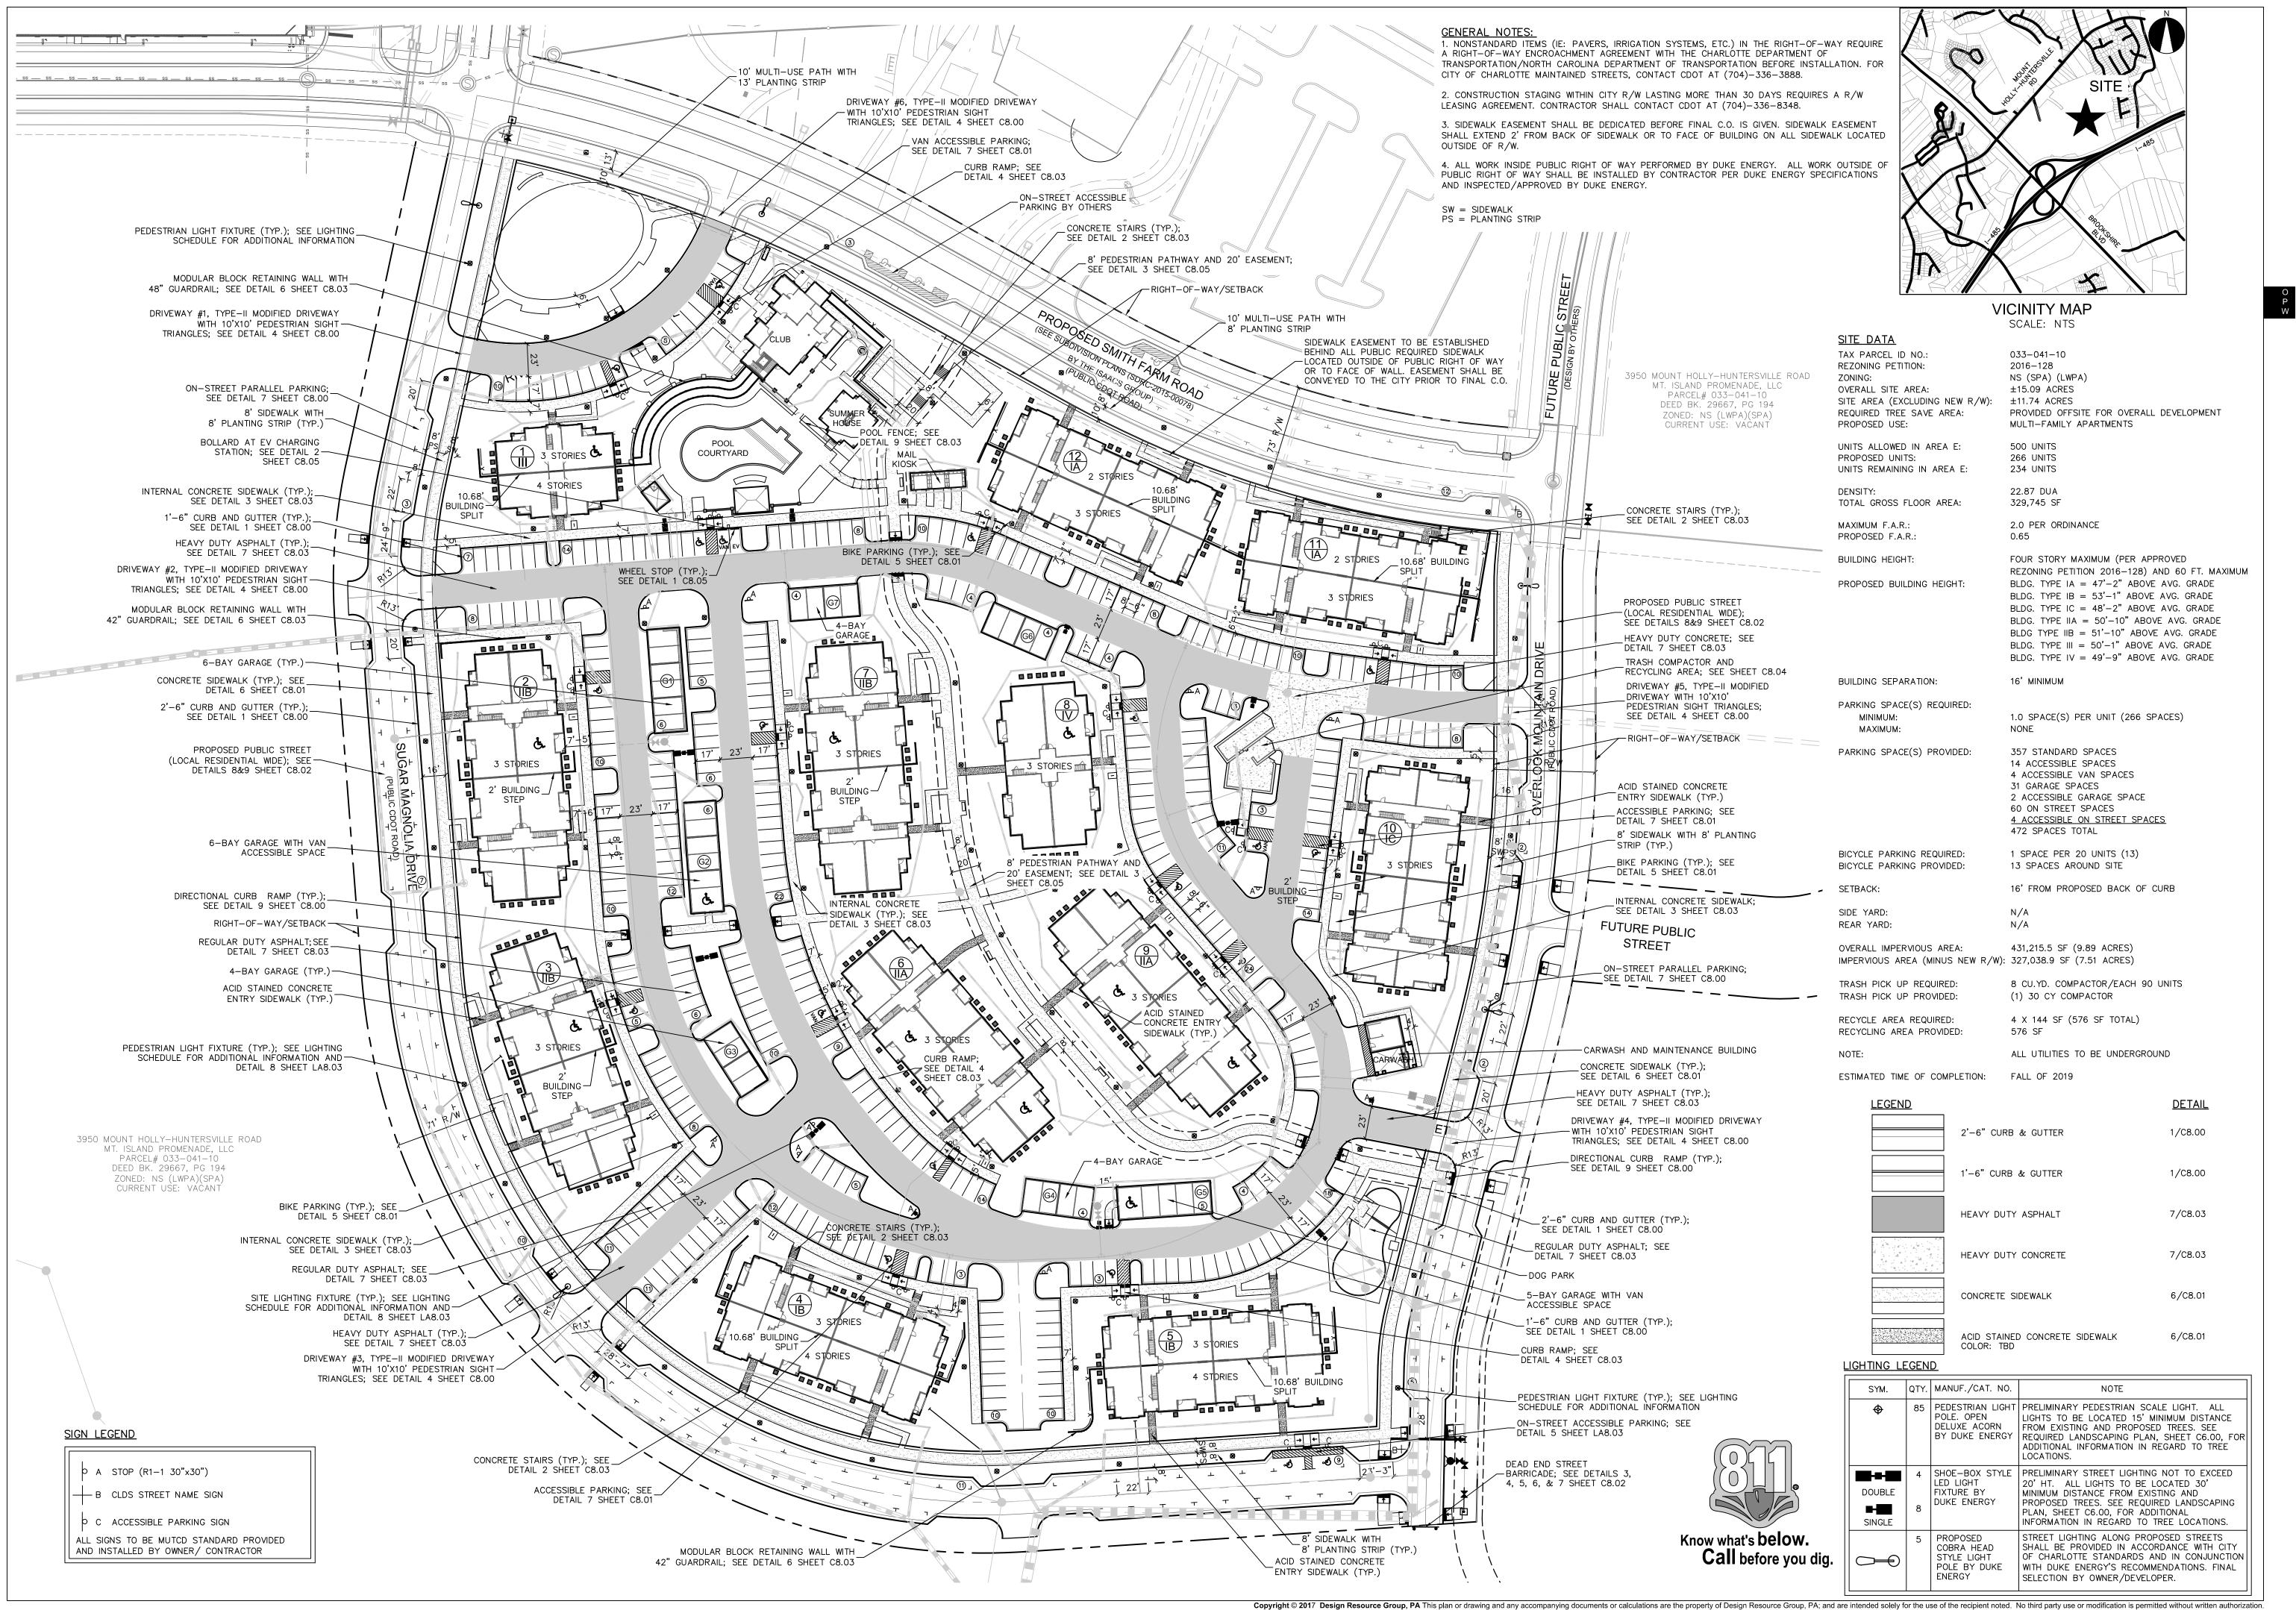
## **COVER SHEET**

628-001 PROJECT #:

DRAWN BY CHECKED BY **NOVEMBER 15, 2017** 

**REVISIONS:** 

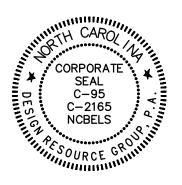
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LANDSCAPE ARCHITECTURE CIVIL ENGINEERING TRANSPORTATION PLANNING

2459 Wilkinson Blvd, Ste 200 Charlotte, NC 28208 704.343.0608 www.drgrp.com





CONSTRUCTION

DOCUMENTS

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SITE PLAN

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PROJECT #: 628-001
DRAWN BY: BMS
CHECKED BY: BS

NOVEMBER 15, 2017

REVISIONS:

C2.00