

FINAL APPROVAL

EXISTING SANITARY SEWER

SANITARY MANHOLE NUMBER

EX SANITARY MANHOLE

SANITARY MANHOLE

EXISTING CLEAN OUT

EXISTING WATER LINE

EXISTING WATER VALVE

EXISTING FIRE HYDRANT

WATER VALVE

FIRE HYDRANT

WATER LINE PLUG

EXISTING GAS LINE

EXISTING UTILITY POLE

EXISTING OVERHEAD ELECTRIC

EXISTING TELEPHONE PEDESTAL

EX OVERHEAD TELEPHONE LINE

EX OVERHEAD FIBER OPTIC LINE

EX UNDERGROUND FIBER OPTIC LINE

OVERHEAD FIBER OPTIC LINE

— UNDERGROUND FIBER OPTIC LINE

WATER LINE TEE

CLEAN OUT

ENGINEERING

EROSION CONTROL

URBAN FORESTRY

CDOT

LEGEND

WATER

NATURAL GAS

MISCELLANEOUS UTILITIES

NOTE: SCHEDULE PRE-CONSTRUCTION MEETING AT LEAST 48 HRS. PRIOR TO ANY LAND FORM FOUND AT http://charlottenc.gov/ld

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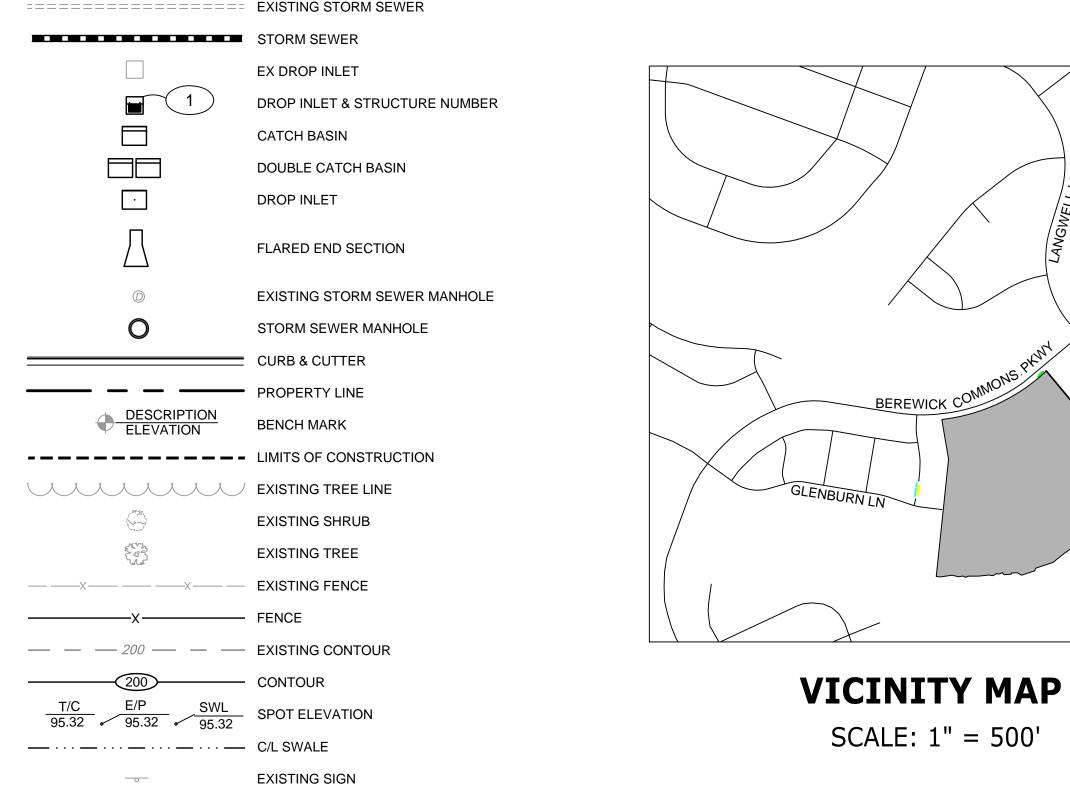
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APPROVED

STONEHAVEN - PHASE II

CITY OF CHARLOTTE (ETJ), NORTH CAROLINA



PROPERTY MARKER FOUND / ROD FOUND

PIPE FOUND

MONUMENT FOUND

MATTAMY HOMES

2127 AYRSLEY TOWN BOULEVARD, SUITE 201 CHARLOTTE, NORTH CAROLINA 28273

PRELIMINARY PLANNED **MULTI-FAMILY SUBDIVISION APPROVAL**

CHARLOTTE-MECKLENBURG PLANNING DEPARTMENT By Brent Wilkinson 11/13/17

nnexation for this property was approved 10/9/17

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L-2.0	REZONING - CONCEPT PLAN
L-3.0	REZONING - ZONING BOUNDARY EXHIBIT
L-4.0	REZONING - TREE SAVE EXHIBIT
C100	EXISTING CONDITIONS AND DEMOLITION PLAN OVERALL
C101	EXISTING CONDITIONS AND DEMOLITION PLAN
C102	EXISTING CONDITIONS AND DEMOLITION PLAN
C103	EXISTING CONDITIONS AND DEMOLITION PLAN
C104 C200	EXISTING CONDITIONS AND DEMOLITION PLAN
C200	SITE PLAN OVERALL SITE PLAN NOTES
C201	SITE PLAN
C202	SITE PLAN
C204	SITE PLAN
C205	SITE PLAN
C300	EROSION CONTROL PHASE I PLAN OVERALL
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C309	EROSION CONTROL PHASE II PLAN
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C412	STORM SEWER PROFILES
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C500	ROAD PLAN AND PROFILE
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C504	BEREWICK COMMONS PARKWAY SIGHT DISTANCE PLAN AND PROFILE
C505	GLENBURN LANE AT CLAN MACLAINE DRIVE SIGHT DISTANCE PLAN
C506	GLENBURN LANE AT LACHLAN HILL LANE SIGHT DISTANCE PLAN
C507	GLENBURN LANE AT GARROW GLEN ROAD SIGHT DISTANCE PLAN
C508	GARROW GLEN ROAD AT LACHLAN HILL LANE SIGHT DISTANCE PLAN
C509	CLAN MACLAINE DRIVE AT GARROW GLEN ROAD SIGHT DISTANCE PLAN
C600	BEREWICK COMMONS PARKWAY STRIPING PLAN
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C705	EROSION CONTROL AND GRADING PLAN DETAILS
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L101	LANDSCAPE PLAN
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L103	LANDSCAPE PLAN
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L200	LANDSCAPE NOTES AND DETAILS




- CONTRACTOR IS FULLY RESPONSIBLE FOR CONTACTING
 APPROPRIATE PARTIES AND ASSURING THAT EXISTING UTILITIES
 ARE LOCATED PRIOR TO CONSTRUCTION. 2. CONTRACTOR IS RESPONSIBLE FOR PLACING BARRICADES USING FLAG MEN, ETC. AS NECESSARY TO INSURE SAFETY TO THE PUBLIC.

05/05/2017 J. HORTON

DESIGNED BY J. HORTON CHECKED BY C. TODD SCALE AS SHOWN

38225 SHEET NO. COOO

REZONING PETITION: 2006-078

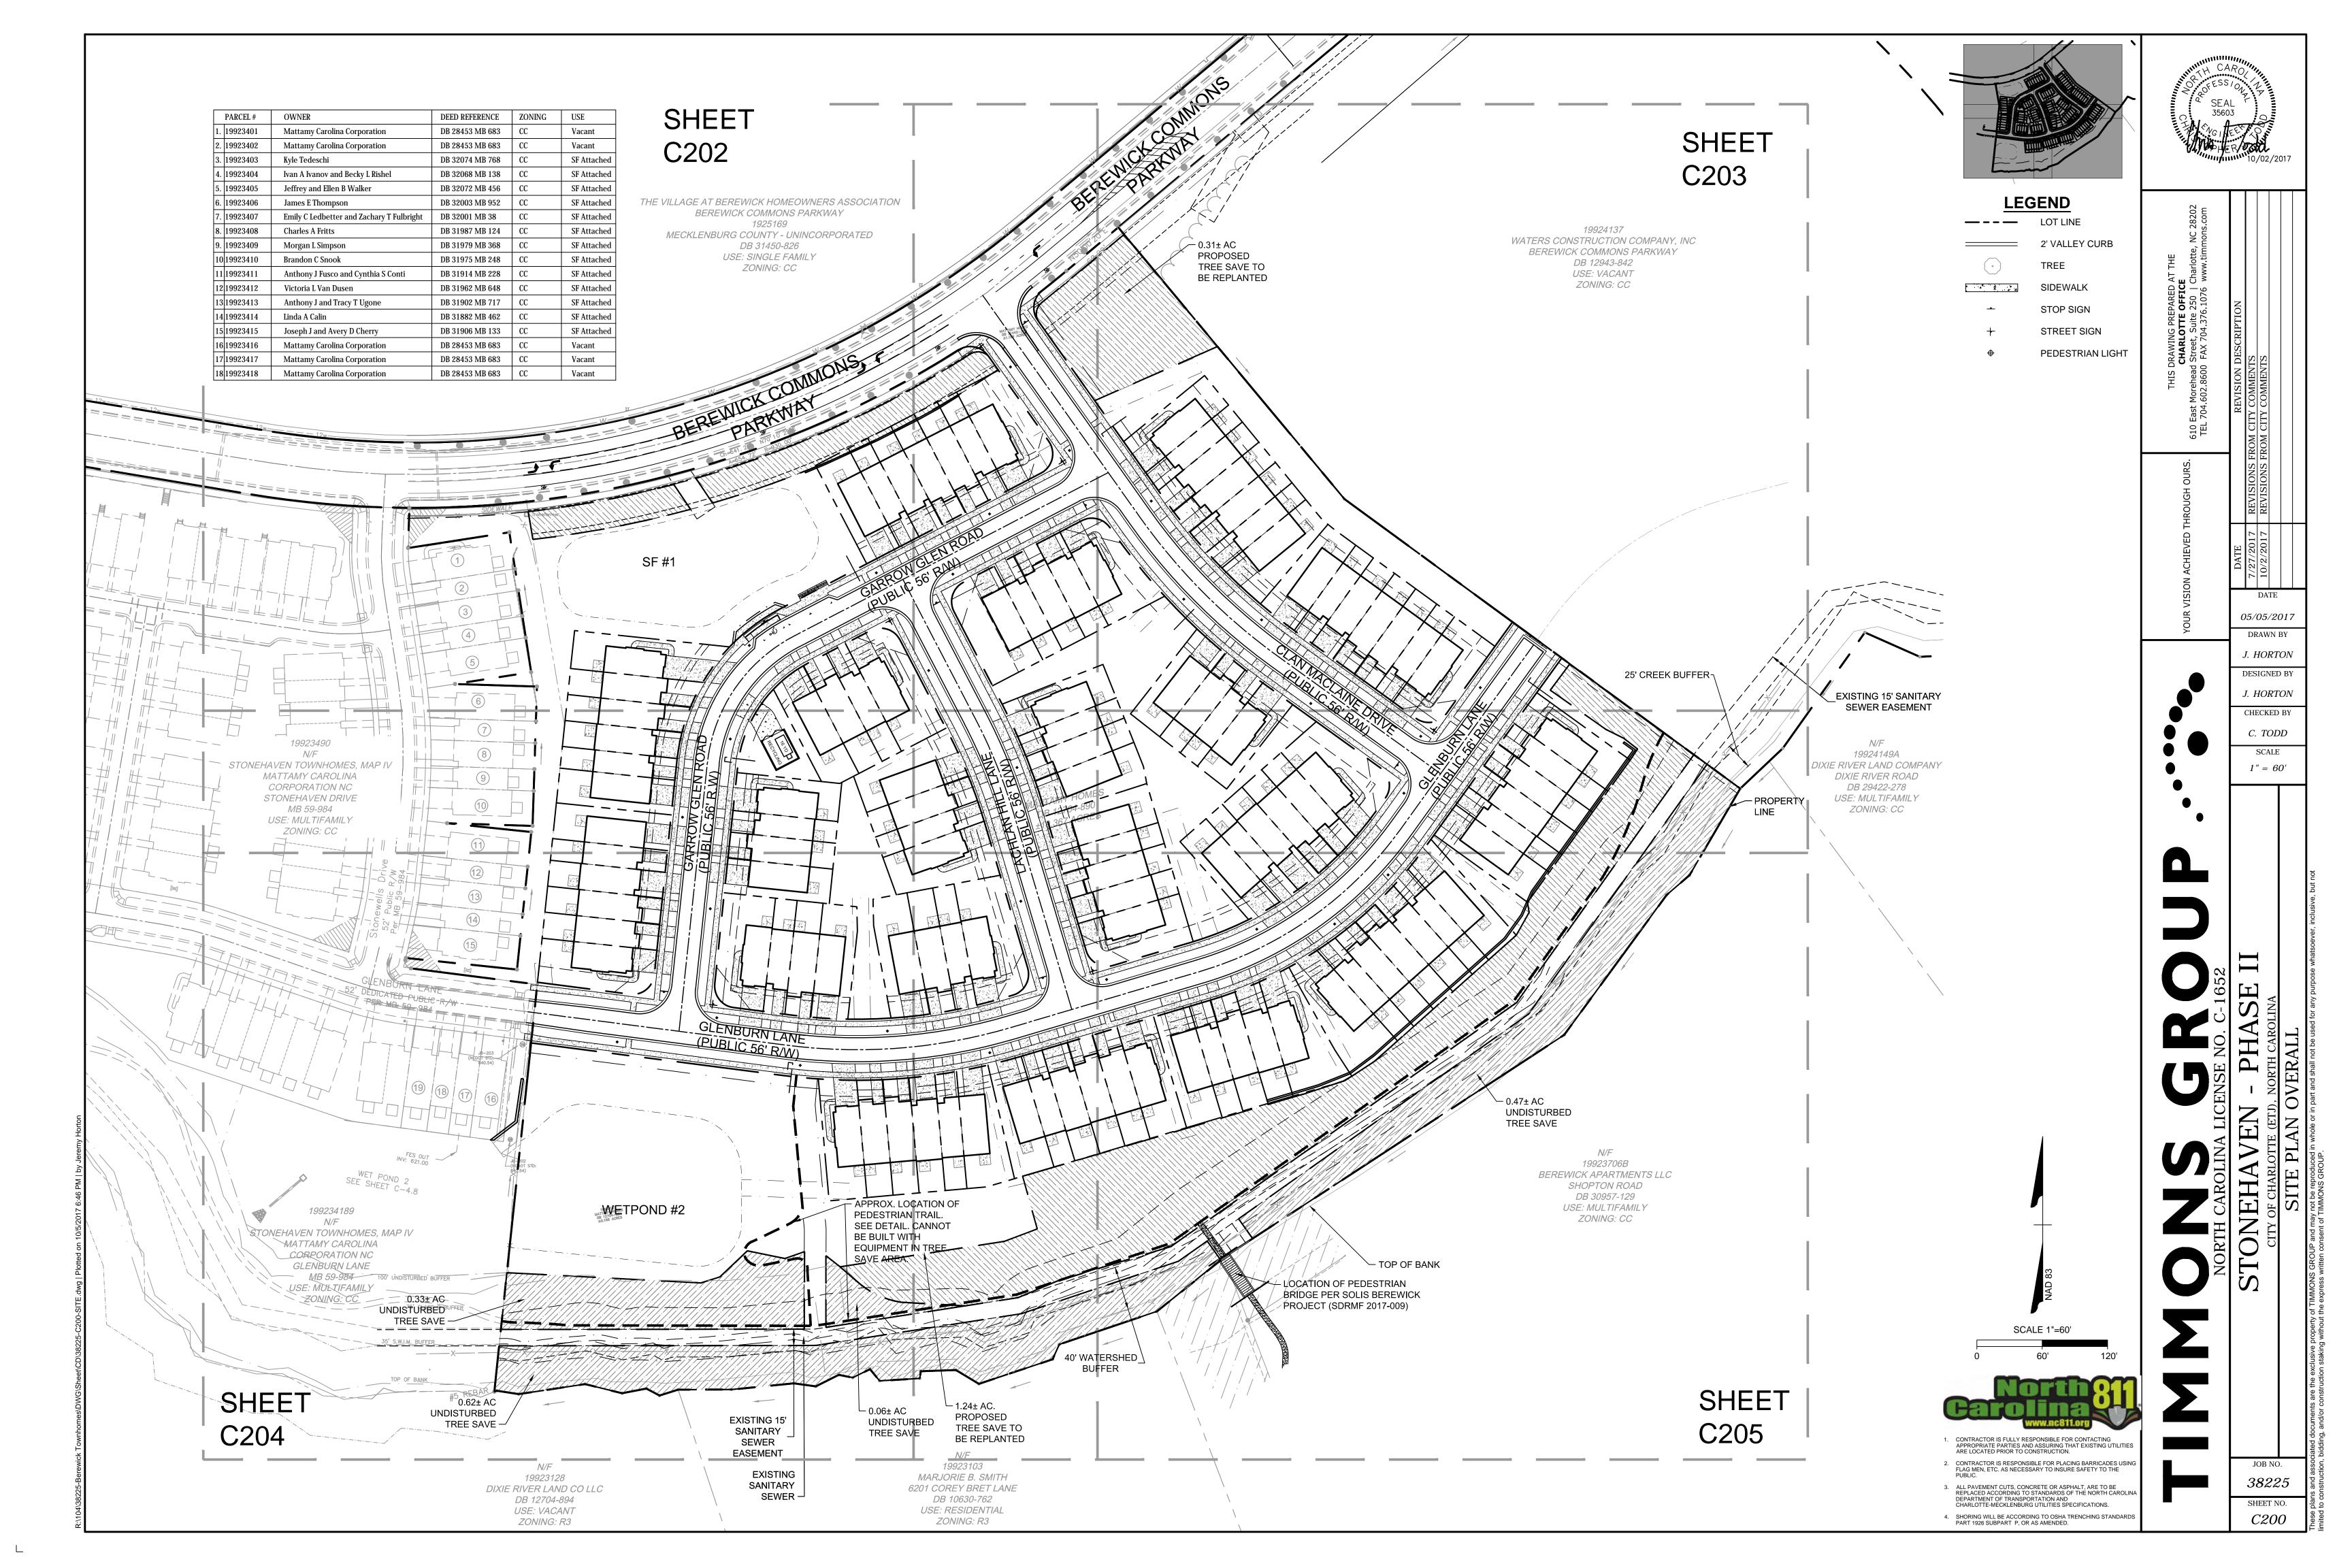

ZONING CODE SUMMARY

OWNER: MATTAMY HOMES 2127 AYRSLEY TOWN BOULEVARD, SUITE 201

PROJECT ACREAGE: 17.84 ACRES

TAX PARCEL #S: 19923126, 19923127, AND 19925167

ZONING: CC - LLWPA **REZONING:** 2006 - 078

EXISTING USE: VACANT

PROPOSED USE: SINGLE FAMILY ATTACHED (TOWNHOMES) FOR SALE

CHARLOTTE, NC 28273

UNITS ALLOWED: 107 UNITS PROVIDED: 107

UNITS REMAINING: 107 PER THE MASTER DEVELOPMENT SUMMARY

DATED AUGUST 21, 2017.

DENSITY PROVIDED: 6.0 UDA **BUILDING SEPARATION:** 16' (MINIMUM)

FRONT YARD SETBACK: 27' (MEASURED FROM TOTAL R/W) *

> * SETBACK MAY BE REDUCED TO 15' PER SECTION 9.303(19)(F) OF ZONING ORDINANCE PROVIDED THE BUILDING ELEVATION FACING THE STREET HAS A FRONT ARCHITECTURAL FACADE WITH AN ENTRY DOORWAY.

* ALL GARAGES HAVE A 20 FT SEPARATION FROM THE PROPOSED RIGHT-OF-WAY OR BACK OF

SIDEWALK (WHICHEVER IS GREATER).

REAR YARD SETBACK:

SIDE YARD SETBACK: 5' (OR 10' IF ADJOINING SINGLE FAMILY DEVELOPED

ZONED LAND)

BEREWICK COMMONS PARKWAY SETBACK:

WATERSHED NAME

SOLID WASTE:

BUILDING HEIGHT ALLOWED: 40' (MAX.)

BUILDING HEIGHT PROPOSED: 30' - 4" (MAX.)

35 FT

ALL SOLID WASTE TO BE PROVIDED BY PRIVATE SERVICE. ALL UNITS SHALL BE SERVICED BY INDIVIDUAL ROLL-OUT WASTE AND RECYCLING

LOWER LAKE WYLIE - PROTECTED AREA

CONTAINERS.

SOLID WASTE OPTION: SOLID WASTE REQUIRED ONE 8 CY DUMPSTER PER 30 UNITS OR ONE 8 CY

COMPACTOR PER 90 UNITS. SOLID WASTE PROVIDED: ONE 16 CY COMPACTOR

RECYCLING REQUIRED: 288 SF

RECYCLING PROVIDED: 295 SF

OPEN SPACE CALCULATIONS

TOTAL SITE AREA = 17.84 ACRES OPEN SPACE REQUIRED = 7.14 ACRES (40.0%) OPEN SPACE PROVIDED = 7.15 ACRES (40.1%)

PRIVATE OPEN SPACE = 400 SF PER UNIT (MINIMUM)

TREE SAVE CALCULATIONS

REQUIRED TREE SAVE: 15% (2.68 AC.) PROVIDED TREE SAVE: 15% (2.68 AC.)

WATERSHED CALCULATIONS

(HIGH DENSITY OPTION)

PERCENT IMPERVIOUS:

CRITICAL AREA: 543,972 SF / 12.49 ACRES PROTECTED AREA: 388,555 SF/ 8.92 ACRES (IMPERVIOUS)

PROPOSED IMPERVIOUS 321,366.69 SF/ 7.38 ACRES*

*INCLUDES:

BUILDING PAD, DRIVEWAYS, SIDEWALKS, AND STREETS.

1. BMP AS-BUILTS TO INCLUDE BUILT UPON AREA DRAINING TO THE BMP AND INCLUDED ON THE BMP ACCESS AND MAINTENANCE EASEMENT PLAT FOR RECORDATION.

7.38 ACRES/ 17.84 ACRES = 41.4%

PARKING CALCULATIONS

REQUIRED PARKING: 161 SPACES (1.5/ UNIT)

PROVIDED PARKING: 320 SPACES*

*2 CAR GARAGE UNIT: 4 SPACES (53 PROVIDED) 1 CAR GARAGE UNIT: 2 SPACES (54 PROVIDED)

STAKING AND MATERIALS PLAN NOTES

- 1. CURB AND GUTTER VARIES AT CATCH BASIN LOCATION. SEE DETAILS FOR CATCH BASIN PLACEMENT AND CURB TRANSITIONS.
- 2. ALL DIMENSIONS ARE AT 90 DEGREES UNLESS OTHERWISE NOTED.
- 3. DIRECT VEHICULAR ACCESS TO BEREWICK COMMONS PARKWAY FROM ALL LOTS IS PROHIBITED.
- 4. CURB AND GUTTER SHOWN ON PLANS ALONG BEREWICK COMMONS PARKWAY MAY BE ADJUSTED BASED UPON FIELD STAKING BY CITY ENGINEERING. ASSOCIATED STORM DRAINAGE MAY ALSO REQUIRE MODIFICATION BASED UPON FIELD CONDITIONS.
- 5. ALL STREETS ARE PUBLIC UNLESS OTHERWISE NOTED.
- 6. CONTRACTOR SHALL ESTABLISH AND VERIFY POINT OF BEGINNING (P.O.B.) AND STAKE SITE AS INDICATED ON CONSTRUCTION DOCUMENTS PRIOR TO COMMENCEMENT OF CONSTRUCTION. NOTIFY TIMMONS GROUP IMMEDIATELY OF ANY DISCREPANCIES.
- 7. ALL DIMENSIONS ARE TO FACE OF CURB OR CENTERLINE UNLESS OTHERWISE NOTED.
- 8. ALL DETAILS SHALL BE CONSTRUCTED IN STRICT COMPLIANCE WITH SPECIFICATIONS AND CONSTRUCTION DOCUMENTS.
- 9. ALL RADII SHALL BE 4' 6" (B.O.C.) UNLESS OTHERWISE NOTED
- 10. SIGHT TRIANGLES INDICATED ARE THE MINIMUM REQUIRED.
- 11. ALL SIDEWALKS SHALL BE 5' 0" UNLESS OTHERWISE NOTED
- 12. ALL CURB AND GUTTER SHALL BE 2' 0" VALLEY UNLESS OTHERWISE NOTED.
- 13. STREET FRONTAGE SIGNAGE (BUS STOP, STREET NAME, SPEED LIMIT, NEIGHBORHOOD) SHOWN AT APPROXIMATE LOCATIONS. CORDINATE EXACT LOCATIONS WITH CITY INSPECTOR.
- 14. STOP SIGNS SHALL BE R1-1 36"x36" ON PUBLIC STREETS.
- 15. NO OBSTRUCTION OF PUBLIC R/W OR SIDEWALK WILL BE ALLOWED. NO PARKING IS ALLOWED OVER PUBLIC SIDEWALKS.
- 16. ANY FENCE OR WALL CONSTRUCTED ADJACENT TO ANY SIDEWALK OR STREET OR RIGHT-OF-WAY WILL REQUIRE A CERTIFICATE ISSUED BY CDOT.
- 17. DEVELOPER WILL PROVIDE STREET SIGNS PER CLDS#50.05 (9" SIGNS ONLY) FOR PUBLIC ROADS.
- 18. COORDINATE ALL CURB AND STREET GRADES IN INTERSECTION WITH INSPECTOR.
- 19. NO DEMOLITION LANDFILLS ALLOWED ON SITE.
- 20. THE APPROXIMATE COMPLETION TIME OF THIS PROJECT IS OCTOBER 1, 2019.
- 21. PIPE SYSTEMS AND OPEN CHANNELS ON PRIVATE PROPERTY SHALL BE PLACED IN A STORM DRAINAGE EASEMENT. STORM DRAINAGE EASEMENTS (SDE) SHALL BE A MINIMUM OF FIFTEEN FEET FOR PIPES AND TWENTY FEET FOR OPEN CHANNELS. ALL STORM DRAINAGE ARE KEPT SEPARATE FROM ANOTHER EASEMENT EXCEPT WHERE AN OVERLAP IS APPROVED BY THE APPROPRIATE CITY ENGINEERING DEPARTMENT FOR RESIDENTIAL SITES. THE EASEMENT SHALL BE DEDICATED TO THE HOMEOWNERS ASSOCIATION.
- 22. THE PURPOSE OF THE STORM DRAINAGE EASEMENT (SDE) IS TO PROVIDE STORM WATER CONVEYANCE. STRUCTURES OR ANY OTHER OBJECT WHICH MAY IMPEDED STORM WATER FLOW OR SYSTEM MAINTENANCE ARE PROHIBITED. MAINTENANCE OF THE SIDE SHALL BE THE RESPONSIBILITY OF THE HOME OWNERS ASSOCIATION.
- 23. APPROVAL OF THIS PLAN IS NOT AN AUTHORIZATION TO GRADE ADJACENT PROPERTIES. WHEN CONDITIONS WARRANT OFF-SITE GRADING, PERMISSION MUST BE OBTAINED FROM THE AFFECTED PROPERTY OWNERS.
- 24. IN ORDER TO ASSURE PROPER DRAINAGE, KEEP A MINIMUM OF 0.5% SLOPE ON THE CURB.
- 25. SUBSURFACE DRAINAGE FACILITIES MAY BE REQUIRED IN THE STREET RIGHT-OF-WAY IF DEEMED NECESSARY BY THE INSPECTOR
- 26. THE DEVELOPER SHALL MAINTAIN EACH STREAM, CREEK, OR BACKWASH CHANNEL IN AN UNOBSTRUCTED STATE AND SHALL REMOVE FROM THE CHANNEL AND BANKS OF THE STREAM ALL DEBRIS, LOGS, TIMBER, JUNK AND OTHER ACCUMULATIONS.
- 27. ANY BUILDING WITHIN THE 100+1 BUILDING RESTRICTION FLOOD LINE IS SUBJECT TO THE RESTRICTIONS OF THE (MECKLENBURG COUNTY) SUBDIVISION ORDINANCE, SECTION 7.200.8
- 28. PRIOR TO PLAT RECORDATION, OFFSITE R/W AND/OR CONSTRUCTION EASEMENTS ARE REQUIRED TO BE OBTAINED ACCORDING TO THE GUIDELINES OF THE "OFFSITE R/W ACQUISITION PROCESS". THESE NEEDED R/W AND CONSTRUCTION LIMITS ARE CLEARLY SHOWN ON THE ROADWAY IMPROVEMENT
- 29. TREE SAVE AREAS WILL BE RECORDED ON SUBDIVISION PLAT AND MAINTAINED BY THE HOMEOWNERS ASSOCIATION.

- 30. COMMUNITY ENCROACHMENT LINE MUST BE MARKED AND MAINTAINED ON SITE UNTIL FINAL GRADING IS COMPLETED
- 31. PER SECTION 18-175(e) OF THE CITY CODE AND SECTION 10.0 OF THE CITY'S POST CONSTRUCTION CONTROLS ADMINISTRATING MANUAL, ALL NATURAL AREAS AND/ OR POST CONSTRUCTION CONTROL EASEMENTS (PCCE) MUST BE RECORDED PRIOR TO THE ISSUANCE OF THE CERTIFICATE OF OCCUPANCY.
- 32. CERTIFICATIONS AND STREET CUT PERMITS ARE REQUIRED FOR UTILITY CUTS ON CITY STREETS. ALLOW 7 DAYS FOR PROCESSING. FOR PERMIT FORM INFORMATION, CONTACT CHARLOTTE DEPARTMENT OF TRANSPORTATION (704-336-4025) OR VISIT HTTP://WWW.CHARMECK.ORG/DEPARTMENTS/ TRANSPORTATION/STREET+MAINTAINANCE/HOME.HTM
- 33. ALL UTILITIES WILL BE UNDERGROUND.
- 34. ALL ROAD IMPROVEMENTS ON BEREWICK COMMONS PARKWAY ARE TO BE COORDINATED WITH THE CITY OF CHARLOTTE ENGINEERING DEPARTMENT PRIOR TO CONSTRUCTION.
- 35. ANY CONSTRUCTION OR USE WITHIN THE AREAS DELINEATED AS COMMUNITY ENCROACHMENT (0.1') FLOODWAY ENCROACHMENT AREA IS SUBJECT TO THE RESTRICTIONS IMPOSED BY THE FLOODWAY REGULATIONS OF MECKLENBURG COUNTY.
- 36. "AS-BUILT" DRAWINGS AND PLANS OF THE STORM DRAINAGE SYSTEM, INCLUDING DESIGNED DITCHES, MUST BE SUBMITTED PRIOR TO SUBDIVISION FINAL INSPECTION TO THE TOWN/COUNTY ENGINEERING DEPARTMENT IN ACCORDANCE WITH THE TOWN/COUNTY ORDINANCE.
- 37. IN ROLLING AND HILLY TERRAINS, SWEEPING OF THE STONE BASE AND/OR APPLICATION OF A TACK COAT MAY BE REQUIRED NEAR INTERSECTIONS. THESE REQUIREMENTS WILL BE ESTABLISHED BY THE INSPECTOR AND BASED ON FIELD CONDITIONS.
- 38. HANDRAILS MAY BE REQUIRED BY A REPRESENTATIVE OF THE CITY, IF WARRANTED BY FIELD CONDITIONS (CLDS 50.04A,B).
- 39. HIGH-DENSITY POLYETHYLENE (HDPE) STORM DRAINAGE PIPE INSTALLED WITHIN EXISTING OR PROPOSED PUBLIC STREET RIGHT-OF-WAY MUST BE APPROVED BY THE CITY'S INSPECTOR PRIOR TO ANY BACKFILL BEING PLACED. BACKFILL MATERIAL MUST BE APPROVED BY THE CITY INSPECTOR PRIOR TO PLACEMENT OF THE MATERIAL WITHIN THE PUBLIC STREET RIGHT-OF-WAY.
- 40. ALL OPENINGS (E.G. DOORS, WINDOWS, VENTS) IN STRUCTURES SHOULD BE LOCATED A MINIMUM OF ONE FOOT ABOVE THE ADJACENT FINISHED GROUND SURFACE (APPLIES TO LOTS WHICH MAY EXPERIENCE SIGNIFICANT OVERLAND FLOW NOT CONSIDERED IN THE 100+1 FLOOD ANALYSIS).
- 41. AS-BUILTS FOR ALL APPLICABLE DETENTION STRUCTURES AND BMP MEASURES ARE REQUIRED. AS-BUILTS ARE TO INCLUDE LATITUDE AND LONGITUDE FOR CENTER OF MEASURE, AND INLETS AND OUTLETS OF ALL STRUCTURES. ELEVATIONS AND DIMENSIONS ARE REQUIRED FOR ALL MEASURED.
- 42. PRIOR TO CO, SURVEYOR SEALED AS-BUILT DRAWINGS OF ALL WATER QUALITY BMP'S AND DETENTION SYSTEMS MUST BE PROVIDED.
- 43. NON-STANDARD ITEMS (I.E. PAVERS, IRRIGATION SYSTEMS, ETC.) IN THE RIGHT-OF-WAY REQUIRE A RIGHT-OF-WAY ENCROACHMENT AGREEMENT WITH THE CHARLOTTE DEPARTMENT OF TRANSPORTATION / NORTH CAROLINA DEPARTMENT OF TRANSPORTATION BEFORE INSTALLATION. FOR CITY OF CHARLOTTE MAINTAINED STREETS, CONTACT CDOT AT (704) 336-3888.
- 44. PE SEALED SHOP DRAWINGS FOR RETAINING WALLS MUST BE SUBMITTED TO CITY ENGINEERS PRIOR TO CONSTRUCTION.
- 45. THE DEVELOPER SHALL CONTACT THE CHARLOTTE DEPARTMENT OF TRANSPORTATION (GUS JORDI, 704-336-7056) TO IDENTIFY ANY CONFLICTS WITH TRAFFIC SIGNALIZATION EQUIPMENT. 60-90 DAYS WILL BE REQUIRED TO COORDINATE RELOCATION. DEVELOPER SHALL BE RESPONSIBLE FOR ALL RELATED RELOCATION COST AND/ OR ANY REPAIR COST CAUSED BY THE CONTRACTOR/ DEVELOPER.
- 46. SIDEWALK WITHIN THE CITY'S R/W THAT REQUIRES REPLACEMENT AS PART OF THE DEVELOPMENT AND/OR STREET IMPROVEMENTS SHOULD BE PHASED IN SUCH A WAY AS TO MINIMIZE THE DURATION OF THE SIDEWALK CLOSURE TO THE EXTENT FEASIBLE. THE DEVELOPER SHOULD MAKE EVERY ATTEMPT TO HAVE SIDEWALK REPAIRED AND REOPENED FOR PUBLIC USE WITHIN 30 DAYS OF REMOVAL.
- 47. ANY WORK WITHIN THE CITY'S R/W THAT REQUIRES CLOSURE OF THE SIDEWALK OR TRAVEL LANE FOR LESS THAN 30 DAYS REQUIRES A R/W USE PERMIT. TRAFFIC CONTROL PLANS FOR ANY SIDEWALK OR TRAVEL LANE CLOSURES MUST BE SUBMITTED AS PART OF THE R/W USE PERMIT REQUEST. TRAFFIC CONTROL PLANS MUST BE IN ACCORDANCE WITH CDOT'S WORK AREA TRAFFIC CONTROL HANDBOOK (WATCH) AND MUST BE REVIEWED AND APPROVED. CONTRACTOR SHALL CONTACT CDOT AT LEAST 5 BUSINESS DAYS IN ADVANCE OF BEGINNING OF WORK AT (704) 432-1562.
- 48. RIGHT-OF-WAY CLOSURES LONGER THAN 30 DAYS REQUIRE A R/W LEASE AGREEMENT WHICH WILL INCLUDE THE SUBMITTAL OF A TRAFFIC CONTROL PLAN. TRAFFIC CONTROL PLANS REQUIRED THROUGH A LEASE AGREEMENT MAY BE DIFFERENT FROM THE ONE REQUIRED THROUGH LAND DEVELOPMENT PLAN REVIEW AND ARE SUBJECT TO REVISIONS. THE REVISED TRAFFIC CONTROL PLANS MUST BE SUBMITTED AS PART OF THE LEASE AGREEMENT PROCESS FOR APPROVAL PRIOR TO START OF R/W CLOSURES. CONTRACTOR SHALL CONTACT CDOT AT (704) 336-8348.
- 49. CONSTRUCTION STAGING WITHIN CITY R/W LASTING MORE THAN 30 DAYS REQUIRES A R/W LEASE AGREEMENT. CONTRACTOR SHALL CONTACT CDOT AT (704) 336-8348.



DATE 05/05/2017

DRAWN BY J. HORTON DESIGNED BY

J. HORTON CHECKED BY C. TODD

SCALE AS SHOWN



. CONTRACTOR IS FULLY RESPONSIBLE FOR CONTACTING APPROPRIATE PARTIES AND ASSURING THAT EXISTING UTILITIES ARE LOCATED PRIOR TO CONSTRUCTION. 2. CONTRACTOR IS RESPONSIBLE FOR PLACING BARRICADES USIN FLAG MEN, ETC. AS NECESSARY TO INSURE SAFETY TO THE

3. ALL PAVEMENT CUTS, CONCRETE OR ASPHALT, ARE TO BE REPLACED ACCORDING TO STANDARDS OF THE NORTH CAROLIN DEPARTMENT OF TRANSPORTATION AND CHARLOTTE-MECKLENBURG UTILITIES SPECIFICATIONS.

SHEET NO. C201

JOB NO.

38225

