
The Villages at Back Creek - Phase Two

Charlotte, North Carolina

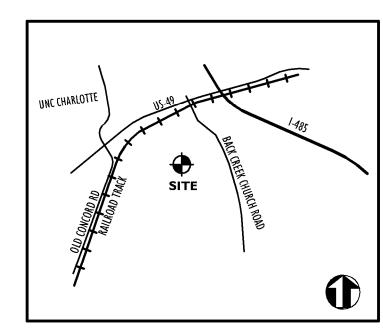

Vicinity Map - NTS

Owner

BnA, LLC 10648 Bunclody Drive Charlotte, NC 28213 (704) 201-8859

Designer

Charlotte, NC 28208 www.benesch.com P 704.521.9880

Sheet Title



Contact: Phillip Hobbs, ASLA

	nt Data
JURISDICTION	CITY OF CHARLOTTE
EXISTING ZONING:	MX-2
REZONING PETITION NO.:	2002–112
TAX PARCEL NUMBER:	051-122-25
DEED BOOK NUMBER: PROPOSED USE	15819 PAGE 25 TOWNHOMES FOR SALE
	TO MATIONIZED TOTAL OFFICE
SITE AREA:	PHASE 2:
TOTAL GROSS AREA:	30.70 ACRES
DEDICATED R/W TOTAL NET AREA:	6.15 ACRES (20.0% OF PHASE 2 AREA) 24.55 ACRES (80.0% OF PHASE 2 AREA)
EASEMENTS, BUFFERS, SETBACKS:	
TOTAL DEVELOPABLE AREA:	20.33 ACRES (66.2% OF PHASE 2 AREA)
(LESS R/W, SETBACKS, BUFFER)	
MAXIMUM ALLOWABLE UNITS:	192 SINGLE FAMILY ATTACHED (TRACT E) + 11 IN PHASE 2 TRACT "F"
PROPOSED UNITS (SHOWN):	189 SINGLE FAMILY ATTACHED (11 UNITS OF TRACT "F" IN PHASE 2)
REAR YARD INTERNAL 10' EXTERNAL 40'	
BUILDING SEPARATION 16'	
REQUIRED PARKING	
(1.5/TOWNHOUSE UNIT)	284 SPACES
TOTAL REQUIRED PARKING	284 SPACES
PROVIDED PARKING SPACES	399 SPACES (93 GARAGE UNITS @2 SP/UNIT)
PROPOSED GROSS DENSITY:	6.15 UNITS/AC
NET DENSITY	7.78 UNITS/AC
PROPOSED DEVELOPABLE DENSITY:	•
	IE UNITS (400 SF/UNIT)= 75,600 SF ME UNIT WILL HAVE MIN. OF 400 S.F. SUBLOT
COMMON OPEN SPACE:	
	OTAL PROPERTY: 40.8 AC (26.15%)
REQUIRED FOR PH PROPOSED (REZO	The second secon
PROVIDED: ±11.82	
MAXIMUM HEIGHT: 40' (3 STO	DRIES MAX.)
	(3.84 AC) , 15.6% OF NET AREA E = 163,536 SF (3.75 AC), 15.3% OF NET AREA
SIDEWALK COVERAGE: 37,088 SF (0.8	

Sheet Schedule

Cover Sheet	•	8.29.06	4.15.16	12	Revised Per Comments
Rezoning Plan	1 of 3	3.17.03			
Rezoning Plan	2 of 3	3.17.03			
Rezoning Plan	3 of 3	3.17.03			
Site Survey	•	3.3.06			
Master Phasing Plan	L-1.0	8.29.06	2.23.16	11	Convert Windsor units to Parkside
Clearing/Demolition Plan	L-1.1	8.29.06	2.23.16	11	Convert Windsor units to Parkside
Site Plan	L-2.1	8.29.06	4.15.16	12	Revised Per Comments
Site Plan	L-2.2	8.29.06	4.15.16	12	Revised Per Comments
Initíal Erosion Control Plan	L-3.1	8.29.06	4.15.16	12	Revised per Comments
Final Erosion Control Plan	L-3.2	8.29.06	2.23.16	11	Convert Windsor units to Parkside
Grading/Storm Drainage Plan	L-3.3	8.29.06	2.23.16	11	Convert Windsor units to Parkside
Grading/Storm Drainage Plan	L-3.4	8.29.06	2.23.16	11	Convert Windsor units to Parkside
Component Drainage Area Plan	L-3.5	8.29.06	2.23.16	11	Convert Windsor units to Parkside
SCS Drainage Area Plan	L-3.6	8.29.06	2.23.16	11	Convert Windsor units to Parkside
Off—Site Drainage Area Plan	L-3.7	11.27.06	4.30.14	3	Convert Windsor units to Parkside
Utility Plan	L-4.1	8.29.06	4.15.16	12	Revised per Comments
Utility Plan	L-4.2	8.29.06	2.23.16	11	Convert Windsor units to Parkside
Sanitary Sewer Profiles	L-4.3	8.29.06	4.30.14	7	Convert Windsor units to Parkside
Sanitary Sewer Profiles	L-4.4	8.29.06	4.30.14	7	Convert Windsor units to Parkside
Road Plan and Profile Private Streets	L-5.1	8.29.06	4.30.14	1	Convert Windsor units to Parkside
Road Plan and Profile Private Streets	L-5.2	8.29.06	4.30.14	1	Convert Windsor units to Parkside
Road Plan and Profile Private Streets	L-5.3	8.29.06	4.30.14	1	Convert Windsor units to Parkside
Road Plan and Profile Private Streets	L-5.4	8.29.06	4.30.14	1	Convert Windsor units to Parkside
Storm Sewer Profiles	L-6.1	8.29.06	4.30.14	3	Convert Windsor units to Parkside
Storm Sewer Profiles	L-6.2	8.29.06	4.30.14	9	Convert Windsor units to Parkside
Retaining Wall Elevations	L-6.3	8.29.06	2.23.16	11	Convert Windsor units to Parkside
Site Construction Details	L-7.1	8.29.06	4.15.16	12	Revised per Comments
Site Construction Details	L-7.2	8.29.06	4.30.14	10	Convert Windsor units to Parkside
Site Construction Details	L-7.3	8.29.06	4.30.14	1	Convert Windsor units to Parkside
Site Construction Details	L-7.4	8.29.06	4.15.16	12	Revised per Comments
Site Construction Details	L-7.5	8.29.06	4.30.14	2	Convert Windsor units to Parkside
Basin 1 Stormwater Wetland Details	L-7.6	8.29.06	6.17.14	4	Rev. per comments
Basin 2 Stormwater Wetland Details	L-7.7	8.29.06	6.17.14	3	Rev. per comments
Landscape Plan	L-8.1	8.29.06	4.15.16	12	Revised per Comments
Landscape Plan	L-8.2	8.29.06	4.15.16	12	Revised per Comments
Open Space Plan	L-9.1	8.29.06	2.23.16	11	Convert Windsor units to Parkside

3 PROVIDED

Original Date

Sheet No.

SOLID WASTE/ RECYCLING CONTAINER REQUIREMENTS

Latest Revision


- ONE (1) 144 S.F. RECYCLING STATION REQUIRED FOR 30 - 80 UNITS

Latest Revision

Number

Revision

Index

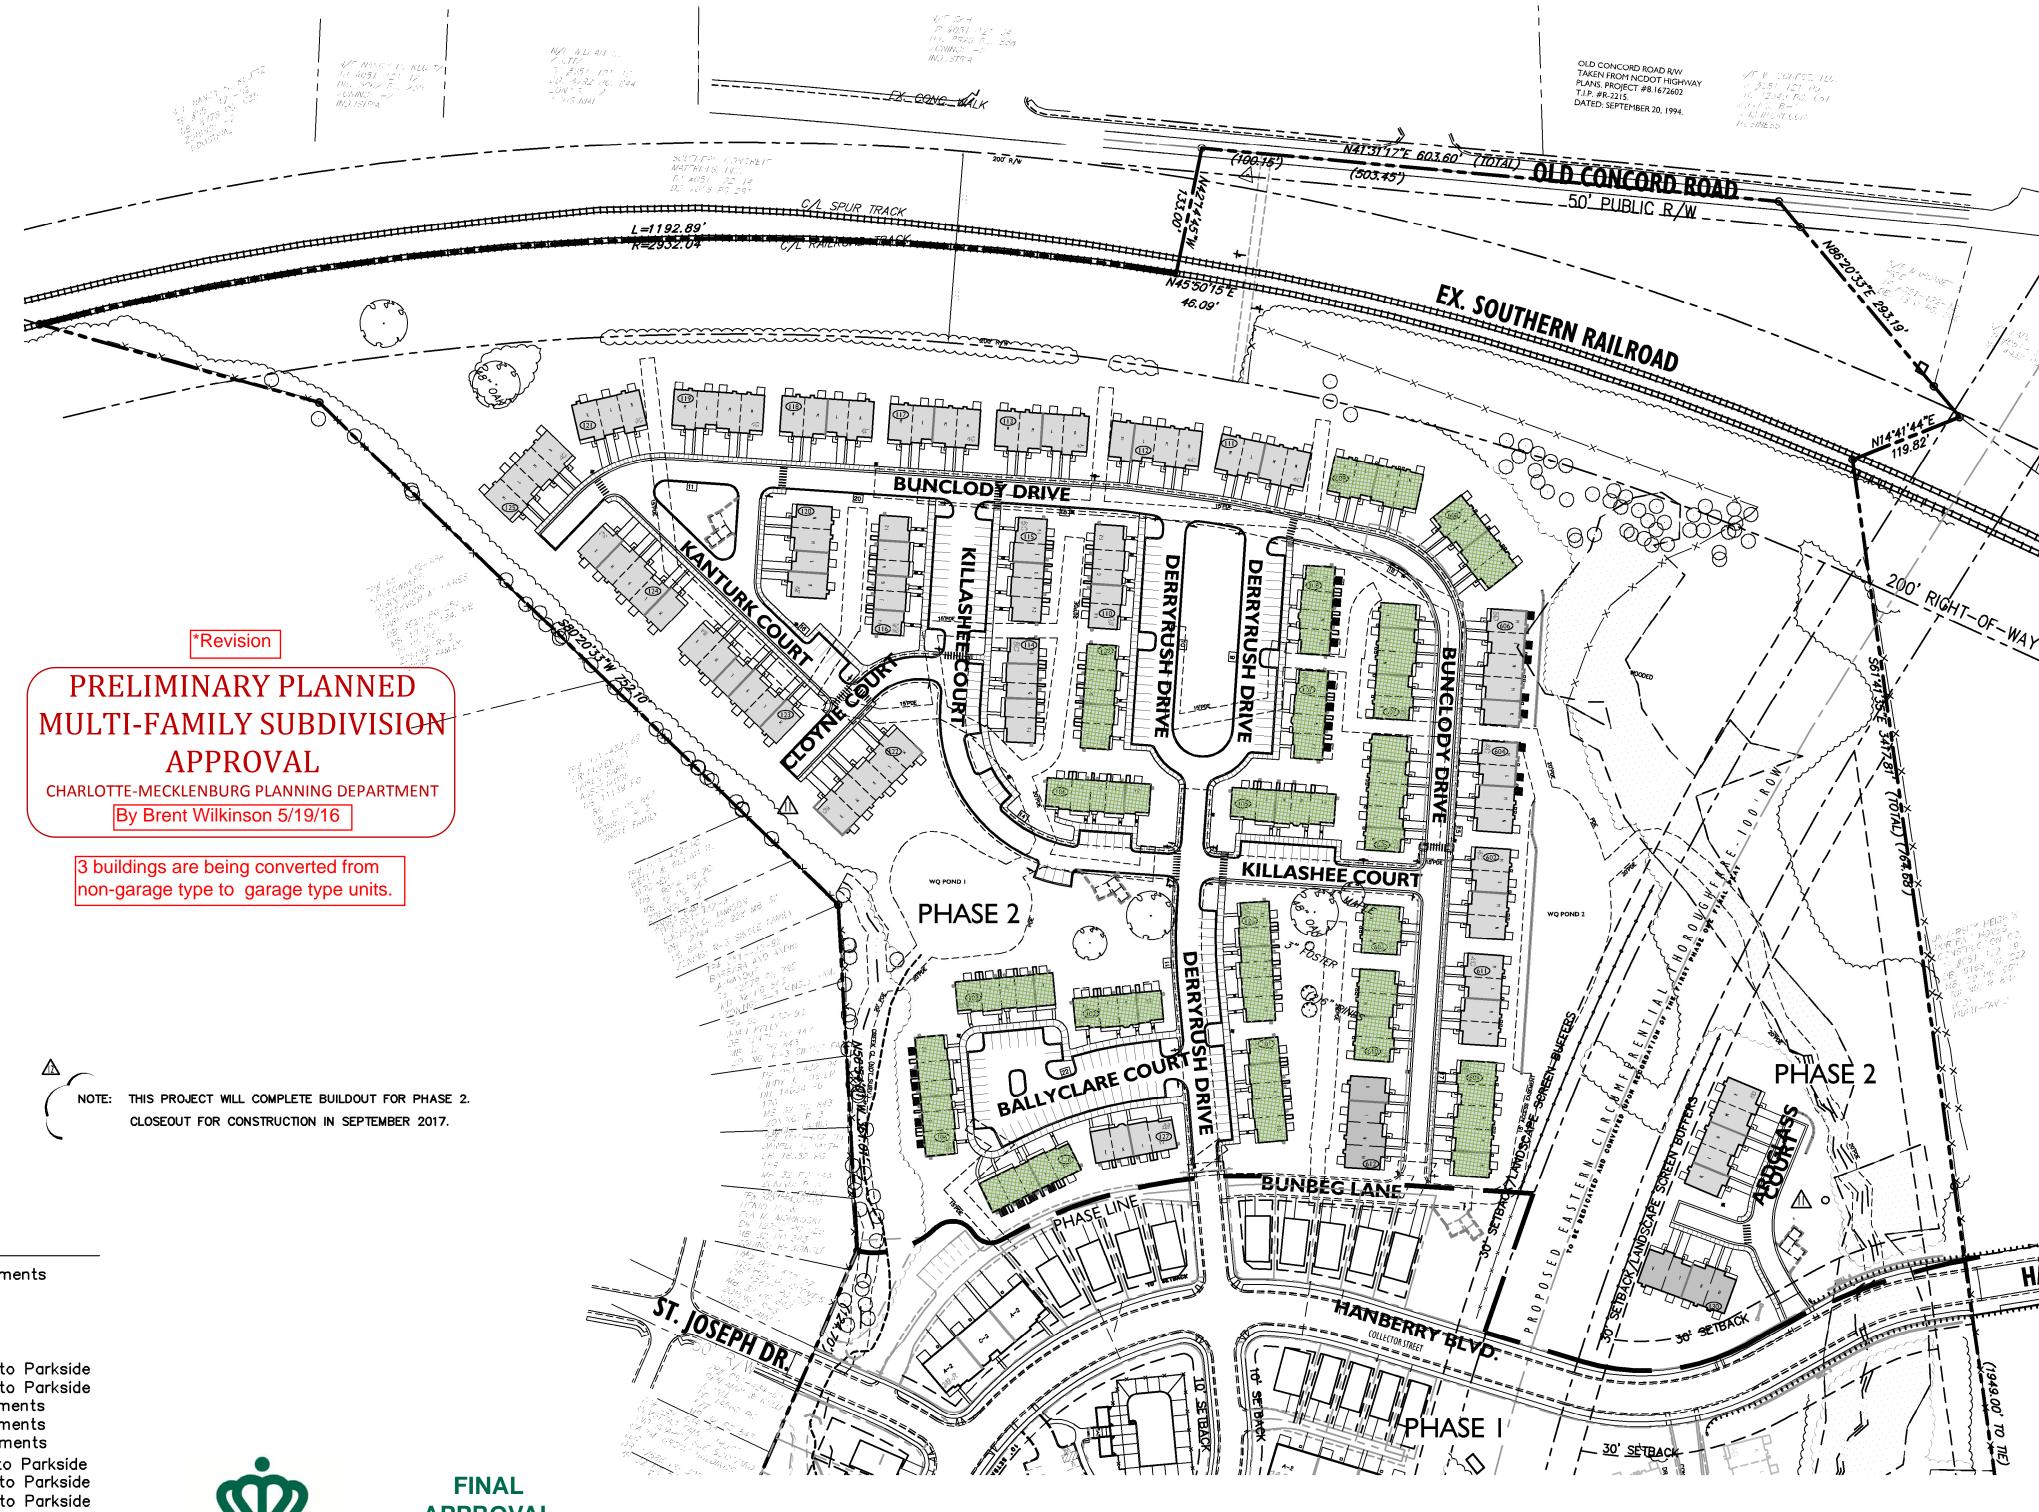



APPROVAL

http://development.charmeck.org

APPROVED ENGINEERING By mchapman at 2:32 pm, May 10, 2016 PCO / DETENTION / DRAINAGE PLAN **EROSION CONTROL**

APPROVED


By Stan Armstrong at 1:44 pm, May 11, 2016

AT LEAST 48 HRS. PRIOR TO ANY LAND DISTURBING ACTIVITY USING THE ONLINE FORM AT http://development.charmeck.org

URBAN FORESTRY TREE ORDINANCE

CDOT

Site Plan

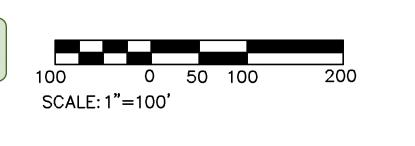


PROJECT SHALL COMPLY WITH PHASING REQUIREMENTS OF PHASE ONE UNDER SECTION "C" OF THE CONDITIONAL REZONING



LEGEND PROPOSED STREET SIGN PROPOSED STOP SIGN PROPOSED STREET LIGHT PROPOSED FIRE HYDRANT PROPOSED BACKFLOW PREVENTER PROPOSED CHAIN LINK FENCE PROPOSED CURB AND GUTTER

Set No.



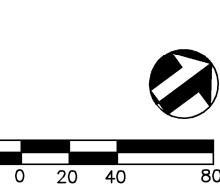


1"=40'



Ba Villages at Phase

oject No:	2289B
awn By:	S. Hirsch/T. Teasley
signed By:	P. Hobbs
ecked By:	P. Hobbs
ite:	08.29.06
visions:	-
Rev. per comments	10.19.06
Rev. per comments	11.27.06
Addendum I- added units	1.9.07
Building Numbers	2.6.07
Parkside Conversion	04.30.14
Rev. per comments	06.17.14
Parkside Conversion 2	02.23.16

Site Plan

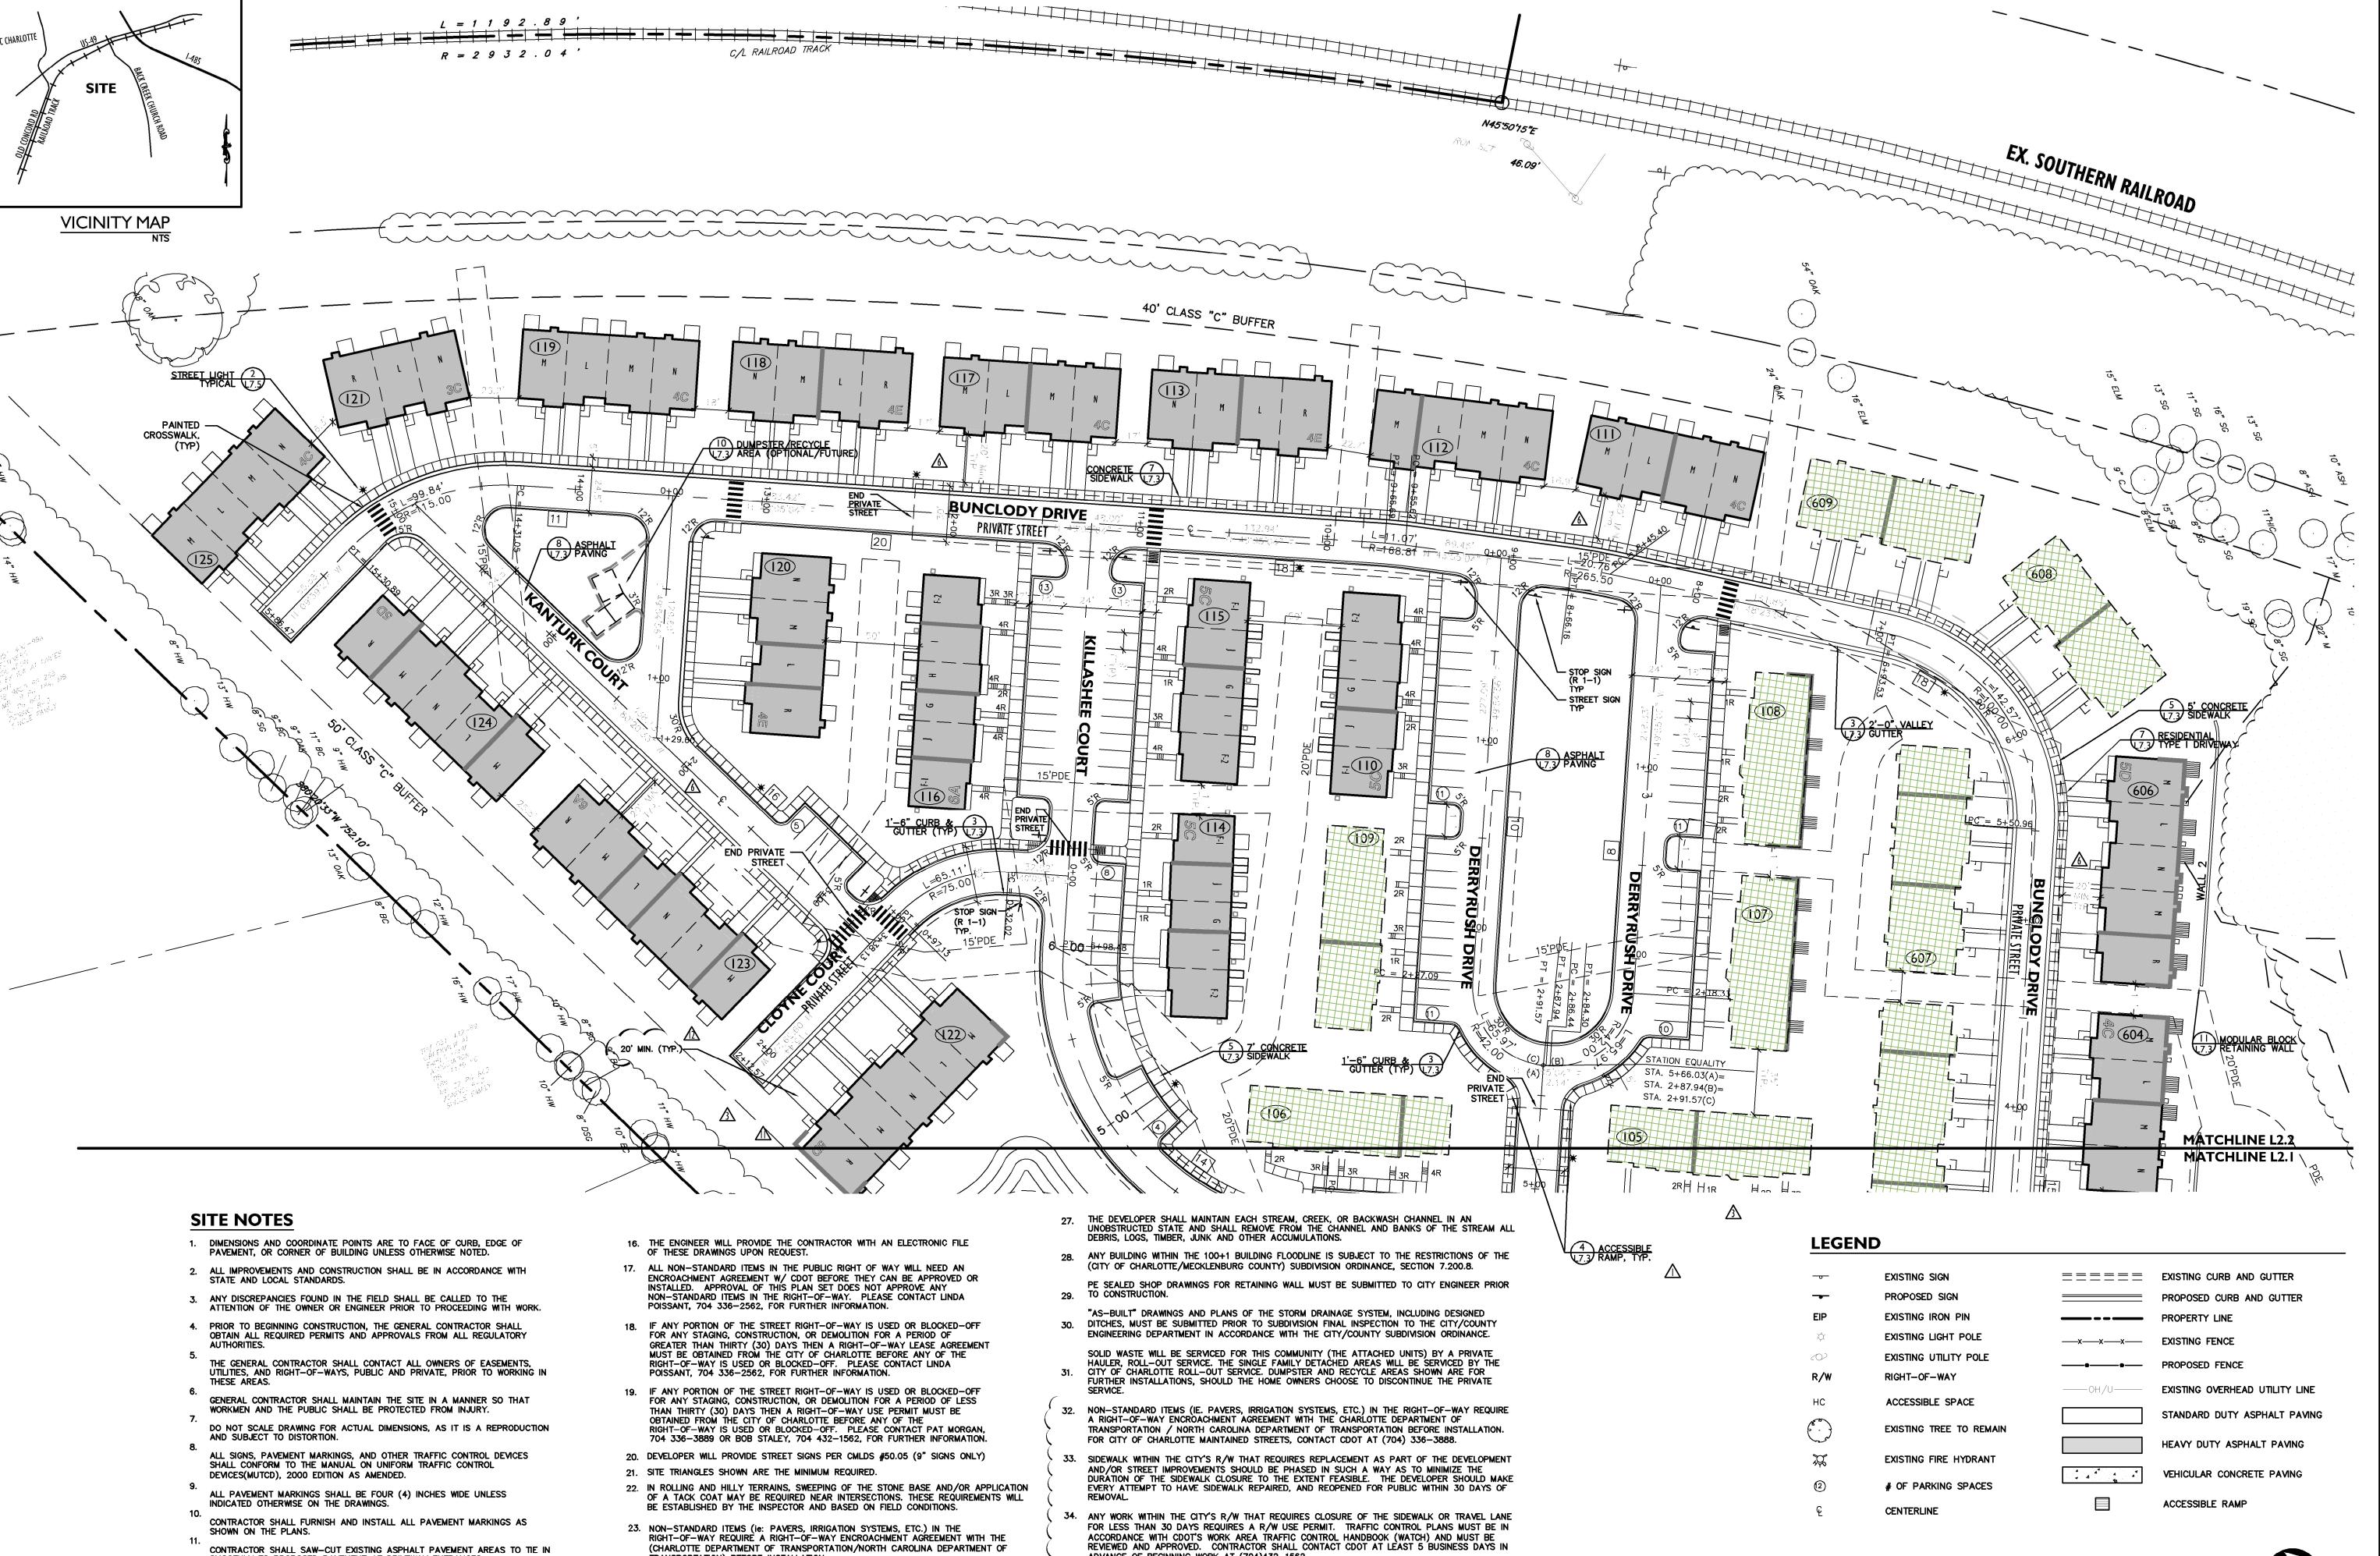

ADVANCE OF BEGINNING WORK AT (704)432-1562.

35. RIGHT-OF-WAY CLOSURES LONGER THAN 30 DAYS REQUIRE A R/W LEASE AGREEMENT WHICH

TO START OF R/W CLOSURES. CONTRACTOR SHALL CONTACT CDOT AT (704) 336-8348.

AGREEMENT. CONTRACTOR SHALL CONTACT CDOT AT (704)336-8348.

36. CONSTRUCTION STAGING WITHIN CITY R/W LASTING MORE THAN 30 DAYS REQUIRES A R/W LEASE

WILL INCLUDE THE SUBMITTAL OF A TRAFFIC CONTROL PLAN. TRAFFIC CONTROL PLANS REQUIRED

THROUGH LEASE AGREEMENT MAY BE DIFFERENT FROM THE ONE REQUIRED DURING THE LAND DEVELOPMENT PLAN REVIEW AND ARE SUBJECT TO REVISIONS. THE REVISED TRAFFIC CONTROL PLANS MUST BE SUBMITTED AS PART OF THE LEASE AGREEMENT PROCESS FOR APPROVAL PRIOR

TRANSPORTATION) BEFORE INSTALLATION.

FLOW IS PROHIBITED.

24. IN ORDER TO ENSURE PROPER DRAINAGE, KEEP A MINIMUM OF 0.5% SLOPE ON THE

25. SUBSURFACE DRAINAGE FACILITIES MAY BE REQUIRED IN THE STREET RIGHT-OF-WAY

WATER CONVEYANCE AND ANY STRUCTURES AND/OR OBSTRUCTION TO STORM WATER

26. THE PURPOSE OF THE STORM DRAINAGE EASEMENT (SDE) IS TO PROVIDE STORM

SMOOTHLY TO PROPOSED PAVEMENT AT DRIVEWAY ENTRANCES.

REFER TO ARCHITECTURAL PLANS FOR ACTUAL BUILDING DIMENSIONS.


COORDINATE ALL CURB AND STREET GRADES IN INTERSECTION WITH

ALL ROAD IMPROVEMENTS AT PROP. EASTERN CIRCUMFERENTIAL

LAND DEVELOPMENT INSPECTOR TO BE GIVEN 24 HOURS NOTICE PRIOR TO START OF CONSTRUCTION.

THOROUGHFARE TO BE COORDINATED WITH ENGINEERING DEPARTMENT PRIOR TO CONSTRUCTION.

Corp. NC License: F-13.

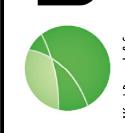

Seals:



he Villages at Back Creel Phase Two

Project No: 2289B

Drawn By: S. Hirsch/T. Teasley

Designed By: P. Hobbs

Checked By: P. Hobbs

Date: 08.29.06

Revisions:

Rev. per comments 10.19.06

Addendum 1- added units 1.9.07

A Building Numbers 2.6.07

Parkside Conversion 04.30.14

12\Rev. per comments

Sheet Title:

0 20 40

1"=40'

6 Rev. per comments

<u>∕11</u> Parkside Conversion 2

Site Plan

06.17.14

02.23.16

04.15.16

Sheet No: L-2.2