#### SEQUENCE OF CONSTRUCTION - PHASE I

- 1. EROSION CONTROL PLAN IS APPROVED BY THE CITY OF CHARLOTTE EROSION CONTROL PROGRAM
- 2. CONTRACTOR MUST NOTIFY THE CITY OF CHARLOTTE SEDIMENT CONTROL INSPECTOR 48 HOURS PRIOR TO THE START OF EARTH DISTURBANCE.
- 3. THE LIMITS OF DISTURBANCE MUST BE FIELD MARKED PRIOR TO INSTALLATION OF SEDIMENT CONTROL MEASURES, DEMOLITION OR OTHER LAND DISTURBING ACTIVITIES.
- PRIOR TO ANY CLEARING, INSTALLATION OF SEDIMENT CONTROL MEASURES, OR GRADING, A PRE-CONSTRUCTION MEETING MUST BE CONDUCTED ON-SITE WITH THE EROSION SEDIMENT CONTROL INSPECTOR TO DISCUSS EROSION CONTROL MEASURES. (48 HOURS MINIMUM NOTICE)
- INSTALL SEDIMENT AND EROSION CONTROL MEASURES, INCLUDING PERIMETER SILT FENCE, TREE PROTECTION, SKIMMER BASIN AND STABILIZED CONSTRUCTION ENTRANCE/EXIT. COMPLETE INSTALLATION OF INLET PROTECTION ON EXISTING STORMWATER STRUCTURES.
- PERIMETER CONTROLS SHOULD BE CHECKED DAILY AND ADJUSTED AND/OR REPAIRED TO FULLY CONTAIN AND CONTROL SEDIMENTATION ON THIS SITE BY CONTRACTOR. PERIMETER CONTROLS ARE TO REMAIN FUNCTIONING FOR THE DURATION OF THE PROJECT. THE MONITORING AND INSPECTING OF EROSION CONTROL MEASURES SHOULD FOLLOW THE GUIDELINES OF THE NPDES PERMIT (GENERAL PERMIT NCG 010000).
- 6. CONTACT SEDIMENT CONTROL INSPECTOR UPON COMPLETION OF INSTALLATION OF PERIMETER EROSION AND SEDIMENT CONTROLS PRIOR TO PROCEEDING WITH ANY OTHER EARTH DISTURBANCE OR GRADING.
- UPON APPROVAL FROM SEDIMENT CONTROL INSPECTOR, COMPLETE DEMOLITION OF ANY SITE FEATURES (PAVEMENT, CURB, ETC.), CLEARING AND GRUBBING, AND STRIP SITE OF TOP SOIL.
- ALL DEMOLISHED MATERIAL IS TO BE DISPOSED IN ACCORDANCE WITH APPLICABLE NORTH CAROLINA REGULATIONS. CONTRACTOR TO ENSURE ALL APPLICABLE DEMOLITION PERMITS HAVE BEEN ISSUED AND HAVE ORIGINALS OF THE SAME PRIOR TO COMMENCING DEMOLITION ACTIVITIES.
- CONTACT SEDIMENT CONTROL INSPECTOR UPON COMPLETION OF STRIPPING, THE STOCKPILING OF TOPSOIL, THE CONSTRUCTION OF TEMPORARY SEDIMENT AND EROSION CONTROL FACILITIES, DISPOSAL OF ALL WASTE MATERIAL, AND PREPARATION OF THE GROUND.
- 9. CONTACT SEDIMENT CONTROL INSPECTOR FOR APPROVAL TO PROCEED
- 10. INITIATE ROUGH GRADING OF THE SITE.
- 11. TEMPORARILY STABILIZE GRADED AREAS (NON-STEEP SLOPES) AS REQUIRED.
- 12. COMPLETE ROUGH GRADING. COMPLETE THE INSTALLATION OF STM A2-A13 AND SITE UTILITIES.
- 13. CONTACT SEDIMENT CONTROL INSPECTOR UPON COMPLETION OF ROUGH GRADING, BUT PRIOR TO PLACING TOPSOIL, PERMANENT DRAINAGE, OR OTHER SITE DEVELOPMENT IMPROVEMENTS AND GROUND COVERS.
- 14. INSTALL CURB ALONG THE PERIMETER OF THE SITE TO AID IN THE PROTECTION OF THE EXISTING ADJACENT PROPERTIES AN ADJACENT ROADWAYS
- 15. BUILDING CONSTRUCTION MAY BEGIN UPON INSTALLATION OF SEDIMENT CONTROLS AND SEDIMENT CONTROL INSPECTOR'S APPROVAL
- 16. FINE GRADE AND INITIATE FINAL PAVING. PERMANENTLY STABILIZE ANY REMAINING AREAS IN ACCORDANCE WITH THE PERMANENT SODDING SCHEDULE AND NOTES. INSTALL FINAL SITE LANDSCAPING.
- 17. REQUEST FINAL APPROVAL FROM THE SEDIMENT CONTROL INSPECTOR PRIOR TO REMOVING ANY REMAINING SEDIMENT CONTRO MEASURES AND UPON COMPLETION OF FINAL GRADING, PERMANENT DRAINAGE, AND EROSION CONTROL FACILITIES, INCLUDING ESTABLISHED GROUND COVERS AND PLANTING, AND ALL OTHER WORK OF THE BUILDING PERMITS.
- 18. ESTIMATED START DATE IS FALL 2016 AND COMPLETION DATE IS FALL 2017

UTILITY/ GOVERNING AGENCIES

## UTILITY RESPONSIBILITY MATRIX FOR THIS PROJECT

#### CONTACTS CONTRACTOR RESPONSIBILITY-

WARNER CABLE ESCENT EXECUTIVE DR DTTE, NC 28217 1-3000 E POWER 701516 DTTE, NC 28272 -9898 CITY OF CHARLOTTE RTMENT OF WATER &	<ul> <li>-COORDINATE CONSTRUCTION ACTIVITIES WITH TELEPHONE COMPANY TO ENSURE INSTALLATION OF UNDERGROUND LINES ARE COMPLETED PRIOR TO ASPHALT OR CURB PLACEMENT.</li> <li>-COORDINATE RELOCATION OF PHONE BOXES WITH TELEPHONE COMPANY WITHIN 10 DAYS OF AWARD OF CONTRACT.</li> <li>-PROVIDE AND INSTALL 2-4" SCHEDULE 40 PVC CONDUITS WITH PULL ROPES, INCLUDING ALL TRENCHING AND BACKFILLING, FROM THE RISER POLE UP TO THE BUILDING.</li> <li>-PROVIDE AND INSTALL PULL BOXES AS PER TELEPHONE COMPANY REQUIREMENTS.</li> <li>-COORDINATE CONSTRUCTION ACTIVITIES WITH ELECTRIC COMPANY TO ENSURE INSTALLATION OF UNDERGROUND LINES ARE COMPLETED PRIOR TO ASPHALT OR CURB PLACEMENT.</li> <li>-COORDINATE RELOCATION OF UTILITY POLES WITH ELECTRIC COMPANY WITHIN 10 DAYS OF AWARD OF CONTRACT.</li> <li>-PROVIDE AND INSTALL 2-4" SCHEDULE 40 PVC CONDUITS WITH PULL ROPES, INCLUDING TRENCHING AND BACKFILLING, FOR THE UNDERGROUND PORTIONS OF THE PRIMARY FROM THE RISER POLE UP TO THE TRANSFORMER. SCHEDULE 80 PVC CONDUITS SHALL BE USED ON THE RISER POLE AND RIGID METAL, LONG RADIUS ELBOWS SHALL BE USED WHERE THE UNDERGROUND PORTION MEETS THE RISER POLE AND TRANSFORMER.</li> <li>REMOVE EXISTING TRANSFORMER PAD AS PER THE ELECTRIC COMPANY'S SPECIFICATIONS.</li> <li>-CONSTRUCT TRANSFORMER PAD AS PER THE ELECTRIC COMPANY'S SPECIFICATIONS.</li> <li>-PROVIDE AND INSTALL ALL SECONDARY SERVICE AND MATERIALS.</li> <li>-REMOVE EXISTING TRANSFORMER PAD AS PER THE ELECTRIC COMPANY'S SPECIFICATIONS.</li> <li>-PROVIDE AND INSTALL ALL SECONDARY SERVICE AND MATERIALS.</li> <li>-RELOCATE UTILITY POLES AND OVERHEAD LINES AS REQUIRED.</li> <li>-PROVIDE AND INSTALL SANITARY SEWER LINES AND ASSOCIATED</li> </ul>	-TELEPHONE COMPANY WILL PROVIDE AND INSTALL ALL TELEPHONE CABLES FROM THE POINT OF CONNECTION UP TO THE BUILDING -PRESENT RESPONSIBLE PARTIES. -ANY RELOCATION OF EXISTING LINES WILL BE DONE BY TELEPHONE COMPANY. -ELECTRIC COMPANY WILL PROVIDE AND INSTALL ALL MATERIALS NEEDED TO ESTABLISH PRIMARY OVERHEAD SERVICE FROM POINT OF CONNECTION AT THE EXISTING LINE UP TO THE TRANSFORMER. -ELECTRIC COMPANY WILL PROVIDE AND INSTALL PRIMARY CABLE FOR ALL UNDERGROUND LINES UP TO THE TRANSFORMER. -RELOCATE UTILITY POLES AND OVERHEAD LINES AS REQUIRED. -ELECTRIC COMPANY WILL PROVIDE TRANSFORMER.
701516 DTTE, NC 28272 7-9898 CITY OF CHARLOTTE	COMPANY TO ENSURE INSTALLATION OF UNDERGROUND LINES ARE COMPLETED PRIOR TO ASPHALT OR CURB PLACEMENT. -COORDINATE RELOCATION OF UTILITY POLES WITH ELECTRIC COMPANY WITHIN 10 DAYS OF AWARD OF CONTRACT. -PROVIDE AND INSTALL 2-4" SCHEDULE 40 PVC CONDUITS WITH PULL ROPES, INCLUDING TRENCHING AND BACKFILLING, FOR THE UNDERGROUND PORTIONS OF THE PRIMARY FROM THE RISER POLE UP TO THE TRANSFORMER. SCHEDULE 80 PVC CONDUITS SHALL BE USED ON THE RISER POLE AND RIGID METAL, LONG RADIUS ELBOWS SHALL BE USED WHERE THE UNDERGROUND PORTION MEETS THE RISER POLE AND TRANSFORMER. - REMOVE EXISTING TRANSFORMER PAD AS PER THE ELECTRIC COMPANY'S SPECIFICATIONS. -CONSTRUCT TRANSFORMER PAD AS PER THE ELECTRIC COMPANY'S SPECIFICATIONS. -PROVIDE AND INSTALL ALL SECONDARY SERVICE AND MATERIALS. -RELOCATE UTILITY POLES AND OVERHEAD LINES AS REQUIRED.	NEEDED TO ESTABLISH PRIMARY OVERHEAD SERVICE FROM POINT OF CONNECTION AT THE EXISTING LINE UP TO THE TRANSFORMER. -ELECTRIC COMPANY WILL PROVIDE AND INSTALL PRIMARY CABLE FOR ALL UNDERGROUND LINES UP TO THE TRANSFORMER. -RELOCATE UTILITY POLES AND OVERHEAD LINES AS REQUIRED.
R COOKSHIRE BLVD, DTTE, NC 28217 9-2221	APPURTENANCES PER THE PLANS AND SPECIFICATIONS. -ALL PUBLIC AND PRIVATE SANITARY SEWER LINES SHALL MEET SPECIFICATIONS. -COORDINATE REQUIRED INSPECTION SERVICES WITH ENGINEER OF RECORD AND THE UTILITIES DIVISION. SEE UTILITY PLAN FOR REQUIREMENTS.	
CITY OF CHARLOTTE RTMENT OF WATER & R ROOKSHIRE BLVD, DTTE, NC 28217 9-2221	<ul> <li>-PROVIDE AND INSTALL ALL WATER MAINS AND ASSOCIATED APPURTENANCES PER THE PLANS AND SPECIFICATIONS.</li> <li>-ALL PORTIONS OF THE FIRE PROTECTION WATER SYSTEM SHALL BE INSTALLED BY A LICENSED FIRE SPRINKLER CONTRACTOR.</li> <li>-ALL PORTIONS OF OTHER NON FIRE PROTECTION RELATED LINES MAY BE INSTALLED BY THE PLUMBING CONTRACTOR.</li> <li>-COORDINATE REQUIRED INSPECTION SERVICES WITH ENGINEER OF RECORD AND THE UTILITIES DIVISION. SEE UTILITY PLAN FOR REQUIREMENTS.</li> <li>-CONTRACTOR SHALL PROVIDE AND INSTALL WATER METER WITH UTILITY DIVISION.</li> </ul>	
OF CHARLOTTE MWATER SERVICES OURTH STREET ND 14TH FLOOR DTTE, NC 28202 2-3122	-PROVIDE AND INSTALL ALL STORM SEWER LINES AND ASSOCIATED APPURTENANCES PER THE PLANS AND SPECIFICATIONS. -REFER TO GRADING PLAN FOR INFORMATION ON ALLOWABLE STORM SEWER MATERIALS. -PIPE JOINTS TO BE SILT TIGHT. -CLEAN EXISTING PIPES IMMEDIATELY DOWNSTREAM OF CONNECTION.	
ENCHING AND BACKFILL, A	AND OTHER INCIDENTALS TO MEET OR EXCEED THE SPECIFICATIONS OF	THE ITEMS LISTED.CONTRACTOR SHALL VERIFY
	OOKSHIRE BLVD, DTTE, NC 28217 -2221 OF CHARLOTTE MWATER SERVICES DURTH STREET D 14TH FLOOR DTTE, NC 28202 -3122 THIS MATRIX HAS BEEL ENCHING AND BACKFILL, A RESPONSIBILITIES PRIOR CENERAL NOTE: TOR TO REVIEW ALL OF THE DRAWINGS ONSTRUCTION. SHOULD THE CONTRACT	OOKSHIRE BLVD,         DTTE, NC 28217         -2221         -222         -222         -222         -222         -222         -222         -222         -222         -222         -222         -222         -222         -222         -222         -222         -222         -3122         -222

CHARLOTTE ENGINEERING PCO / DETENTION / DRAINAGE PLAN


**EROSION CONTROL** 

**CDOT** 

OTHERS RESPONSIBILITY-

TREE ORDINANCE

NOTE: SCHEDULE PRE-CONSTRUCTION MEETING AT LEAST 48 HRS. PRIOR TO ANY LAND DISTURBING ACTIVITY USING THE ONLINE FORM AT http://development.charmeck.org

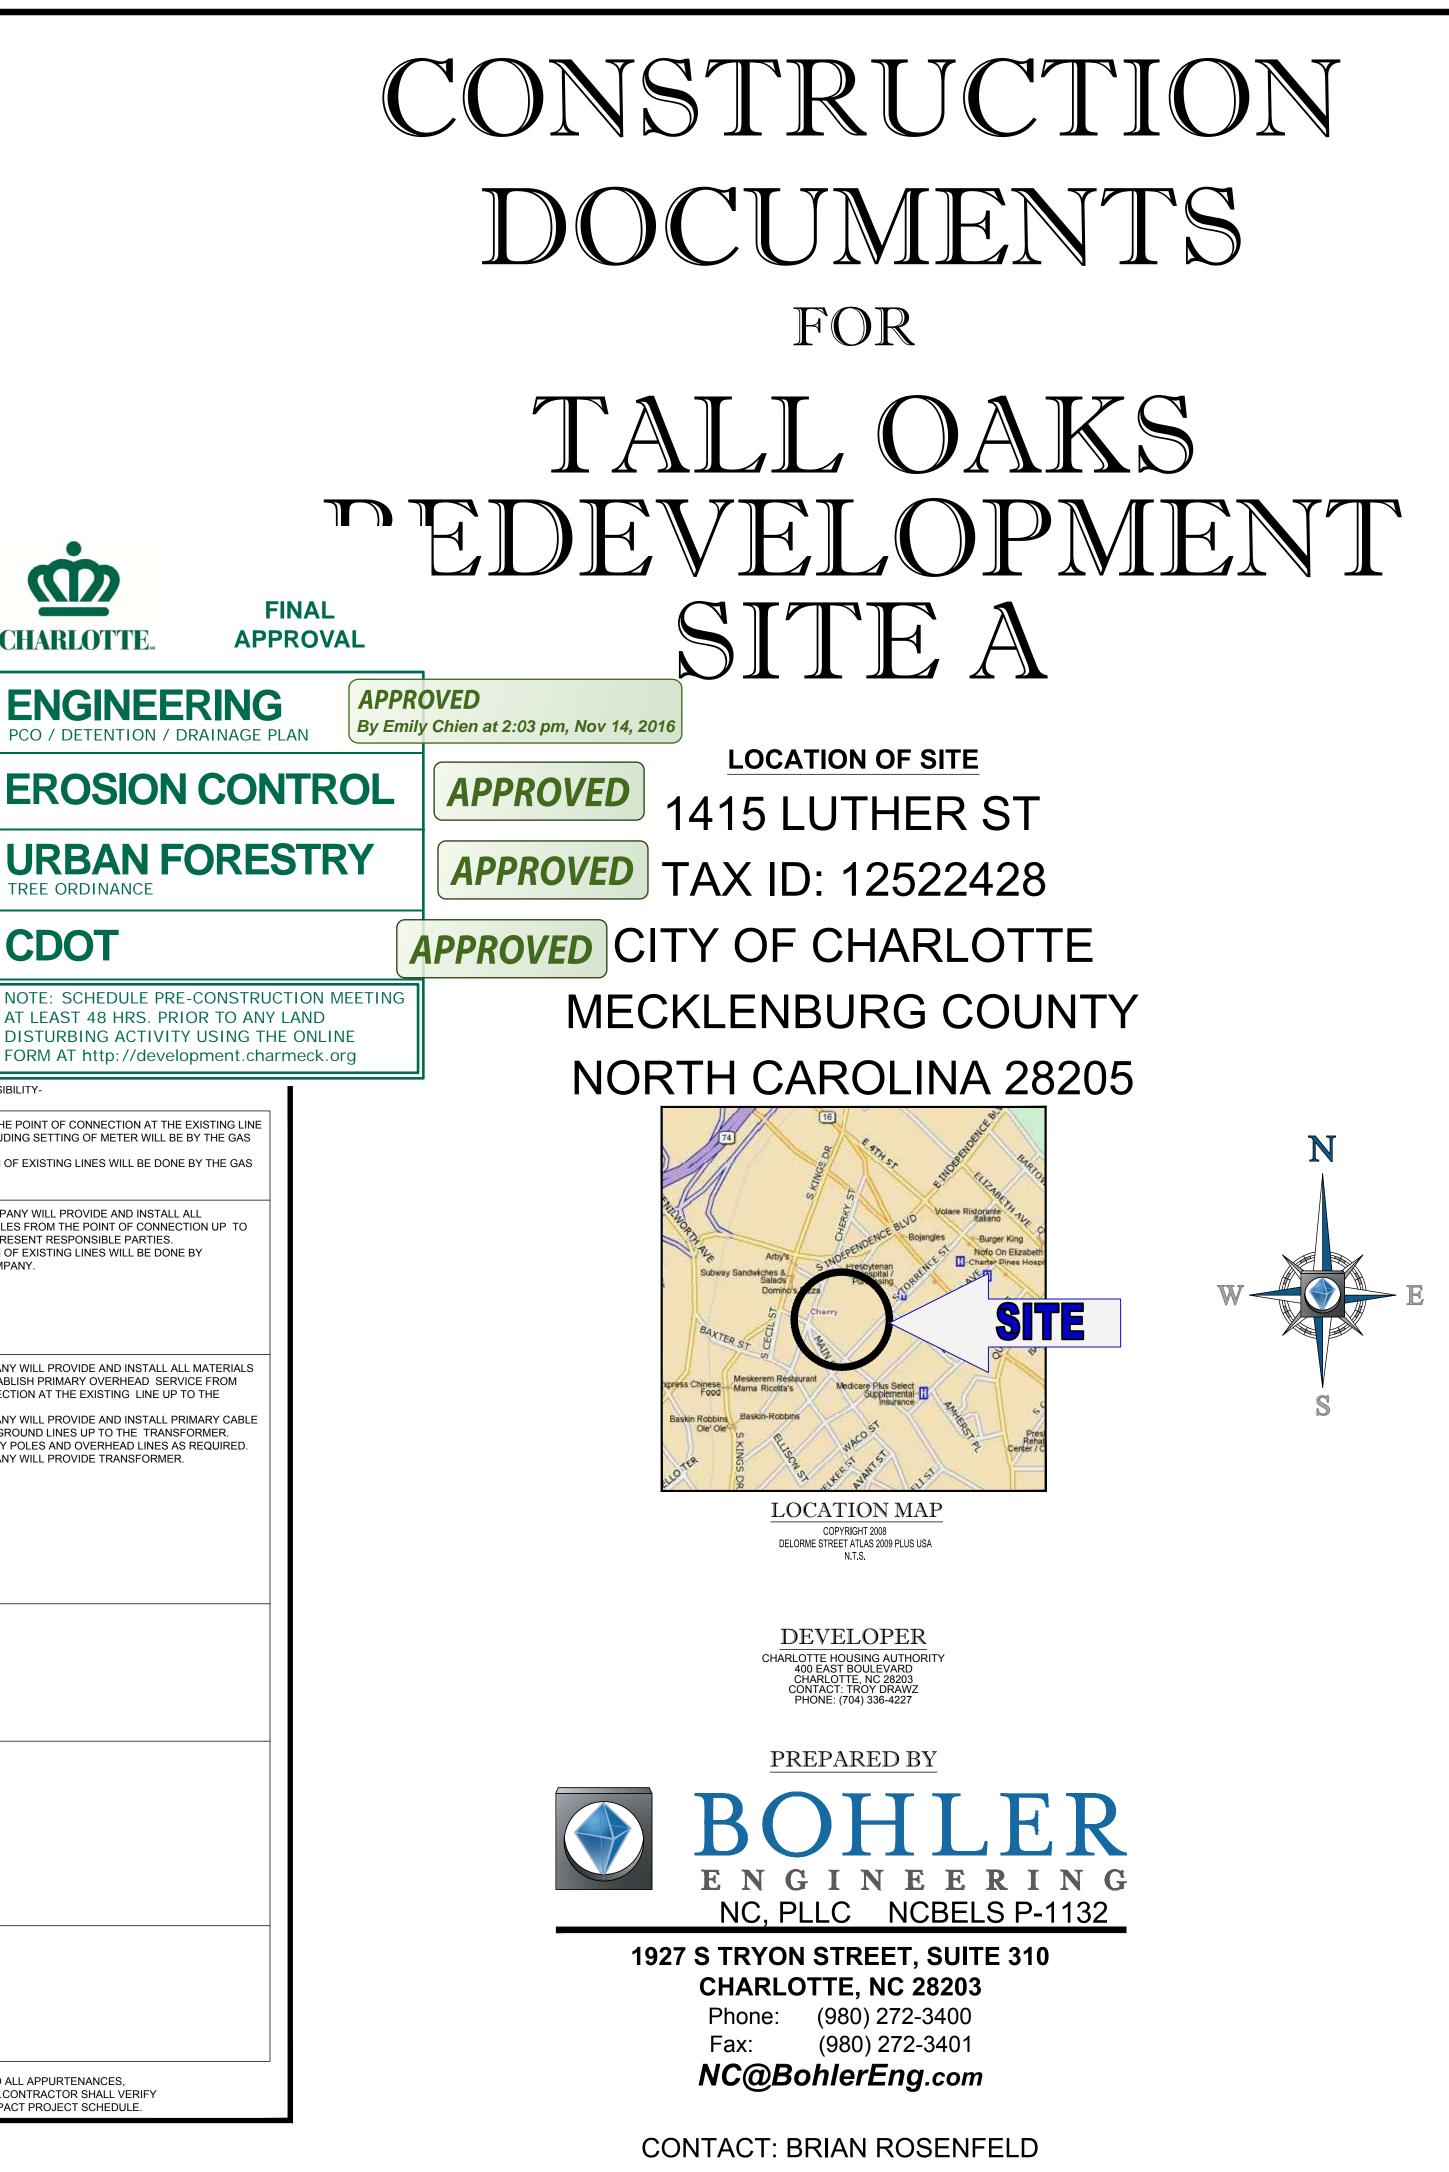

ORIGINAL PARCEL ID NUMBER(S):	12522428	
DEVELOPMENT TYPE:	MULTI-FAMILY	
SUBJECT TO PCCO? Y/N	Yes	
IF NO, WHY?		
WATERSHED:	CENTRAL CATAWBA	
DISTURBED AREA (AC) "A":	1.2152	
SITE AREA (AC) "A":	1.843	
SITE AREA (AC) "A2":	2.701	
	DA#1	
TOTAL ON-SITE DRAINAGE AREA (AC) "A":	1.4015	
EXISTING BUILT-UPON-AREA (SF) "A":	25556	
EXISTING BUA TO BE REMOVED (SF) "A":	25556	
EXISTING BUA TO REMAIN (SF) "A":	0	
PROPOSED NEW BUA (SF) "A":	36952.5	
PROPOSED % BUA "A":	52.00%	
DENSITY (HIGH / LOW)	HIGH	
TOTAL POST-PROJECT BUA FOR SITE "A":	36952.46	
DEVELOPMENT OR REDEVELOPMENT?	DEVELOPMENT	
NATURAL AREA REQUIRED (AC):	0.276	
NATURAL AREA PROVIDED, TOTAL (AC):	0.281	
UNDISTURBED TREED NATURAL AREA PRESERVED (AC):	0.281	
TOTAL STREAM BUFFER PROTECTED ON-SITE (AC):	0	
TRANSIT STATION AREA? Y/N	N	
DISTRESSED BUSINESS DISTRICT? Y/N	N	
MITIGATION TYPE (IF APPLICABLE)	N/A	
NATURAL AREA MITIGATION? Y/N	N	
BUFFER MITIGATION? Y/N	N	
TOTAL PHOSPHOROUS MITIGATION? Y/N	N	

# REFERENCES

TOPOGRAPHIC SURVEY CAROLINA SURVEYORS, INC "A BOUNDARY AND TOPOGRAPHICAL SURVEY SHOWING PROPERTY ON CHERRY STREET (NEAR THE INTERSECTION OF LUTHER STREET AND EAST 1ST STREET) SURVEYED FOR THE HOUSING AUTHORITY OF CHARLOTTE AREA: 4.681 ACRES CITY OF CHARLOTTE, MECKLENBURG COUNTY, NORTH CAROLINA " DATED: 12/12/14

♦ARCHITECTURAL PLAN: NEIGHBORING CONCEPTS ARCHITECTURE MIXED USE DEVELOPMENT "TALL OAKS REDEVELOPMENT" DATED 7/5/16 **REVISED 9/7/16** 

♦ GEOTECHNICAL REPORT REPORT OF PRELIMINARY GEOTECHNCIAL EXPLORATION TALL OAKS PROJECT CHERRY NEIGHBORHOOD CHARLOTTE, NORTH CAROLINA" DATED: 2/2/14

PROJECT NO.: 63S-0360

# AGENCIES

♦ CITY OF CHARLOTTE PLANNING ADDRESS: 600 E 4TH STREET, 8TH FLOOR CHARLOTTE, NC 28202 PHONE: (704)336-2205

♦ NORTH CAROLINA DEPARTMENT OF ENVIRONMENTAL QUALITY 610 E CENTER AVE #301 ADDRESS: MOORESVILLE, NC 28115 PHONE: (704)663-1699

### PRELIMINARY PLANNED MULTI-FAMILY SUBDIVISION APPROVAL CHARLOTTE-MECKLENBURG PLANNING DEPARTMENT By Brent Wilkinson 11/14/16

SHEET INDEX				
SHEET TITLE	SHEET NUMBER			
COVER SHEET	C-1			
GENERAL NOTES	C-2			
GENERAL NOTES AND LEGEND	C-3			
ALTA SURVEY	C-4			
EX. CONDITIONS/DEMOLITION PLAN	C-5			
SITE PLAN	C-6			
GRADING PLAN	C-7			
UTILITY PLAN	C-8			
EROSION CONTROL PLAN SITE A.1 PHASE 1	C-9			
EROSION CONTROL PLAN SITE A.2 PHASE 1	C-10			
EROSION CONTROL PHASE II	C-11			
PRE DEVELOPMENT DRAINAGE MAP	C-12			
POST DEVELOPMENT DRAINAGE MAP	C-13			
SITE DETAILS	C-14 - C-15			
UTILITY DETAILS	C-16			
STORMWATER DETAILS	C-17			
EROSION CONTROL DETAILS	C-18			
PHOTOMETRICS PLAN	C-19			
LANDSCAPING PLAN	L-1			
LANDSCAPING NOTES AND DETAILS	L-2 - L-3			

			NC, PILC       NC, PILC         SITE CIVIL AND CONSULTING ENGINEERING         LAND SURVEYING       PROGRAM MANAGEMENT         NEW ENGLAND       SOUTHEASTERN, PA         NEW VORK METRO       REHOBOTH BEACH, DE         NEW VORK METRO       REHOBOTH BEACH, DE         NEW JERSEY       BALTIMORE, MD         PHILADELPHIA, PA       SOUTHERN MARYLAND         PHILADELPHIA, PA       SOUTHERN MARYLAND	ПНЕ INFORMATION, DEBINON AND OCMTEMT OF THUR RI AN ARE PROPRIETARY AND \$WALL NOT BE ODDIED FOR ANY PURPOSE WITHOUT PROPA WRITTEN AUTHORAZATION FROM \$DDILER ENGINEERING, ONLY APPROVED, \$600ED AND \$604ED RI AN\$ \$640ED RU OR USED FOR ODNYTRUCTION PROVES (\$ 2009 \$004EBR ENGINEERING).			
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	3	7/21/16	CYCLE 1 CODE COMMENTS	SRF			
	4	8/4/16	INTERACTIVE REVIEW	SRF			
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	5	9/14/16	2ND SUBMITTAL	SRF			
	6	10/4/16	INTERACTIVE REVIEW	SRF			
	7	10/18/16	CYCLE 3 CODE COMMENTS	SRF			
	8	10/27/16	LAND DEVELOPMENT 3RD SUBMITTAL	SRF			
	9	11/3/16	URBAN FORESTRY	SRF			
	10	11/9/16	COMMENTS LAND DEVELOPMENT	SRF			
1	10	11/9/10	4TH SUBMITTAL	SKI			
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	CALL BEFORE YOU DIG 1-800-632-4949 NORTH CAROLINA ITS THE LAW						
	PROJECT No.:NCC152097DRAWN BY:SRFCHECKED BY:BWRDATE:6/23/16SCALE:AS NOTEDCAD ID:SD0						
	PROJECT: TALL OAKS REDEVELOPMENT SITE A FOR NEIGHBORING CONCEPTS LOCATION OF SITE 1415 LUTHER ST CITY OF CHARLOTTE, MECKLENBURG COUNTY, NORTH CAROLINA 28205						
	Image: Second system       Second						
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	SHEET TITLE: COVER SHEET SHEET NUMBER:						

