

704/332-1204

WASSOCIATES!

Project Number

07038.6


HEET 1 OF 10 TOTA


LANCASTER, SC 29720


PHONE: 803-286-1134

MECKLENBURG COUNTY, NORTH CAROLINA

Drawn By Checked By CG/HVN 6/03/08 Project Number 07038.6

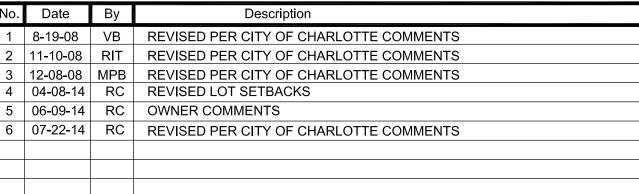

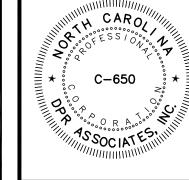

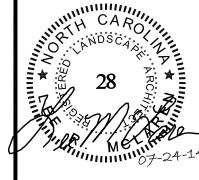



Planners & Engineers 420 Hawthorne Lane	Landscape Architects				
420 Hawthorne Lane	Planners & Engineers				
	420 Hawthorne Lane				
Charlotte, NC 28204	Charlotte, NC 28204				

SITE PLAN

SINGLE FAMILY

MECKLENBURG COUNTY, NORTH CAROLINA

KINGSTREE - PH 4


THE MULVANEY GROUP, LTD PO BOX 836 LANCASTER, SC 29721 (309 N MAIN STREET LANCASTER, SC 29720

PHONE: 803-286-1134

HEET 2 OF 10 TOTA

1" = 60'

Sheet Number

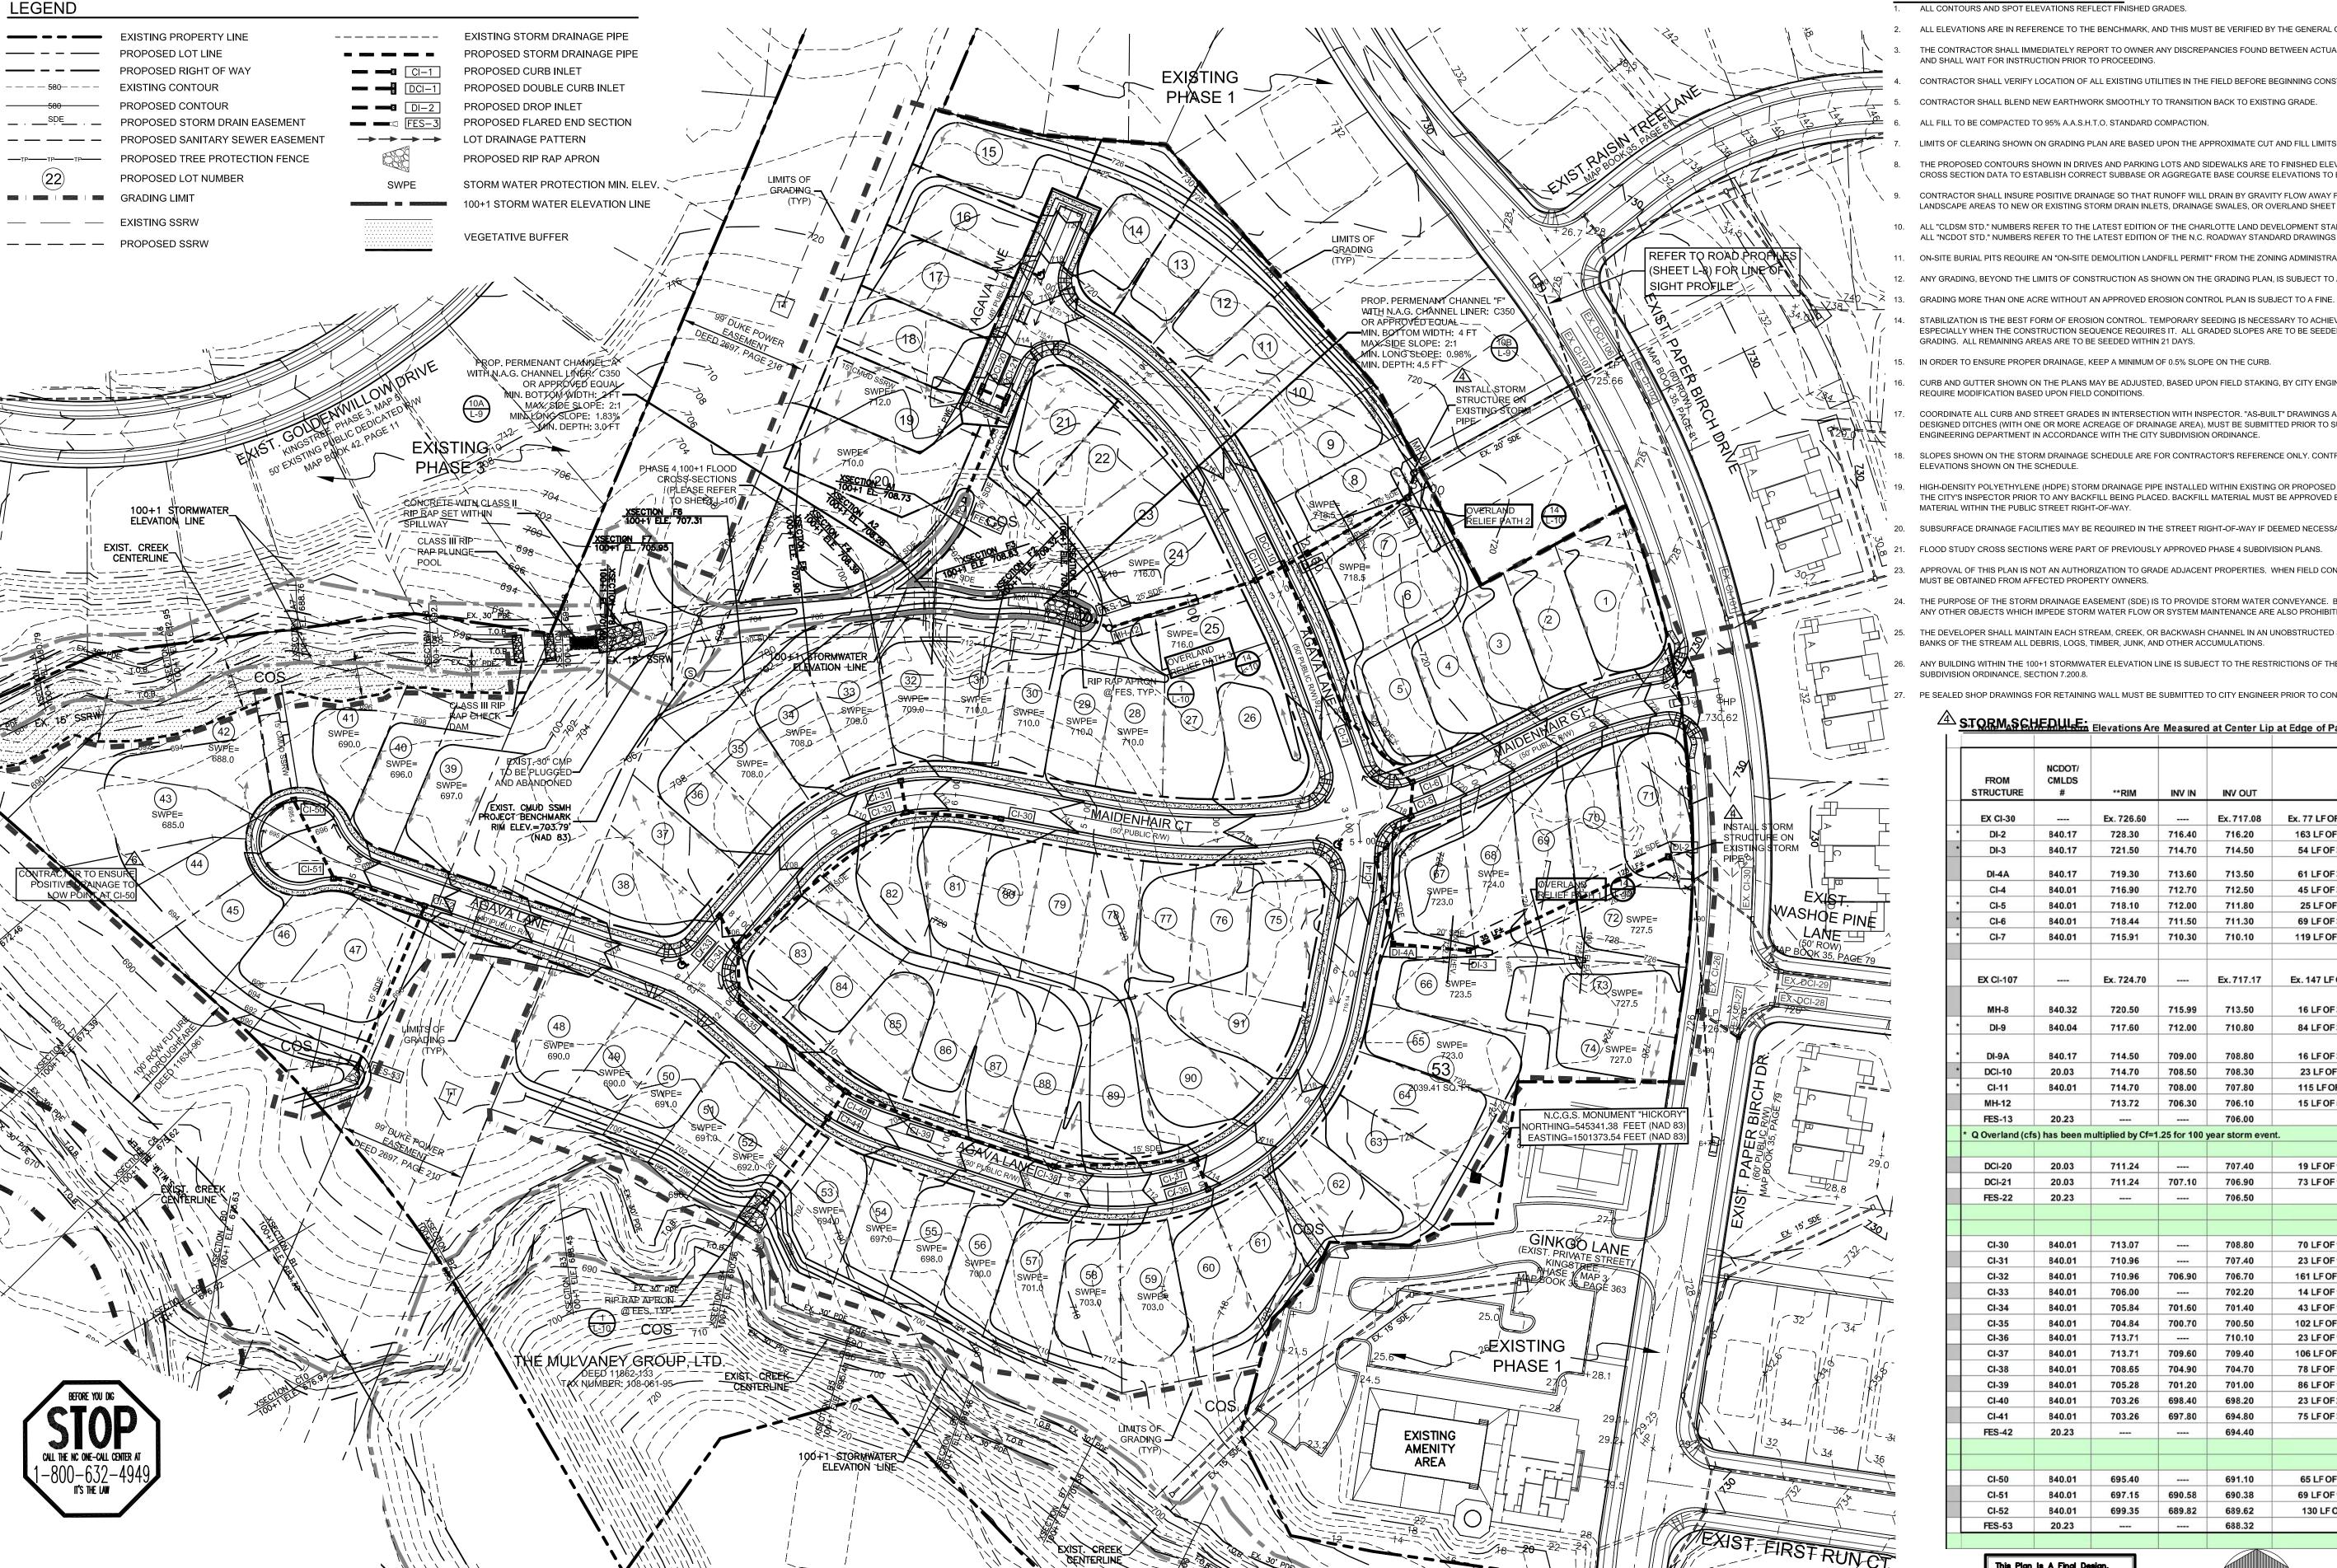

- ALL ELEVATIONS ARE IN REFERENCE TO THE BENCHMARK, AND THIS MUST BE VERIFIED BY THE GENERAL CONTRACTOR PRIOR TO GROUND BREAKING.
- THE CONTRACTOR SHALL IMMEDIATELY REPORT TO OWNER ANY DISCREPANCIES FOUND BETWEEN ACTUAL FIELD CONDITIONS AND CONSTRUCTION DOCUMENTS AND SHALL WAIT FOR INSTRUCTION PRIOR TO PROCEEDING.
- CONTRACTOR SHALL VERIFY LOCATION OF ALL EXISTING UTILITIES IN THE FIELD BEFORE BEGINNING CONSTRUCTION.
- CONTRACTOR SHALL BLEND NEW EARTHWORK SMOOTHLY TO TRANSITION BACK TO EXISTING GRADE.
- ALL FILL TO BE COMPACTED TO 95% A.A.S.H.T.O. STANDARD COMPACTION.

GRADING & STORM DRAINAGE NOTES:


- LIMITS OF CLEARING SHOWN ON GRADING PLAN ARE BASED UPON THE APPROXIMATE CUT AND FILL LIMITS, OR OTHER GRADING REQUIREMENTS.
- THE PROPOSED CONTOURS SHOWN IN DRIVES AND PARKING LOTS AND SIDEWALKS ARE TO FINISHED ELEVATIONS (TOP OF PAVEMENT). REFER TO PAVEMENT CROSS SECTION DATA TO ESTABLISH CORRECT SUBBASE OR AGGREGATE BASE COURSE ELEVATIONS TO BE COMPLETED UNDER THIS CONTRACT.
- CONTRACTOR SHALL INSURE POSITIVE DRAINAGE SO THAT RUNOFF WILL DRAIN BY GRAVITY FLOW AWAY FROM BUIDLING(S) AND ACROSS NEW PAVEMENT AND/OR LANDSCAPE AREAS TO NEW OR EXISTING STORM DRAIN INLETS, DRAINAGE SWALES, OR OVERLAND SHEET FLOW.
- ALL "CLDSM STD." NUMBERS REFER TO THE LATEST EDITION OF THE CHARLOTTE LAND DEVELOPMENT STANDARDS MANUAL. ALL "NCDOT STD." NUMBERS REFER TO THE LATEST EDITION OF THE N.C. ROADWAY STANDARD DRAWINGS MANUAL.
- 11. ON-SITE BURIAL PITS REQUIRE AN "ON-SITE DEMOLITION LANDFILL PERMIT" FROM THE ZONING ADMINISTRATOR.
- 12. ANY GRADING, BEYOND THE LIMITS OF CONSTRUCTION AS SHOWN ON THE GRADING PLAN, IS SUBJECT TO A FINE.
- STABILIZATION IS THE BEST FORM OF EROSION CONTROL. TEMPORARY SEEDING IS NECESSARY TO ACHIEVE EROSION CONTROL ON DENUDED AREAS AND ESPECIALLY WHEN THE CONSTRUCTION SEQUENCE REQUIRES IT. ALL GRADED SLOPES ARE TO BE SEEDED OR LANDSCAPED WITHIN 21 DAYS OF COMPLETION OF
- GRADING. ALL REMAINING AREAS ARE TO BE SEEDED WITHIN 21 DAYS.
- CURB AND GUTTER SHOWN ON THE PLANS MAY BE ADJUSTED, BASED UPON FIELD STAKING, BY CITY ENGINEERING. ASSOCIATED STORM DRAINAGE MAY ALSO REQUIRE MODIFICATION BASED UPON FIELD CONDITIONS.
- COORDINATE ALL CURB AND STREET GRADES IN INTERSECTION WITH INSPECTOR. "AS-BUILT" DRAWINGS AND PLANS OF THE STORM DRAINAGE SYSTEM, INCLUDING DESIGNED DITCHES (WITH ONE OR MORE ACREAGE OF DRAINAGE AREA), MUST BE SUBMITTED PRIOR TO SUBDIVISION FINAL INSPECTION TO THE CITY
- ENGINEERING DEPARTMENT IN ACCORDANCE WITH THE CITY SUBDIVISION ORDINANCE. SLOPES SHOWN ON THE STORM DRAINAGE SCHEDULE ARE FOR CONTRACTOR'S REFERENCE ONLY. CONTRACTOR TO BUILD STORM DRAINAGE SYSTEM TO THE
- HIGH-DENSITY POLYETHYLENE (HDPE) STORM DRAINAGE PIPE INSTALLED WITHIN EXISTING OR PROPOSED PUBLIC STREET RIGHT-OF-WAY MUST BE APPROVED BY THE CITY'S INSPECTOR PRIOR TO ANY BACKFILL BEING PLACED. BACKFILL MATERIAL MUST BE APPROVED BY THE CITY INSPECTOR PRIOR TO PLACEMENT OF THE MATERIAL WITHIN THE PUBLIC STREET RIGHT-OF-WAY.
- SUBSURFACE DRAINAGE FACILITIES MAY BE REQUIRED IN THE STREET RIGHT-OF-WAY IF DEEMED NECESSARY BY THE INSPECTOR.
- FLOOD STUDY CROSS SECTIONS WERE PART OF PREVIOUSLY APPROVED PHASE 4 SUBDIVISION PLANS.
- APPROVAL OF THIS PLAN IS NOT AN AUTHORIZATION TO GRADE ADJACENT PROPERTIES. WHEN FIELD CONDITIONS WARRANT OFF-SITE GRADING, PERMISSION MUST BE OBTAINED FROM AFFECTED PROPERTY OWNERS.
- THE PURPOSE OF THE STORM DRAINAGE EASEMENT (SDE) IS TO PROVIDE STORM WATER CONVEYANCE. BUILDINGS ARE NOT PERMITTED IN THE EASEMENT AREA. ANY OTHER OBJECTS WHICH IMPEDE STORM WATER FLOW OR SYSTEM MAINTENANCE ARE ALSO PROHIBITED.
- THE DEVELOPER SHALL MAINTAIN EACH STREAM, CREEK, OR BACKWASH CHANNEL IN AN UNOBSTRUCTED STATE AND SHALL REMOVE FROM THE CHANNEL AND
- BANKS OF THE STREAM ALL DEBRIS, LOGS, TIMBER, JUNK, AND OTHER ACCUMULATIONS. ANY BUILDING WITHIN THE 100+1 STORMWATER ELEVATION LINE IS SUBJECT TO THE RESTRICTIONS OF THE (CITY OF CHARLOTTE/MECKLENBURG COUNTY)
- SUBDIVISION ORDINANCE, SECTION 7.200.8.
- PE SEALED SHOP DRAWINGS FOR RETAINING WALL MUST BE SUBMITTED TO CITY ENGINEER PRIOR TO CONSTRUCTION.


	FROM STRUCTURE	NCDOT/ CMLDS #	**RIM	INV IN	INV OUT	PIPE	TO STRUCTURE	Remarks
	EX CI-30		Ex. 726.60		Ex. 717.08	Ex. 77 LFOF 36 in @ 0.880%	DI-2	Ex. 36" RCP to Rema (Phase 1)
*	DI-2	840.17	728.30	716.40	716.20	163 LF OF 36 in @ 0.92%	DI-3	RCP
*	DI-3	B40.17	721.50	714.70	714.50	54 LF OF 36 in @ 1.67%	DI-4A	RCP
	DI-4A	840.17	719.30	713.60	713.50	61 LFOF36 in @ 1.31%	CI-4	100-YR OVERLAND, R
	CI-4	840.01	716.90	712.70	712.50	45 LF OF 36 in @ 1.11%	CI-5	RCP, CLASS IV
*	CI-5	840.01	718.10	712.00	711.80	25 LF OF 36 in @ 1.2%	CI-6	RCP
*	CI-6	840.01	718.44	711.50	711.30	69 LF OF 36 in @ 1.45%	CI-7	RCP
*	CI-7	840.01	715.91	710.30	710.10	119 LF OF 36 in @ 1.34%	DCI-10	RCP
	EX CI-107		Ex. 724.70		Ex.717.17	Ex. 147 LF OF 36 in @ 0.8%	MH-8	Ex. 36" RCP to Rema (Phase 1)
	MUO	840.00	700 50	745.00	742.50	46 50536 :- @ 0.309/	DI O	RCP, remove ex. FES a
	MH-8	840.32	720.50	715.99	713.50	16 LFOF36 in @ 9.38%	DI-9	construct MH
*	DI-9	840.04	717.60	712.00	710.80	84 LFOF36 in @ 2.14%	DI-9A	RCP
*	DI-9A	840.17	714.50	709.00	708.80	16 LF OF 36 in @ 1.87%	DCI-10	100-YR OVERLAND, RO
*	DCI-10	20.03	714.70	708.50	708.30	23 LF OF 48 in @ 1.3%	CI-11	RCP
*	CI-11	840.01	714.70	708.00	707.80	115 LF OF 48 in @ 1.3%	MH-12	RCP
	MH-12		713.72	706.30	706.10	15 LF OF 54 in @ 0.67%	FES-13	
	FES-13	20.23			706.00			
	* Q Overland (cf	s) has been m		.25 for 100	year storm ever	1t.		
	DCI-20	20.03	711.24		707.40	19 LF OF 15 in @ 1.58%	DCI-21	RCP
	DCI-21	20.03	711.24	707.10	706.90	73 LFOF18 in @ 0.55%	FES-22	RCP
	FES-22	20.23			706.50			TI.
		840.01	713.07		708.80	70 LF OF 15 in @ 2.71%	CI-32	RCP
	CI-30	040.01			707.40		12000000	RCP
	Market No.	D. Wat alles	710.96		101.70	23 LF OF 15 in @ 2.17%	CI-32	KCP
	CI-31	840.01	710.96 710.96	CONTRACTOR MOSCOLA	706.70	23 LF OF 15 in @ 2.17% 161 LF OF 15 in @ 3.17%	CI-32 CI-34	RCP
	Market No.	840.01 840.01	710.96	706.90	706.70	161 LF OF 15 in @ 3.17%	CI-32 CI-34 CI-34	
	CI-31 CI-32	840.01 840.01 840.01		706.90	706.70 702.20	ACTION OF THE PROPERTY OF THE	CI-34	RCP
	CI-31 CI-32 CI-33	840.01 840.01 840.01 840.01	710.96 706.00 705.84	706.90 701.60	706.70 702.20 701.40	161 LF OF 15 in @ 3.17% 14 LF OF 15 in @ 4.29% 43 LF OF 15 in @ 1.63%	CI-34 CI-34	RCP RCP
	CI-31 CI-32 CI-33 CI-34	840.01 840.01 840.01	710.96 706.00	706.90	706.70 702.20	161 LF OF 15 in @ 3.17% 14 LF OF 15 in @ 4.29%	CI-34 CI-34 CI-35	RCP RCP RCP
	CI-31 CI-32 CI-33 CI-34 CI-35	840.01 840.01 840.01 840.01 840.01	710.96 706.00 705.84 704.84	706.90 701.60 700.70	706.70 702.20 701.40 700.50	161 LF OF 15 in @ 3.17% 14 LF OF 15 in @ 4.29% 43 LF OF 15 in @ 1.63% 102 LF OF 15 in @ 2.06%	CI-34 CI-34 CI-35 CI-40	RCP RCP RCP RCP
	CI-31 CI-32 CI-33 CI-34 CI-35 CI-36	840.01 840.01 840.01 840.01 840.01 840.01	710.96 706.00 705.84 704.84 713.71	706.90 701.60 700.70	706.70 702.20 701.40 700.50 710.10	161 LF OF 15 in @ 3.17% 14 LF OF 15 in @ 4.29% 43 LF OF 15 in @ 1.63% 102 LF OF 15 in @ 2.06% 23 LF OF 15 in @ 2.17%	CI-34 CI-34 CI-35 CI-40 CI-37	RCP RCP RCP RCP RCP
	CI-31 CI-32 CI-33 CI-34 CI-35 CI-36 CI-37	840.01 840.01 840.01 840.01 840.01 840.01	710.96 706.00 705.84 704.84 713.71 713.71	706.90 701.60 700.70 709.60	706.70 702.20 701.40 700.50 710.10 709.40	161 LF OF 15 in @ 3.17% 14 LF OF 15 in @ 4.29% 43 LF OF 15 in @ 1.63% 102 LF OF 15 in @ 2.06% 23 LF OF 15 in @ 2.17% 106 LF OF 15 in @ 4.25%	CI-34 CI-34 CI-35 CI-40 CI-37 CI-38	RCP RCP RCP RCP RCP
	CI-31 CI-32 CI-33 CI-34 CI-35 CI-36 CI-37	840.01 840.01 840.01 840.01 840.01 840.01 840.01	710.96 706.00 705.84 704.84 713.71 713.71 708.65	706.90 701.60 700.70 709.60 704.90	706.70 702.20 701.40 700.50 710.10 709.40 704.70	161 LF OF 15 in @ 3.17% 14 LF OF 15 in @ 4.29% 43 LF OF 15 in @ 1.63% 102 LF OF 15 in @ 2.06% 23 LF OF 15 in @ 2.17% 106 LF OF 15 in @ 4.25% 78 LF OF 15 in @ 4.49%	CI-34 CI-34 CI-35 CI-40 CI-37 CI-38 CI-39	RCP RCP RCP RCP RCP RCP RCP
	CI-31 CI-32 CI-33 CI-34 CI-35 CI-36 CI-37 CI-38 CI-39	840.01 840.01 840.01 840.01 840.01 840.01 840.01 840.01	710.96 706.00 705.84 704.84 713.71 713.71 708.65 705.28	706.90 701.60 700.70 709.60 704.90 701.20	706.70 702.20 701.40 700.50 710.10 709.40 704.70 701.00	161 LF OF 15 in @ 3.17% 14 LF OF 15 in @ 4.29% 43 LF OF 15 in @ 1.63% 102 LF OF 15 in @ 2.06% 23 LF OF 15 in @ 2.17% 106 LF OF 15 in @ 4.25% 78 LF OF 15 in @ 4.49% 86 LF OF 15 in @ 3.02%	CI-34 CI-34 CI-35 CI-40 CI-37 CI-38 CI-39 CI-40	RCP RCP RCP RCP RCP RCP RCP RCP
	CI-31 CI-32 CI-33 CI-34 CI-35 CI-36 CI-37 CI-38 CI-39 CI-40	840.01 840.01 840.01 840.01 840.01 840.01 840.01 840.01 840.01	710.96 706.00 705.84 704.84 713.71 713.71 708.65 705.28 703.26	706.90 701.60 700.70 709.60 704.90 701.20 698.40	706.70 702.20 701.40 700.50 710.10 709.40 704.70 701.00 698.20	161 LF OF 15 in @ 3.17% 14 LF OF 15 in @ 4.29% 43 LF OF 15 in @ 1.63% 102 LF OF 15 in @ 2.06% 23 LF OF 15 in @ 2.17% 106 LF OF 15 in @ 4.25% 78 LF OF 15 in @ 4.49% 86 LF OF 15 in @ 3.02% 23 LF OF 24 in @ 1.74%	CI-34 CI-34 CI-35 CI-40 CI-37 CI-38 CI-39 CI-40 CI-41	RCP
	CI-31 CI-32 CI-33 CI-34 CI-35 CI-36 CI-37 CI-38 CI-39 CI-40 CI-41	840.01 840.01 840.01 840.01 840.01 840.01 840.01 840.01 840.01 840.01	710.96 706.00 705.84 704.84 713.71 713.71 708.65 705.28 703.26 703.26	706.90 701.60 700.70 709.60 704.90 701.20 698.40 697.80	706.70 702.20 701.40 700.50 710.10 709.40 704.70 701.00 698.20 694.80	161 LF OF 15 in @ 3.17% 14 LF OF 15 in @ 4.29% 43 LF OF 15 in @ 1.63% 102 LF OF 15 in @ 2.06% 23 LF OF 15 in @ 2.17% 106 LF OF 15 in @ 4.25% 78 LF OF 15 in @ 4.49% 86 LF OF 15 in @ 3.02% 23 LF OF 24 in @ 1.74%	CI-34 CI-34 CI-35 CI-40 CI-37 CI-38 CI-39 CI-40 CI-41	RCP
	CI-31 CI-32 CI-33 CI-34 CI-35 CI-36 CI-37 CI-38 CI-39 CI-40 CI-41	840.01 840.01 840.01 840.01 840.01 840.01 840.01 840.01 840.01 840.01	710.96 706.00 705.84 704.84 713.71 713.71 708.65 705.28 703.26 703.26	706.90 701.60 700.70 709.60 704.90 701.20 698.40 697.80	706.70 702.20 701.40 700.50 710.10 709.40 704.70 701.00 698.20 694.80	161 LF OF 15 in @ 3.17% 14 LF OF 15 in @ 4.29% 43 LF OF 15 in @ 1.63% 102 LF OF 15 in @ 2.06% 23 LF OF 15 in @ 2.17% 106 LF OF 15 in @ 4.25% 78 LF OF 15 in @ 4.49% 86 LF OF 15 in @ 3.02% 23 LF OF 24 in @ 1.74%	CI-34 CI-34 CI-35 CI-40 CI-37 CI-38 CI-39 CI-40 CI-41	RCP
	CI-31 CI-32 CI-33 CI-34 CI-35 CI-36 CI-37 CI-38 CI-39 CI-40 CI-41 FES-42	840.01 840.01 840.01 840.01 840.01 840.01 840.01 840.01 840.01 840.01 20.23	710.96 706.00 705.84 704.84 713.71 713.71 708.65 705.28 703.26 703.26	706.90 701.60 700.70 709.60 704.90 701.20 698.40 697.80	706.70 702.20 701.40 700.50 710.10 709.40 704.70 701.00 698.20 694.80 694.40	161 LF OF 15 in @ 3.17% 14 LF OF 15 in @ 4.29% 43 LF OF 15 in @ 1.63% 102 LF OF 15 in @ 2.06% 23 LF OF 15 in @ 2.17% 106 LF OF 15 in @ 4.25% 78 LF OF 15 in @ 4.49% 86 LF OF 15 in @ 3.02% 23 LF OF 24 in @ 1.74% 75 LF OF 30 in @ 0.53%	CI-34 CI-34 CI-35 CI-40 CI-37 CI-38 CI-39 CI-40 CI-41 FES-42	RCP
	CI-31 CI-32 CI-33 CI-34 CI-35 CI-36 CI-37 CI-38 CI-39 CI-40 CI-41 FES-42 CI-50	840.01 840.01 840.01 840.01 840.01 840.01 840.01 840.01 840.01 20.23	710.96 706.00 705.84 704.84 713.71 713.71 708.65 705.28 703.26 703.26 	706.90 701.60 700.70 709.60 704.90 701.20 698.40 697.80	706.70 702.20 701.40 700.50 710.10 709.40 704.70 701.00 698.20 694.80 694.40	161 LF OF 15 in @ 3.17% 14 LF OF 15 in @ 4.29% 43 LF OF 15 in @ 1.63% 102 LF OF 15 in @ 2.06% 23 LF OF 15 in @ 2.17% 106 LF OF 15 in @ 4.25% 78 LF OF 15 in @ 4.49% 86 LF OF 15 in @ 3.02% 23 LF OF 24 in @ 1.74% 75 LF OF 30 in @ 0.53%	CI-34 CI-34 CI-35 CI-40 CI-37 CI-38 CI-39 CI-40 CI-41 FES-42	RCP

Project Manager
HVN
Drawn By
VPB
Checked By
CG/HVN
Date
6/03/08
Project Number

07038.6

	R	EVISIONS:		
1	No	Date	Ву	Description
l	1	8-19-08	RIT	REVISED PER CITY OF CHARLOTTE COMMENTS
	2	11-10-08	RIT	REVISED PER CITY OF CHARLOTTE COMMENTS
	3	12-08-08	MPB	REVISED PER CITY OF CHARLOTTE COMMENTS
ı	4	04-08-14	RC	REVISED BASIN #1 AND #2
l	5	06-09-14	RC	OWNER COMMENTS
ı	6	07-22-14	RC	REVISED PER CITY OF CHARLOTTE COMMENTS
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	DPR ASSOCIATES			
	Landscape Architects			
	Planners & Engineers			
DESIGN·PLANNING·RESEARCH	420 Hawthorne Lane			
	Charlotte, NC 28204			
	704/332-1204			

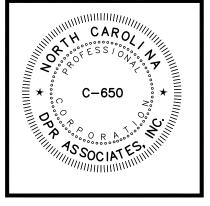GRADING AND STORM DRAINAGE PLAN

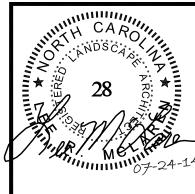KINGSTREE - PH 4 SINGLE FAMILY MECKLENBURG COUNTY, NORTH CAROLINA THE MULVANEY GROUP, LTD PO BOX 836 LANCASTER, SC 29721 (309 N MAIN STREET) LANCASTER, SC 29720 PHONE: 803-286-1134

Sheet Number SHEET 3 OF 10 TOTA

1" = 60'