




NOTE

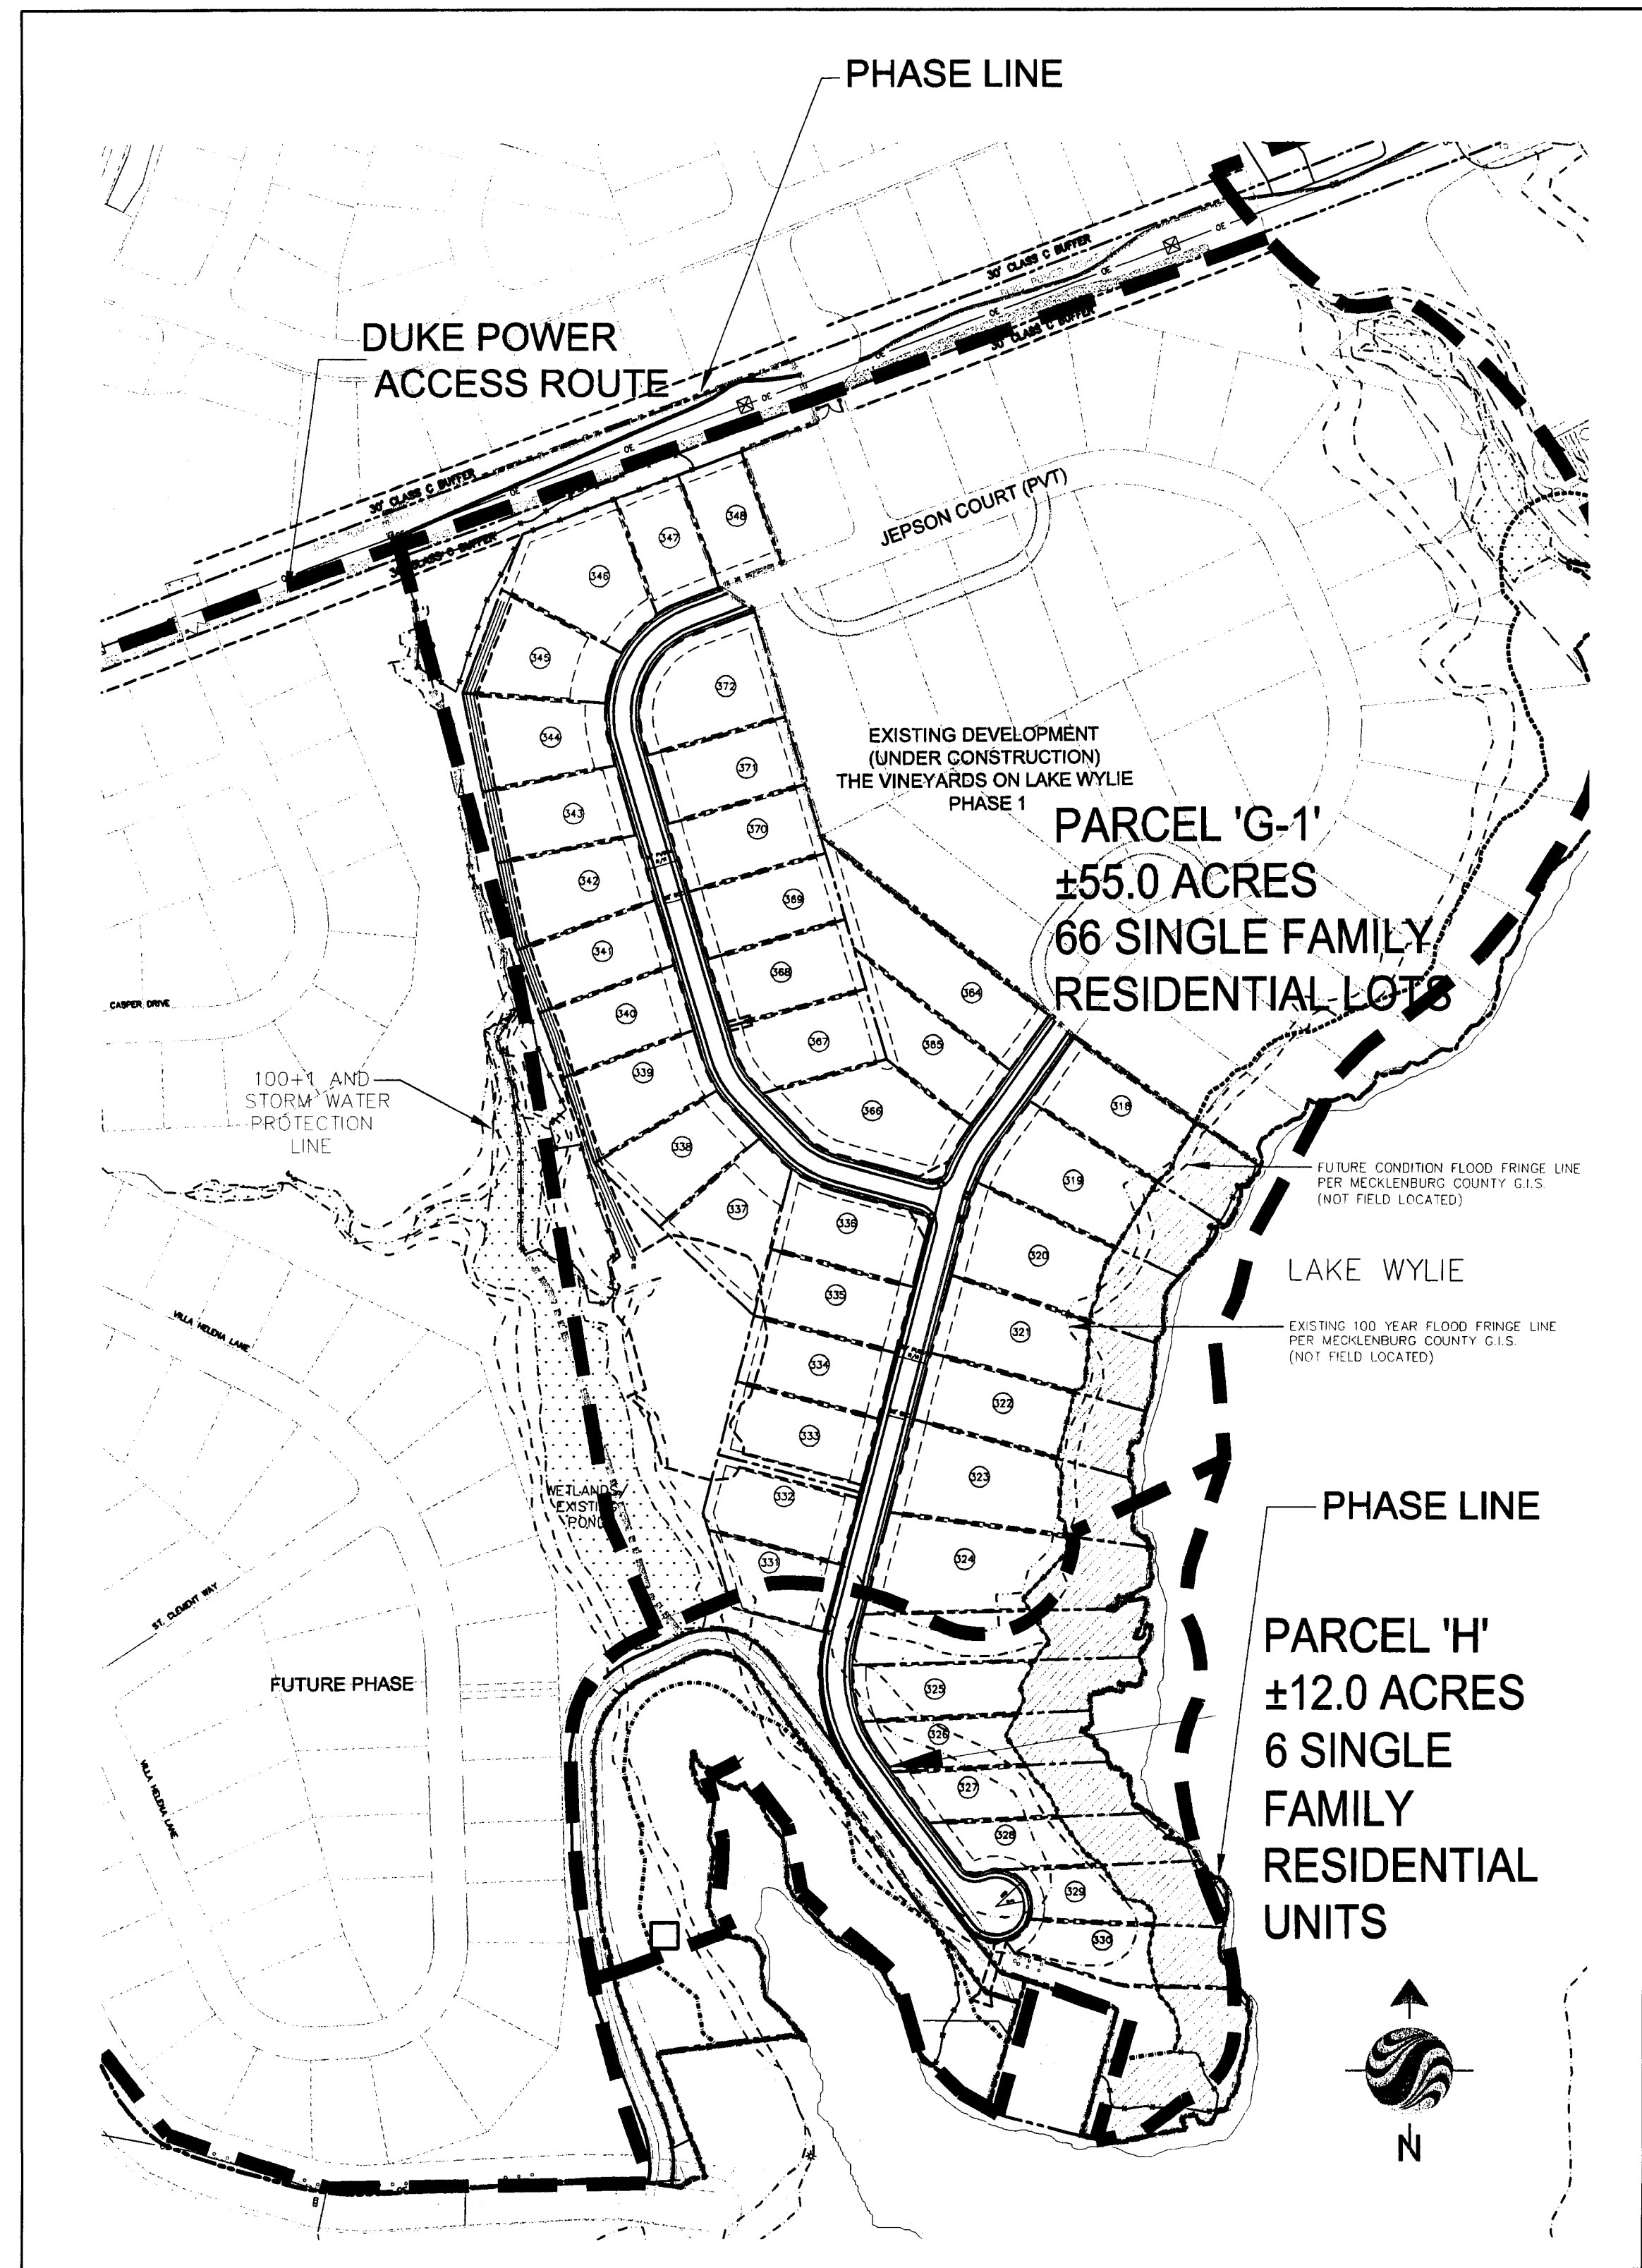

PHASE 2 SOUTH (RESIDENTIAL)

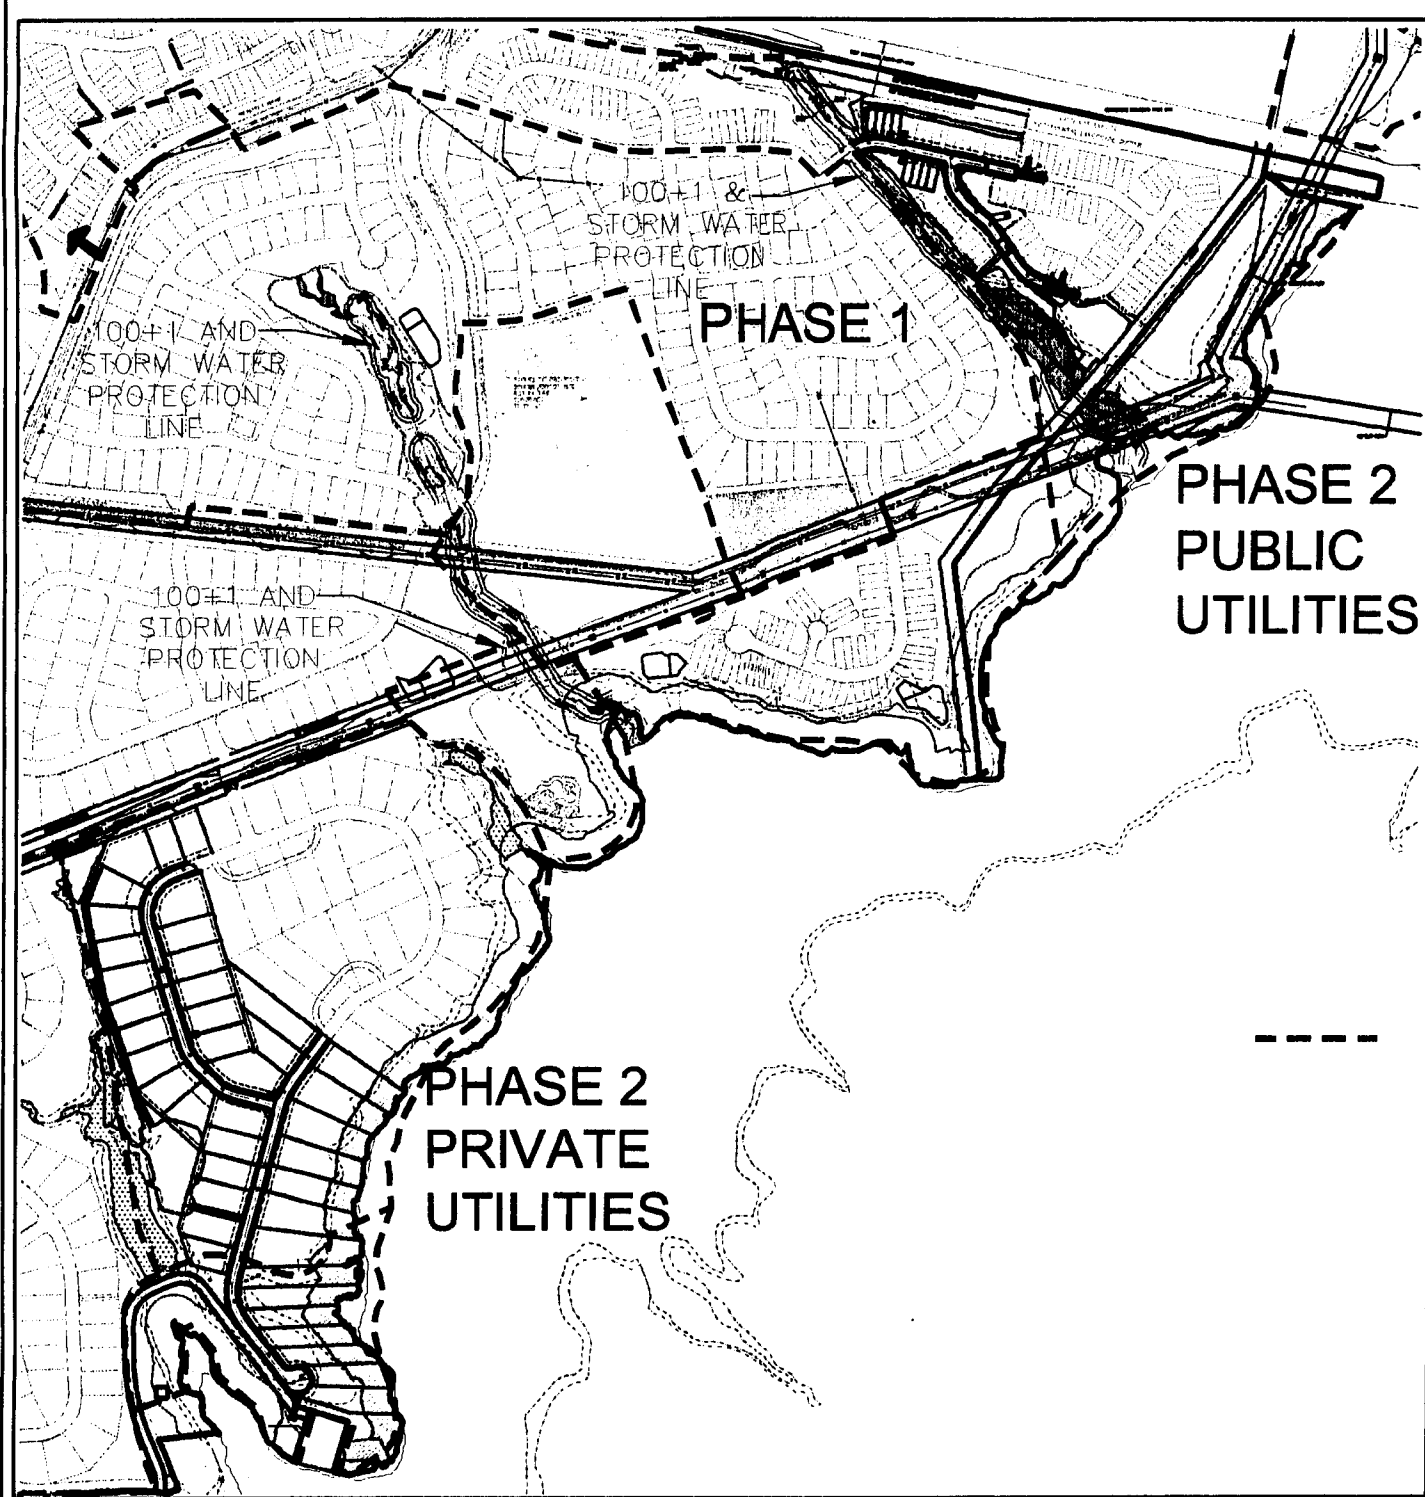

PHASE 2 NORTH (COMMERCIAL)

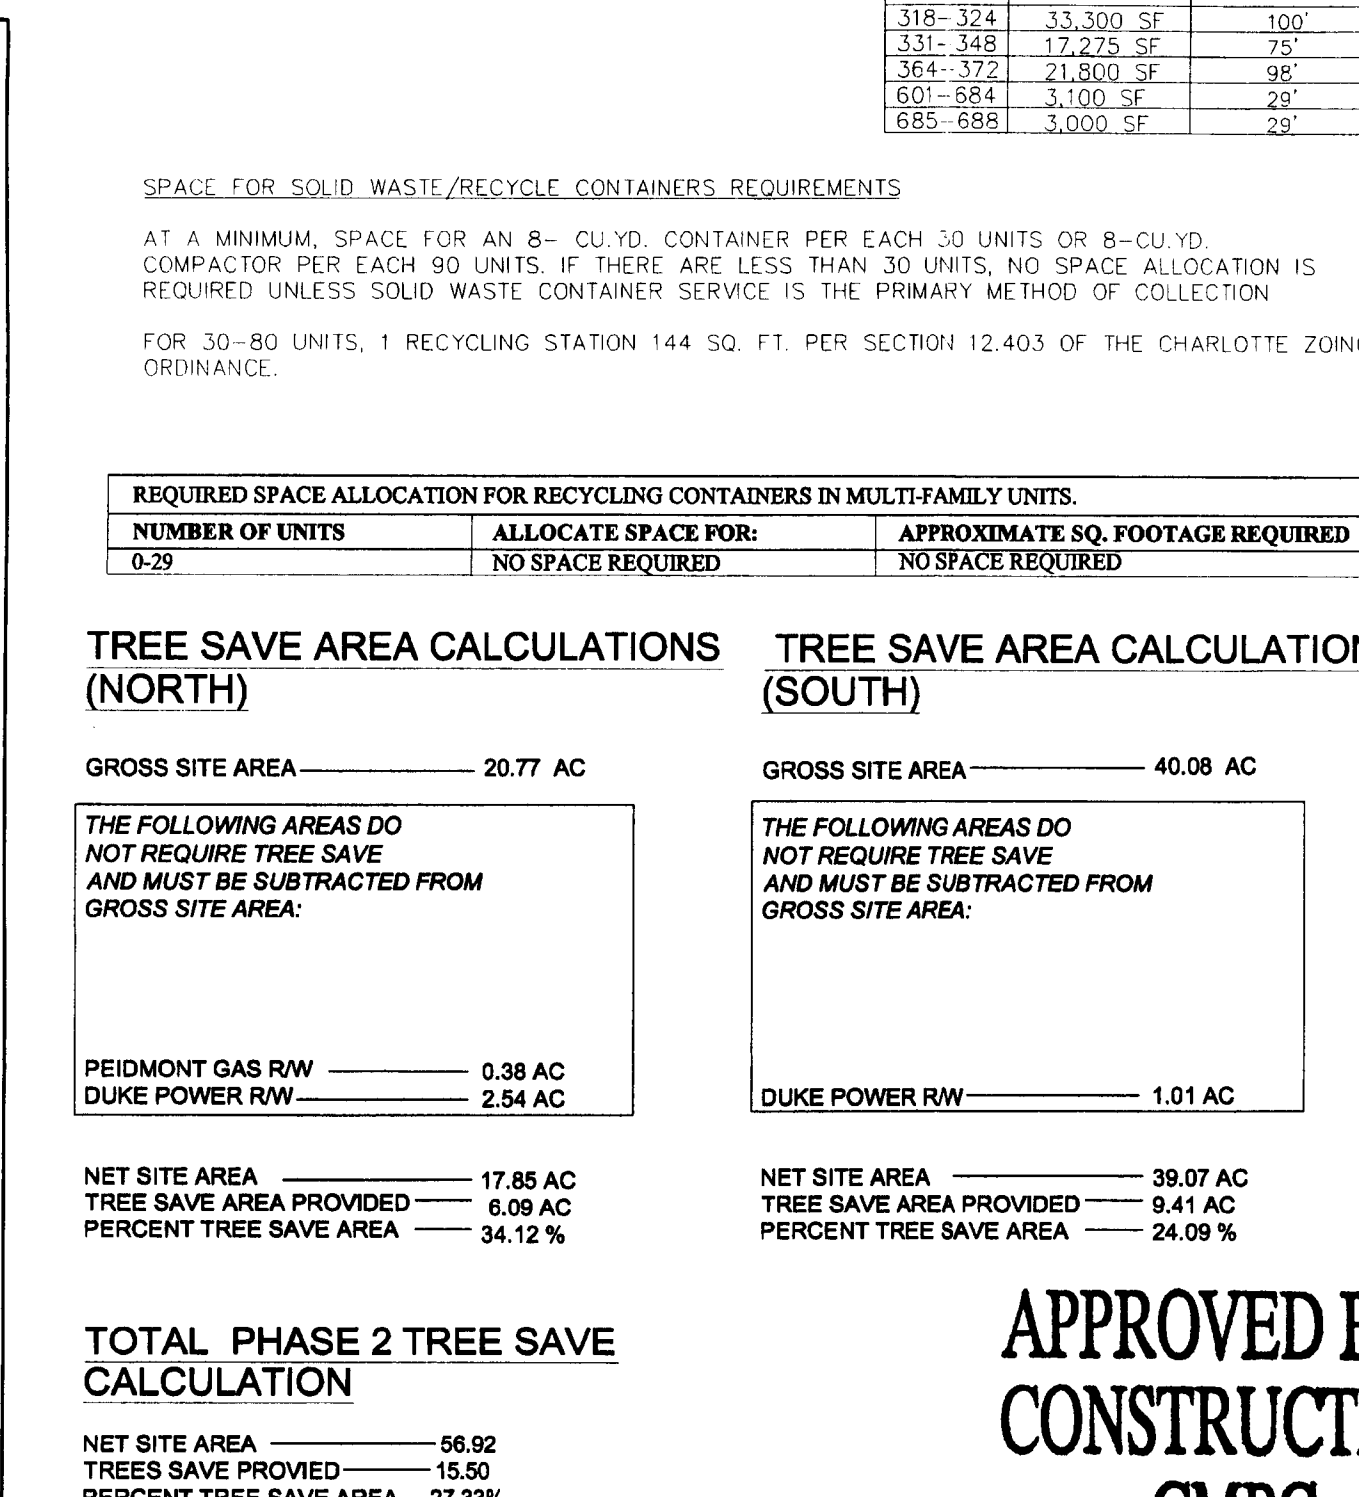

PHASE 2 PRIVATE UTILITIES

PHASE 2 PUBLIC UTILITIES

PHASE 2 TREE SAVE AREA CALCULATIONS (NORTH)

PHASE 2 TREE SAVE AREA CALCULATIONS (SOUTH)

PHASE 2 TOTAL TREE SAVE CALCULATION

PHASE 2 APPROVED FOR CONSTRUCTION

CMPC

Signature 11.15.07




Stantec Consulting Services Inc.
2127 Ayrley Town Blvd., Suite 301
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Tel. 704.329.0900
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Legend



Notes

SITE DATA:
PARCEL ID: 11 322 117
TOTAL OVERALL PROJECT SITE AREA: ±598.97 AC.
PHASE 2 GROSS SITE AREA: ±60.85 AC.
PHASE 2 RESIDENTIAL SITE AREA DEVELOPED (SINGLE FAMILY): ±40.08 AC.
PHASE 2 COMMERCIAL SITE AREA DEVELOPED (MULTI FAMILY): ±20.77 AC.
PHASE 2 COMMON OPEN SPACE: ±24.88 AC. (40.89%)
PHASE 2 ROAD LF: ±4,012.55 FT
RESIDENTIAL ZONING: MX-2(NH), NS (PETITION # 2005-014)
CATAMBA RIVER/LAKE WYLIE & LOWER LAKE WYLIE WATERSHED OVERLAY CRITICAL AREA
BUILT UPON AREA (% B.U.): 50.00 % (SEE SHEET C2.59 & C)
(HIGH DENSITY PERMIT REQUIRED)
OF PROPOSED TOWNHOMES FOR SALE: 8
OF PROPOSED SINGLE FAMILY FOR SALE: 40
INNOVATIVE STANDARDS:
MIN FRONT SETBACK: 20'
MIN REAR YARD: 15'
MIN SIDE: 3'
MIN TOWNHOUSE PRIVATE LOT: 100'
MIN TOWNHOUSE PRIVATE OPEN SPACE: 2,000 SF
MIN TOWNHOUSE PRIVATE OPEN SPACE: 400 SF
MIN BUILDING HEIGHT: 40'
SEPARATION: 7' FOR SINGLE FAMILY DETACHED
16' FOR TOWNHOMES
2 SPACE PER LOT (ATTACHED OR DETACHED)
PARKING

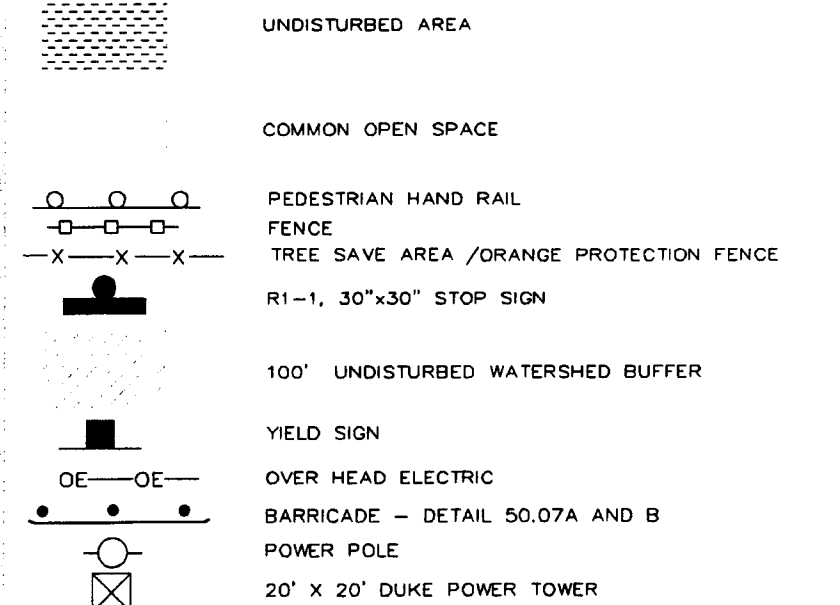1 REVISIONS PER CITY OF CHARLOTTE	ER	RDL	07.04.30
Revision	By	Appd.	YY.MM.DD

File Name: 00722C-102SP.dwg	DGN	RDL	KWR	07.02.16
	Dwn.	Chkd.	Degn.	YY.MM.DD



Client/Project
DR HORTON, INC.
1100 SOUTH TRYON ST. SUITE 100
CHARLOTTE NC 28203
THE VINEYARDS ON LAKE WYLIE
PHASE II
Charlotte NC U.S.A. ETJ

Title
SITE PLAN OVERALL

Project No.
173200722-200

Drawing No.
C2.1





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Legend

Notes

Revision

By

Appd.

YY.MM.DD

File Name: 00722C-102SP.dwg

DGN

Dwn.

RDL


Chkd.

KWR

Degn.

07.02.16

YY.MM.DD

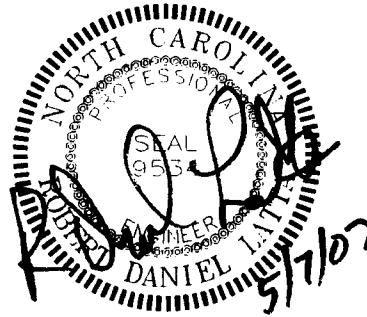

Client/Project

DR HORTON, INC.
1100 SOUTH TRYON ST. SUITE 100
CHARLOTTE NC 28203
THE VINEYARDS ON LAKE WYLIE
PHASE II
Charlotte NC U.S.A. ETJ

Title

SITE PLAN

Project No.

173200722-200

Scale

0

1:200'

Sheet

Revision

C2.2

V:\232\active\173200540\173200722 design\drawing\00722C-102SP.dwg
RIZO, ERASMO
4/26/2007 5:07:12 PM

CURVE TABLE (ROAD)		
LINE	LENGTH	BEARING
L1	49.18	S77°53'15"E
L2	61.61	S02°53'15"E
L3	101.22	S48°38'54"E
L4	166.87	S25°26'31"E
L5	43.61	S71°29'28"E
L6	76.66	N75°10'07"W
L7	35.73	N43°39'25"W
L8	480.01	N16°18'35"W
L9	76.11	N68°49'03"E
L10	196.07	S36°10'06"W
L11	149.68	S14°49'53"W
L12	282.97	S56°51'42"E
L13	10.00	N53°09'18"E
L14	47.52	S81°49'32"E
L15	49.69	N88°33'15"E
L16	51.38	N62°27'14"E
L17	89.82	N88°33'15"E


LINE TABLE (PHASE LINE)		
L18	276.38	N77°53'15"W
L19	111.80	N51°19'15"W
L20	175.30	S77°53'15"E
L21	77.00	N12°06'45"E
L22	425.94	N77°53'15"W
L23	104.61	S17°23'17"W
L24	681.30	S38°32'26"W
L25	124.65	N53°30'26"W
L26	30.06	N51°12'09"W
L27	55.96	N44°47'08"W
L28	79.63	N71°42'54"W
L29	50.31	N18°30'44"E
L30	43.61	N71°29'28"W
L31	176.61	N35°26'31"W
L32	105.67	N54°33'29"E
L33	177.77	N46°02'52"W
L34	170.62	N77°53'15"W
L35	105.67	N12°14'29"E
L36	76.89	S77°53'15"E
L37	280.66	N12°06'45"E
L38	1025.60	N77°53'55"W
L39	75.53	S45°41'24"E
L40	36.18	S40°16'46"E
L41	36.18	S40°16'46"E
L42	36.41	S30°50'03"E
L43	72.58	S48°08'13"E
L44	181.25	S35°58'00"E
L45	32.68	S47°37'09"E
L46	81.37	S39°52'49"E
L47	37.81	S44°12'22"E
L48	102.81	S39°23'57"E
L49	149.06	S41°45'24"E
L50	125.60	S52°32'39"E
L51	588.88	S44°14'14"E
L52	104.95	S73°56'32"E
L53	64.94	S44°00'03"E
L54	25.73	S59°45'20"E
L55	642.61	N69°41'49"E
L56	74.22	S20°18'11"E
L57	120.00	S69°41'49"W
L58	174.09	S30°18'11"E
L59	100.00	S69°49'03"W
L60	63.01	S57°40'15"E
L61	343.09	S16°19'17"E
L62	434.51	S51°36'51"E
L63	50.28	S47°49'43"E
L64	174.03	S55°45'18"E
L65	162.81	S55°45'18"E
L66	198.58	N15°30'22"E
L67	147.01	N73°01'21"W
L68	73.58	N73°01'21"W
L69	83.60	N36°51'42"W
L70	282.97	N36°51'42"W
L71	207.53	N35°15'26"W
L72	76.63	N39°09'41"W
L73	165.75	N18°19'44"W
L74	91.11	N33°43'09"W
L75	147.63	N00°06'37"E
L76	25.75	N08°57'27"W
L77	76.80	N16°09'20"W
L78	54.85	N32°41'23"E
L79	15.07	N18°59'24"W
L80	23.06	N01°19'26"E
L81	24.25	N34°47'09"W
L82	107.11	N20°11'24"W
L83	54.72	N10°04'47"E
L84	89.52	N09°59'34"W
L85	103.42	N07°00'23"W
L86	77.59	N31°37'12"W
L87	42.53	N03°06'32"E
L88	54.40	N07°36'01"W
L89	132.24	N20°18'11"W
L90	170.45	N16°19'56"E
L91	51.40	N73°01'21"W
L92	103.56	N36°24'59"W
L93	82.73	N35°32'30"W
L94	76.96	S65°21'40"W
L95	154.41	S02°05'56"E
L96	150.31	S20°59'00"E
L97	149.97	N20°55'55"W
L98	103.68	N82°41'33"E

CURVE TABLE (ROAD)				
CURVE	LENGTH	RADIUS	CH BEARING	CH DIST.
C0	110.50'	150.00'	S81°00'33"W	108.01'
C1	119.80'	150.00'	S25°46'05"E	116.64'
C2	34.57'	150.00'	N42°02'43"W	34.50'
C3	94.38'	150.00'	S53°28'00"E	92.83'
C4	89.47'	150.00'	S58°04'54"E	88.15'
C5	71.62'	150.00'	S29°59'19"E	70.94'
C6	225.87'	150.00'	S28°49'41"W	205.13'
C7	111.72'	300.00'	S25°30'00"W	111.08'
C8	203.00'	225.00'	S11°00'54"E	196.18'
C9	68.40'	90.00'	S76°24'11"W	66.76'
C10	18.41'	50.00'	N78°00'15"E	18.31'
C11	18.41'	50.00'	S78°00'15"W	18.31'

CURVE TABLE (PHASE LINE)				
C12	149.73'	175.99'	N83°54'44"E	145.25'
C13	78.65'	125.00'	S53°28'00"E	77.36'
C14	25.07'	54.51'	N37°10'09"W	24.85'
C15	148.53'	107.05'	N75°05'25"W	136.90'
C16	100.17'	72.19'	N75°05'25"W	92.33'
C17	156.01'	132.50'	S31°37'52"W	147.15'
C18	129.42'	585.46'	S07°42'35"E	129.16'
C19	94.27'	465.00'	S15°10'32"E	94.11'
C31	109.81'	217.15'	N06°33'49"W	108.65'
C32	14.72'	517.19'	N79°04'36"W	14.72'
C33	40.33'	50.00'	S66°24'48"W	39.25'


LINE TABLE (SHORELINE)		
L100	6.50	N28°38'06"E
L101	25.77	S79°26'13"E
L102	19.31	S18°11'21"E
L103	14.19	S73°34'59"E
L104	9.94	N70°47'59"E
L105	20.81	N51°54'28"E
L106	23.60	S50°56'59"E
L107	24.38	S88°57'58"E
L108	19.91	N71°27'54"E
L109	15.14	S81°29'23"E
L110	18.89	S86°23'16"E
L111	25.03	N75°05'32"E
L112	18.40	N66°10'47"E
L113	14.81	S62°35'14"E
L114	24.02	N69°27'08"E
L115	24.70	N48°27'46"E
L116	11.25	S19°51'09"E
L117	20.30	N89°37'59"E
L118	15.00	N67°52'46"E
L119	15.26	N69°00'01"E
L120	20.29	N80°40'04"E
L121	20.52	N40°13'00"E
L122	20.68	N45°12'56"E
L123	20.65	N44°47'03"E
L124	19.76	N27°50'57"E
L125	20.70	N19°05'29"E
L126	20.74	N24°26'22"E
L127	20.54	N01°06'56"W
L128	11.75	N14°01'38"E
L129	3.76	N14°01'38"E
L130	20.75	N04°20'22"W
L131	25.39	N01°21'15"W
L132	24.77	N36°56'38"W
L133	15.40	N27°54'46"W
L134	20.81	N39°31'12"W
L135	20.78	N32°13'18"W
L136	20.26	N20°41'54"W
L137	20.19	N18°43'20"E
L138	25.12	N10°13'38"W
L139	23.86	N06°11'00"E
L140	18.67	N69°24'19"E
L141	15.46	N14°50'44"E
L142	15.38	N34°08'04"E
L143	20.56	N23°35'51"E
L144	20.57	N46°29'49"E
L145	15.71	N34°32'59"E
L146	20.29	N30°51'43"E
L147	20.42	N22°14'39"E
L148	20.70	N37°13'27"E
L149	20.15	N42°01'23"E
L150	24.98	N14°36'33"E
L151	9.39	N51°28'59"E
L152	14.85	N60°38'17"E
L153	20.42	N22°23'43"E
L154	19.97	N50°19'23"E
L155	20.76	N16°01'30"E
L156	20.43	N29°10'28"E
L157	13.97	S80°29'01"E
L158	14.95	S63°04'30"E
L159	25.06	N54°05'25"E
L160	20.87	N03°21'07"E
L161	19.29	N26°16'22"E
L162	19.96	N57°14'57"E
L163	20.44	N39°56'18"E
L164	22.61	N16°59'49"E
L165	23.59	N38°32'25"E
L166	19.31	N79°20'51"E
L167	23.75	N37°30'25"E
L168	32.58	N54°06'37"E
L169	16.60	N82°25'05"E
L170	14.94	N40°54'03"E
L171	19.85	N71°33'21"E
L172	15.21	N16°27'27"E

LINE TABLE SHORELINE		
LINE	LENGTH	BEARING
L173	14.04	N74°02'36"E
L174	9.45	N27°53'39"E
L175	14.81	N88°31'49"E
L176	10.20	S78°20'55"E
L177	1.95	N70°12'57"E
L178	1.88	S11°12'58"W
L179	9.25	S27°30'07"W
L180	23.61	S40°08'34"W
L181	8.05	S85°52'07"W
L182	8.33	N71°35'13"W
L183	9.39	S39°51'37"E
L184	11.69	S01°34'05"E
L185	22.37	S20°16'27"W
L186	22.84	S31°59'32"W
L187	7.78	S64°53'07"W
L188	21.14	N87°04'25"W
L189	13.37	S67°12'19"E
L190	7.66	S04°56'38"W
L191	35.31	S37°24'19"W
L192	10.30	S64°46'41"W
L193	32.73	S39°09'36"W
L194	37.66	S37°50'24"W
L195	16.49	S06°00'23"W
L196	34.58	S01°28'29"W
L197	17.33	S38°34'57"W
L198	32.92	S03°48'51"W
L199	43.57	S04°34'05"W
L200	31.03	S17°11'09"W
L201	23.10	S14°00'26"W
L202	22.05	S13°58'02"W
L203	12.49	S72°00'48"W
L204	11.25	S14°53'11"W
L205	9.04	S34°20'41"E
L206	34.70	S06°54'01"W
L207	11.93	S30°17'10"E
L208	30.30	S02°59'20"E
L209	34.75	S02°13'14"W
L210	21.38	S66°02'15"E
L211	20.55	S25°02'38"E
L212	29.25	S07°24'16"W
L213	21.26	S00°40'27"W
L214	29.08	S62°16'18"W
L215	13.51	S77°21'18"W
L216	8.00	N88°48'15"W
L217	7.62	S03°32'03"E
L218	19.39	S58°34'49"W
L219	6.38	S63°28'30"E
L220	17.26	N65°13'55"E
L221	8.41	N39°15'21"E
L222	29.35	N79°51'15"E
L223	6.25	S37°11'59"E
L224	17.54	S10°04'48"W
L225	11.31	S21°27'46"W
L226	12.05	S18°01'45"W
L227	15.45	S30°31'53"W
L228	7.93	S78°43'57"E
L229	25.35	N32°23'11"E
L230	9.97	S18°25'00"E
L231	15.68	S08°10'36"W
L232	22.36	S37°14'20"W
L233	30.04	S13°07'13"E
L234	9.34	S32°53'24"W
L235	9.69	S04°33'27"W
L236	8.09	S64°59'16"W
L237	6.39	N75°13'28"W
L238	16.26	N80°26'21"W
L239	3.21	S83°44'19"W
L240	7.82	S50°14'29"E
L241	4.30	S09°22'29"E
L242	2.83	S47°17'26"W
L243	8.85	N84°37'05"W
L244	7.44	N72°23'36"W
L245	8.40	S81°46'59"W
L246	6.37	S52°23'35"W
L247	11.14	S81°53'56"W
L248	3.71	S87°50'20"W
L249	3.54	S30°24'29"W
L250	4.65	S21°09'41"W
L251	9.42	S10°27'46"E
L252	5.87	S09°54'43"W
L253	19.96	S07°13'29"E
L254	4.14	S22°17'23"W
L255	16.58	S61°49'41"W

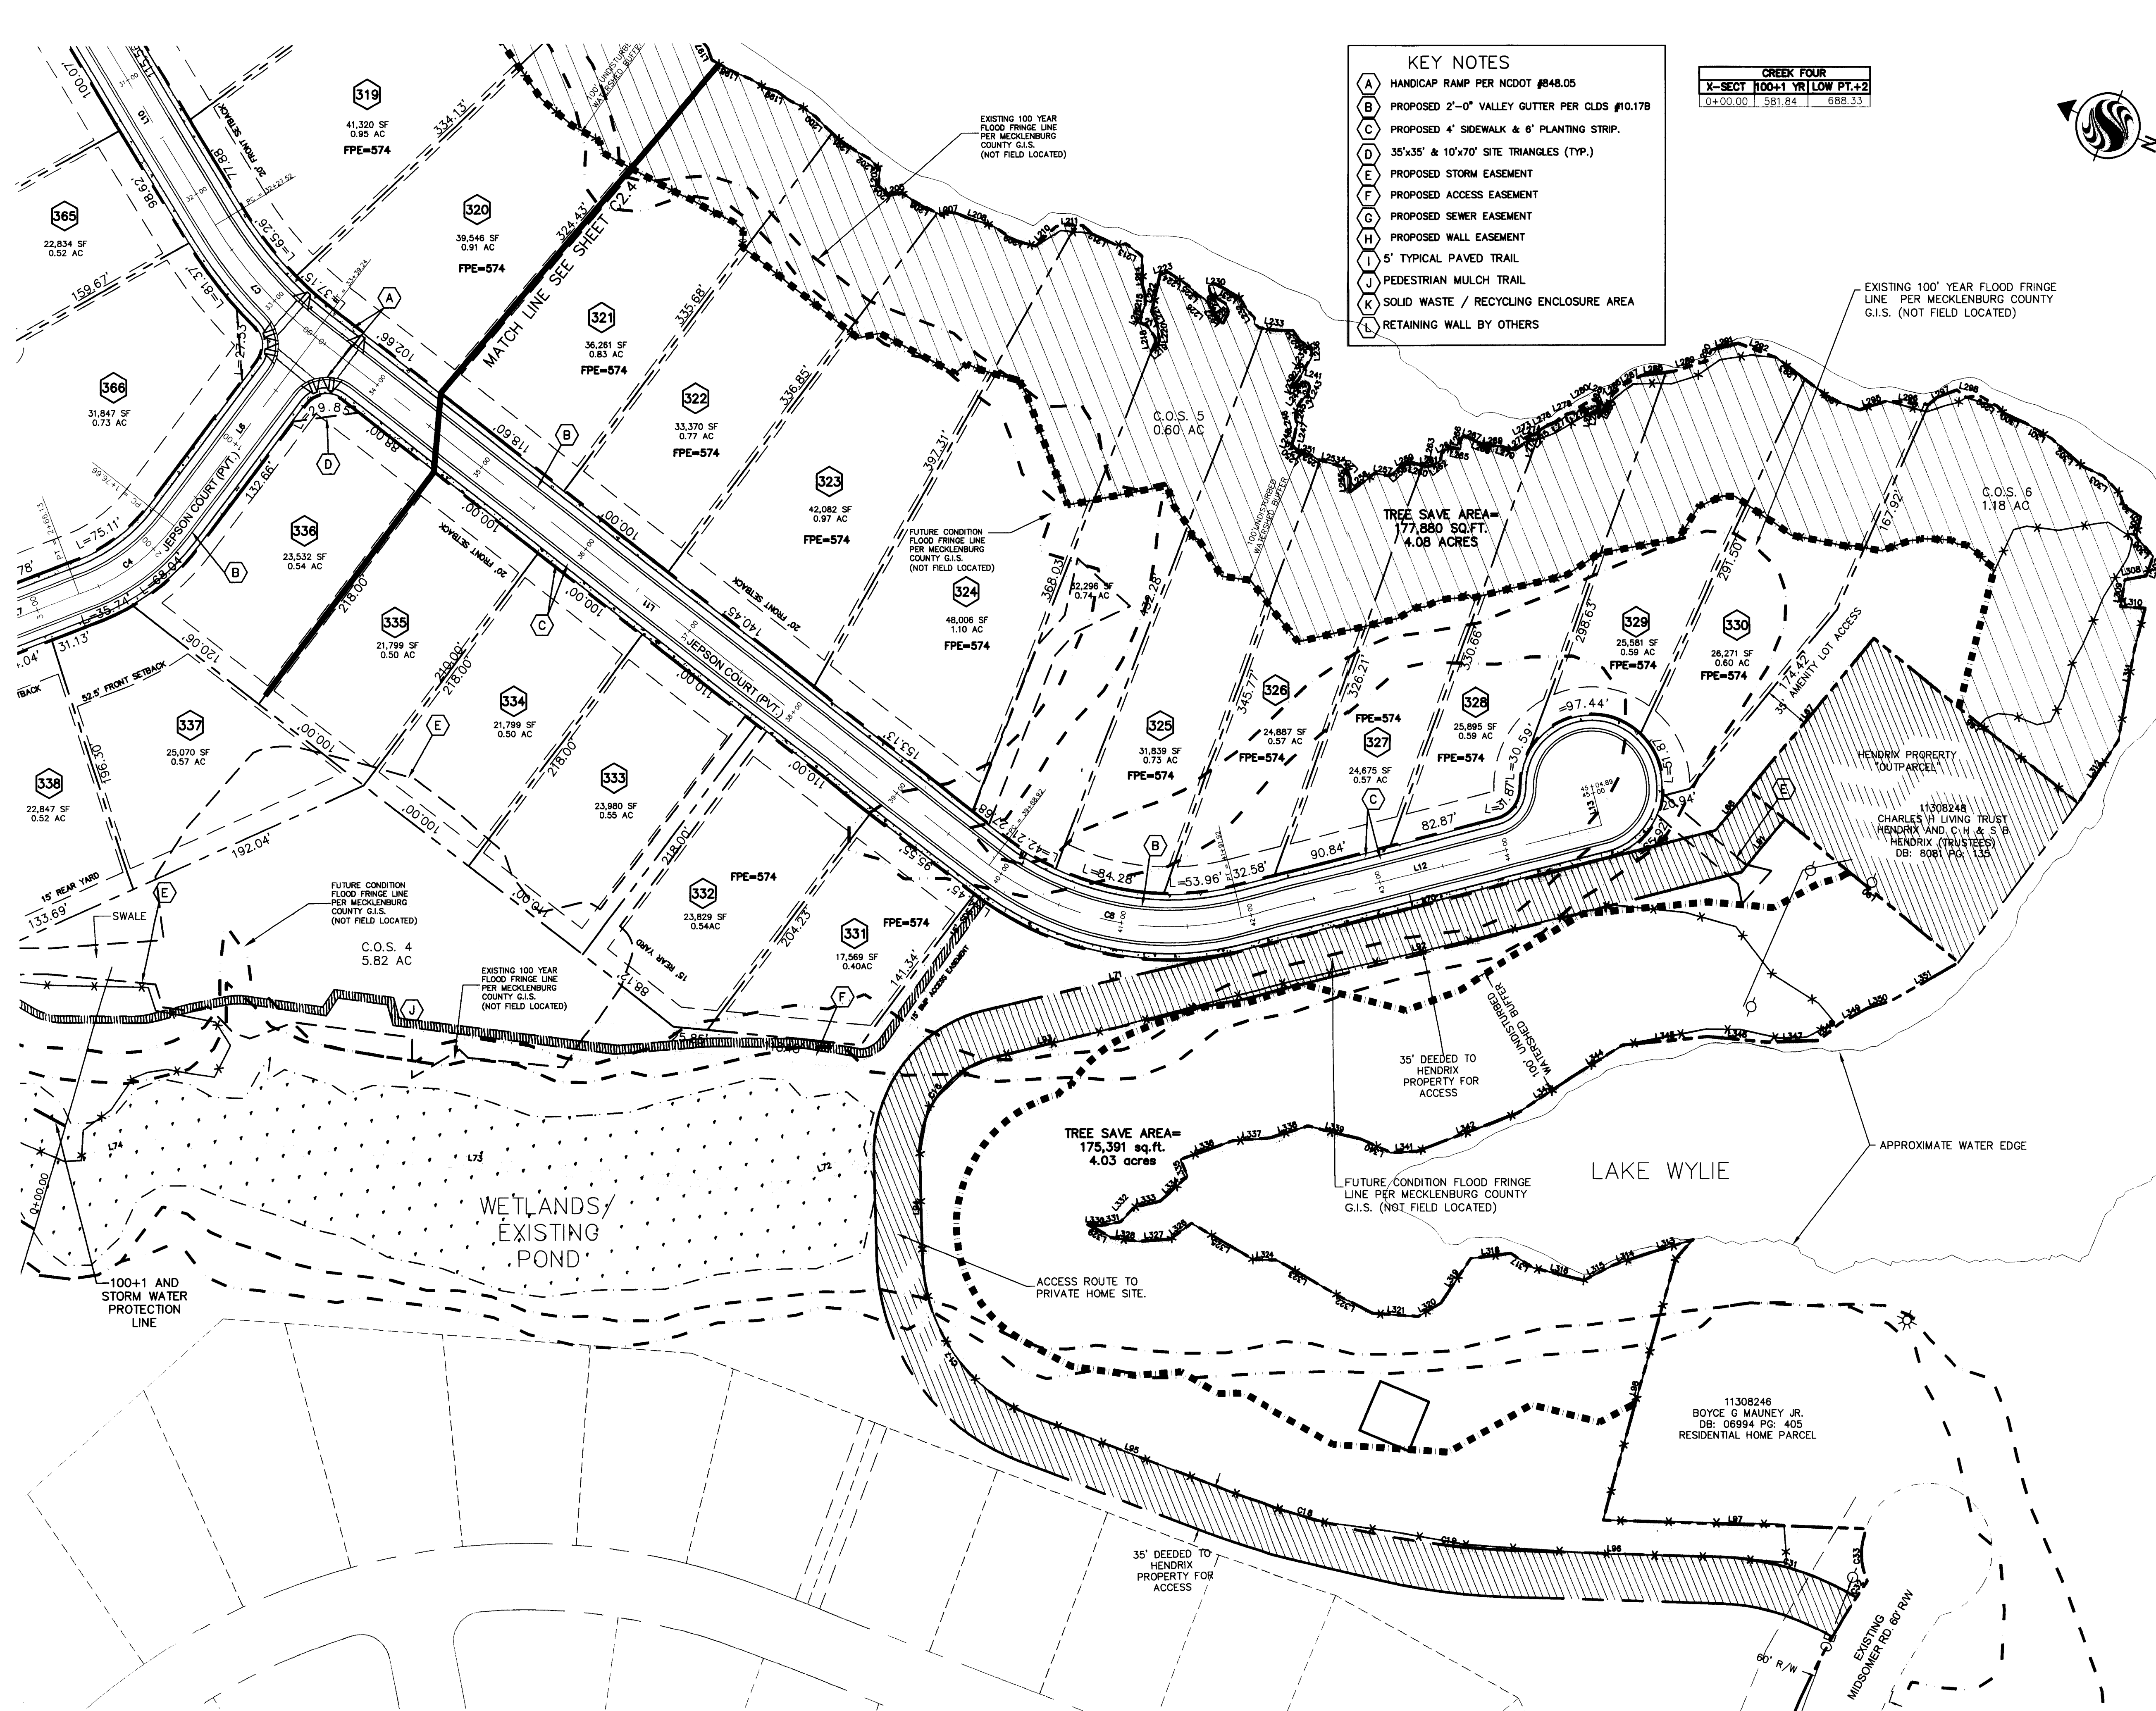

- KEY NOTES
- A HANDICAP RAMP PER NCDOT #848.05
 - B PROPOSED 2'-0" VALLEY GUTTER PER CLDS #10.178
 - C PROPOSED 4' SIDEWALK & 6' PLANTING STRIP.
 - D 35'x35' & 10'x70' SITE TRIANGLES (TYP.)
 - E PROPOSED STORM EASEMENT
 - F PROPOSED ACCESS EASEMENT
 - G PROPOSED SEWER EASEMENT
 - H PROPOSED WALL EASEMENT
 - I 5' TYPICAL PAVED TRAIL
 - J PEDESTRIAN MULCH TRAIL
 - K SOLID WASTE / RECYCLING ENCLOSURE AREA
 - L RETAINING WALL BY OTHERS

CREEK FOUR		
X-SECT	100+1 YR LOW PT.+2	
0+00.00	581.84	688.33

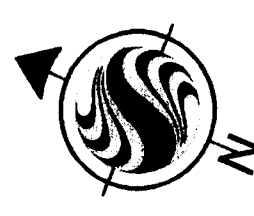

Stantec Consulting Services Inc.
2127 Ayrley Town Blvd., Suite 300
Charlotte NC U.S.A.
Tel. 704.329.0900
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- Legend
- UNDISTURBED AREA
 - COMMON OPEN SPACE
 - PEDESTRIAN HAND RAIL
 - FENCE
 - TREE SAVE AREA /ORANGE PROTECTION FENCE
 - R1-1, 30"x30" STOP SIGN
 - 100' UNDISTURBED WATERSHED BUFFER
 - YIELD SIGN
 - OVER HEAD ELECTRIC
 - BARRICADE - DETAIL 50.07A AND B
 - POWER POLE
 - 20' X 20' DUKE POWER TOWER

Notes

SITE DATA:

PARCEL ID: 11 322 117

TOTAL OVERALL PROJECT SITE AREA: ±598.97 AC.

PHASE 2 GROSS SITE AREA: ±80.85 AC.

PHASE 2 RESIDENTIAL SITE AREA DEVELOPED (SINGLE FAMILY): ± 40.08 AC.

PHASE 2 COMMERCIAL SITE AREA DEVELOPED (MULTI FAMILY): ± 20.77 AC.

PHASE 2 COMMON OPEN SPACE: ± 24.88 AC (40.89%)

PHASE 2 ROAD LF: ±4,012.55 FT

RESIDENTIAL ZONING: MX-2(NNO) NS (PETITION # 2005-014)

CATAWBA RIVER/LAKE WYLIE & LOWER LAKE WYLIE WATERSHED OVERLAY CRITICAL AREA

BUILT UPON AREA (% B.U.): 50.00 % (SEE SHEET C2.6B & C) (HIGH DENSITY PERMIT REQUIRED)

OF PROPOSED TOWNHOMES FOR SALE: 8

OF PROPOSED SINGLE FAMILY FOR SALE: 40

INNOVATIVE STANDARDS:	
MIN FRONT SETBACK:	20'
MIN REAR YARD:	15'
MIN SIDE:	3'
PARCEL G1 MIN LOT WIDTH:	100'
PARCEL H MIN LOT WIDTH:	60'
MIN TOWNHOUSE PRIVATE LOT:	2,000 SF
MIN TOWNHOUSE PRIVATE OPEN SPACE:	400 SF
MAX BUILDING HEIGHT:	40'
SEPERATION:	7' FOR SINGLE FAMILY DETACHED
	16' FOR TOWNHOMES
	2 SPACE PER LOT (ATTACHED OR DETACHED)

REVISIONS PER CITY OF CHARLOTTE		KWR	RDL	07.07.25
REVISIONS PER CITY OF CHARLOTTE		ER	RDL	07.04.30
Revision		By	Appd.	YY.MM.DD

File Name: 00722C-102SP.dwg	DGN	RDL	KWR	07.02.16
	Dwn.	Chld.	Deqn.	YY.MM.DD



Client/Project

DR HORTON, INC.
1100 SOUTH TRYON ST. SUITE 100
CHARLOTTE NC 28203
THE VINEYARDS ON LAKE WYLIE
PHASE II
Charlotte NC U.S.A. ETJ

Title

SITE PLAN SOUTH

Project No.	Scale
173200722-200	1"=60'
Drawing No.	Sheet
	Revision

C2.6

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