### **Charlotte Historic District Commission**

Staff Review HDC 2014-062

### Application for a Certificate of Appropriateness

Date: June 11, 2014

LOCAL HISTORIC DISTRICT: Dilworth

**PROPERTY ADDRESS:** 812 Lexington Avenue

**SUMMARY OF REQUEST:** Addition

OWNER: Stacy Phillips

**APPLICANT:** Kevin & Stacy Phillips

### **Details of Proposed Request**

### **Existing Conditions**

The existing structure is a 1.5 story home constructed in 1929 and listed as a contributing structure in the Dilworth National Register. The home has a large front gable roof.

#### Proposal

The proposal is second floor addition within the existing footprint including a second floor balcony over a new rear porch. The second floor will be enclosed in a cross gable and rear shed dormer. The height is approximately 24'-7" from FFE to the ridge. A new set of paired windows will replace the existing window in the front gable. New windows will match existing. Siding will be wood and the gable will be stucco board and batten.

#### Proposal-June11

The application was continued due to the need for additional information - Streetscape exhibit, boxing notation and handrail detail, if needed per code.

#### **Policy & Design Guidelines for Additions**


Additions to existing structures in Local Historic Districts have a responsibility to complement the original structure. Additions should reflect the design, scale and architectural style of the original structure. The following guidelines are intended to encourage addition designs that are compatible with the existing structure, while not fully mimicking the original design.

following criteria:				
a. Size	the relationship of the project to its site			
b. Scale	the relationship of the building to those around it			
c. Massing	the relationship of the building's various parts to each other			
d. Fenestration	the placement, style and materials of windows and doors			
e. Rhythm	the relationship of fenestration, recesses and projections			
f. Setback	in relation to setback of immediate surroundings			
g. Materials	proper historic materials or approved substitutes			
h. Context	the overall relationship of the project to its surroundings			

- 2. Additions must respect the original character of the property, but must be distinguishable from the original construction.
- 3. All additions to the front or side of existing properties must be of a design that is sensitive to the character and massing of the existing structure.
- 4. Additions to the front or side of existing structures that are substantially visible from a street must go before the full Commission.


### **Staff Analysis**


The project meets the guidelines for additions.

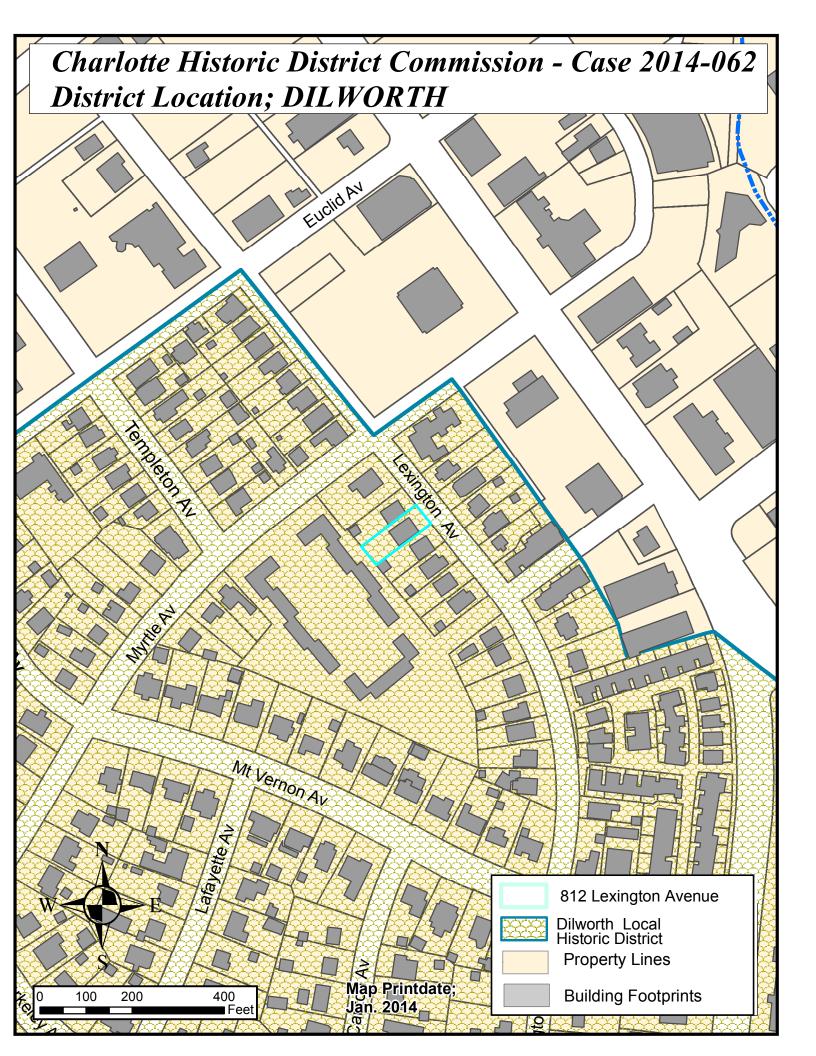





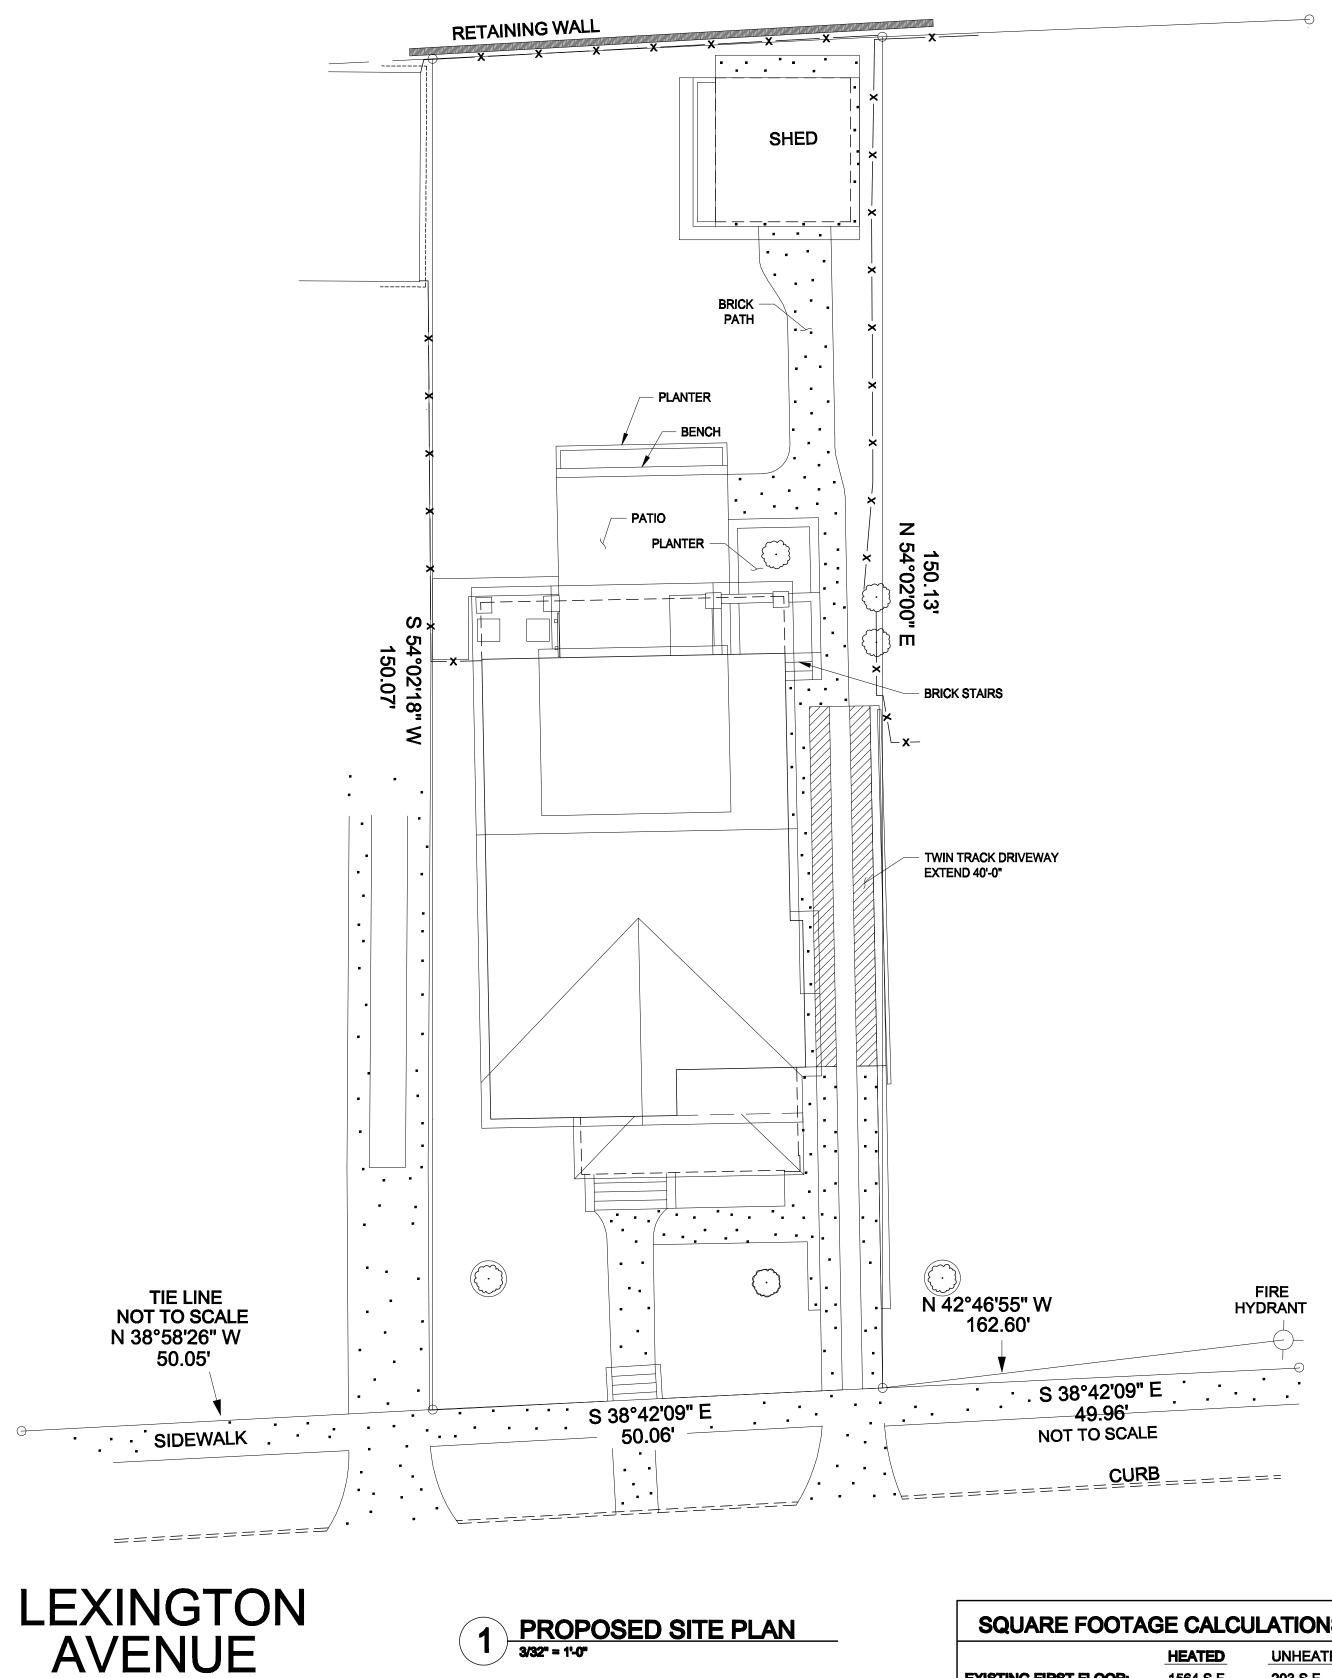

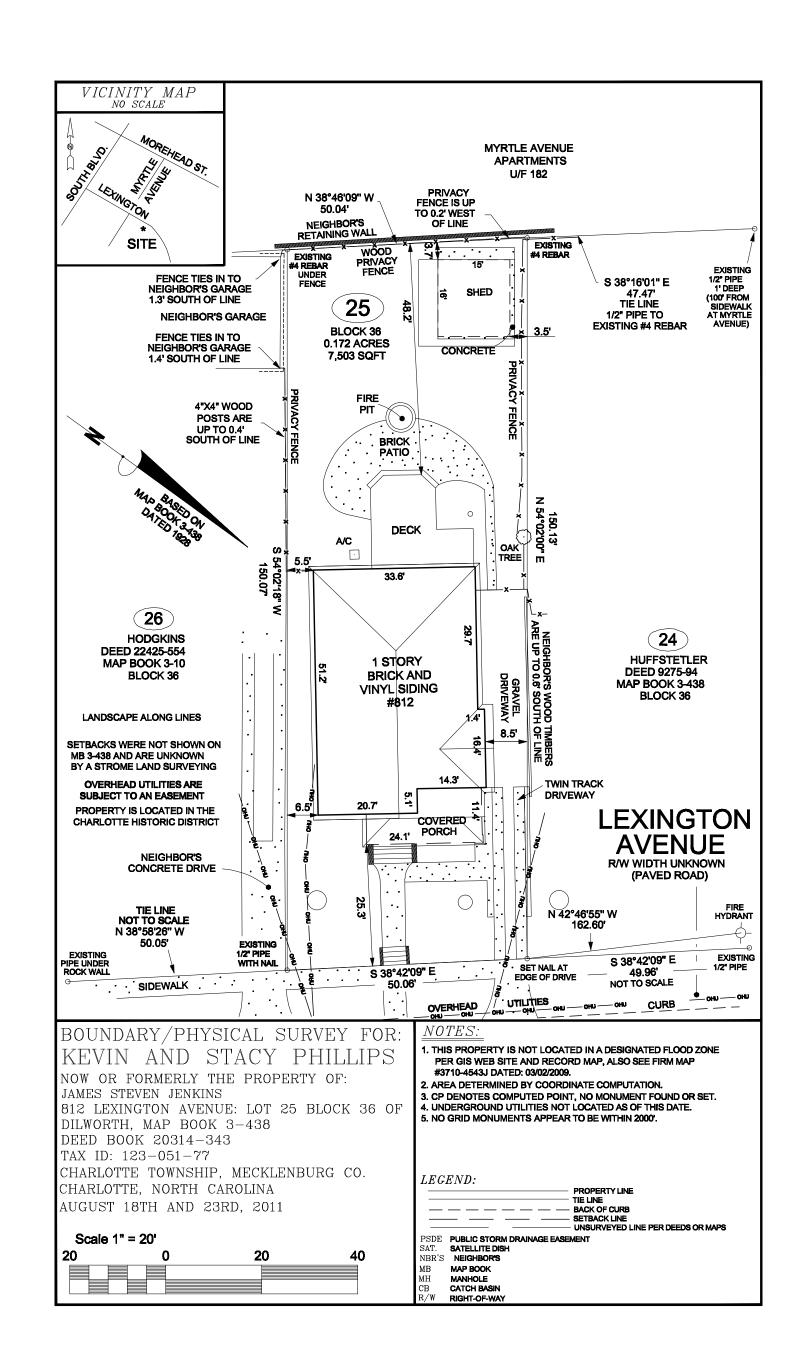

2 EXISTING SITE/SURVEY PLAN
1" = 20'-0"

1 PROPOSED SITE PLAN
3/32" = 1'-0"


SQUARE FOOTAGE CALCULATIONS				
	HEATED	UNHEATED		
EXISTING FIRST FLOOR:	1564 S.F.	203 S.F.		
PROPOSED 2nd FLOOR:	1106 S.F.	106 S.F.		
TOTAL:	2670 S.F.	309 S.F.		



RESIDENCE

KEVIN & STACY PHILLIPS


13137 KOP 6/1/14 **ISSUE DATE:** 

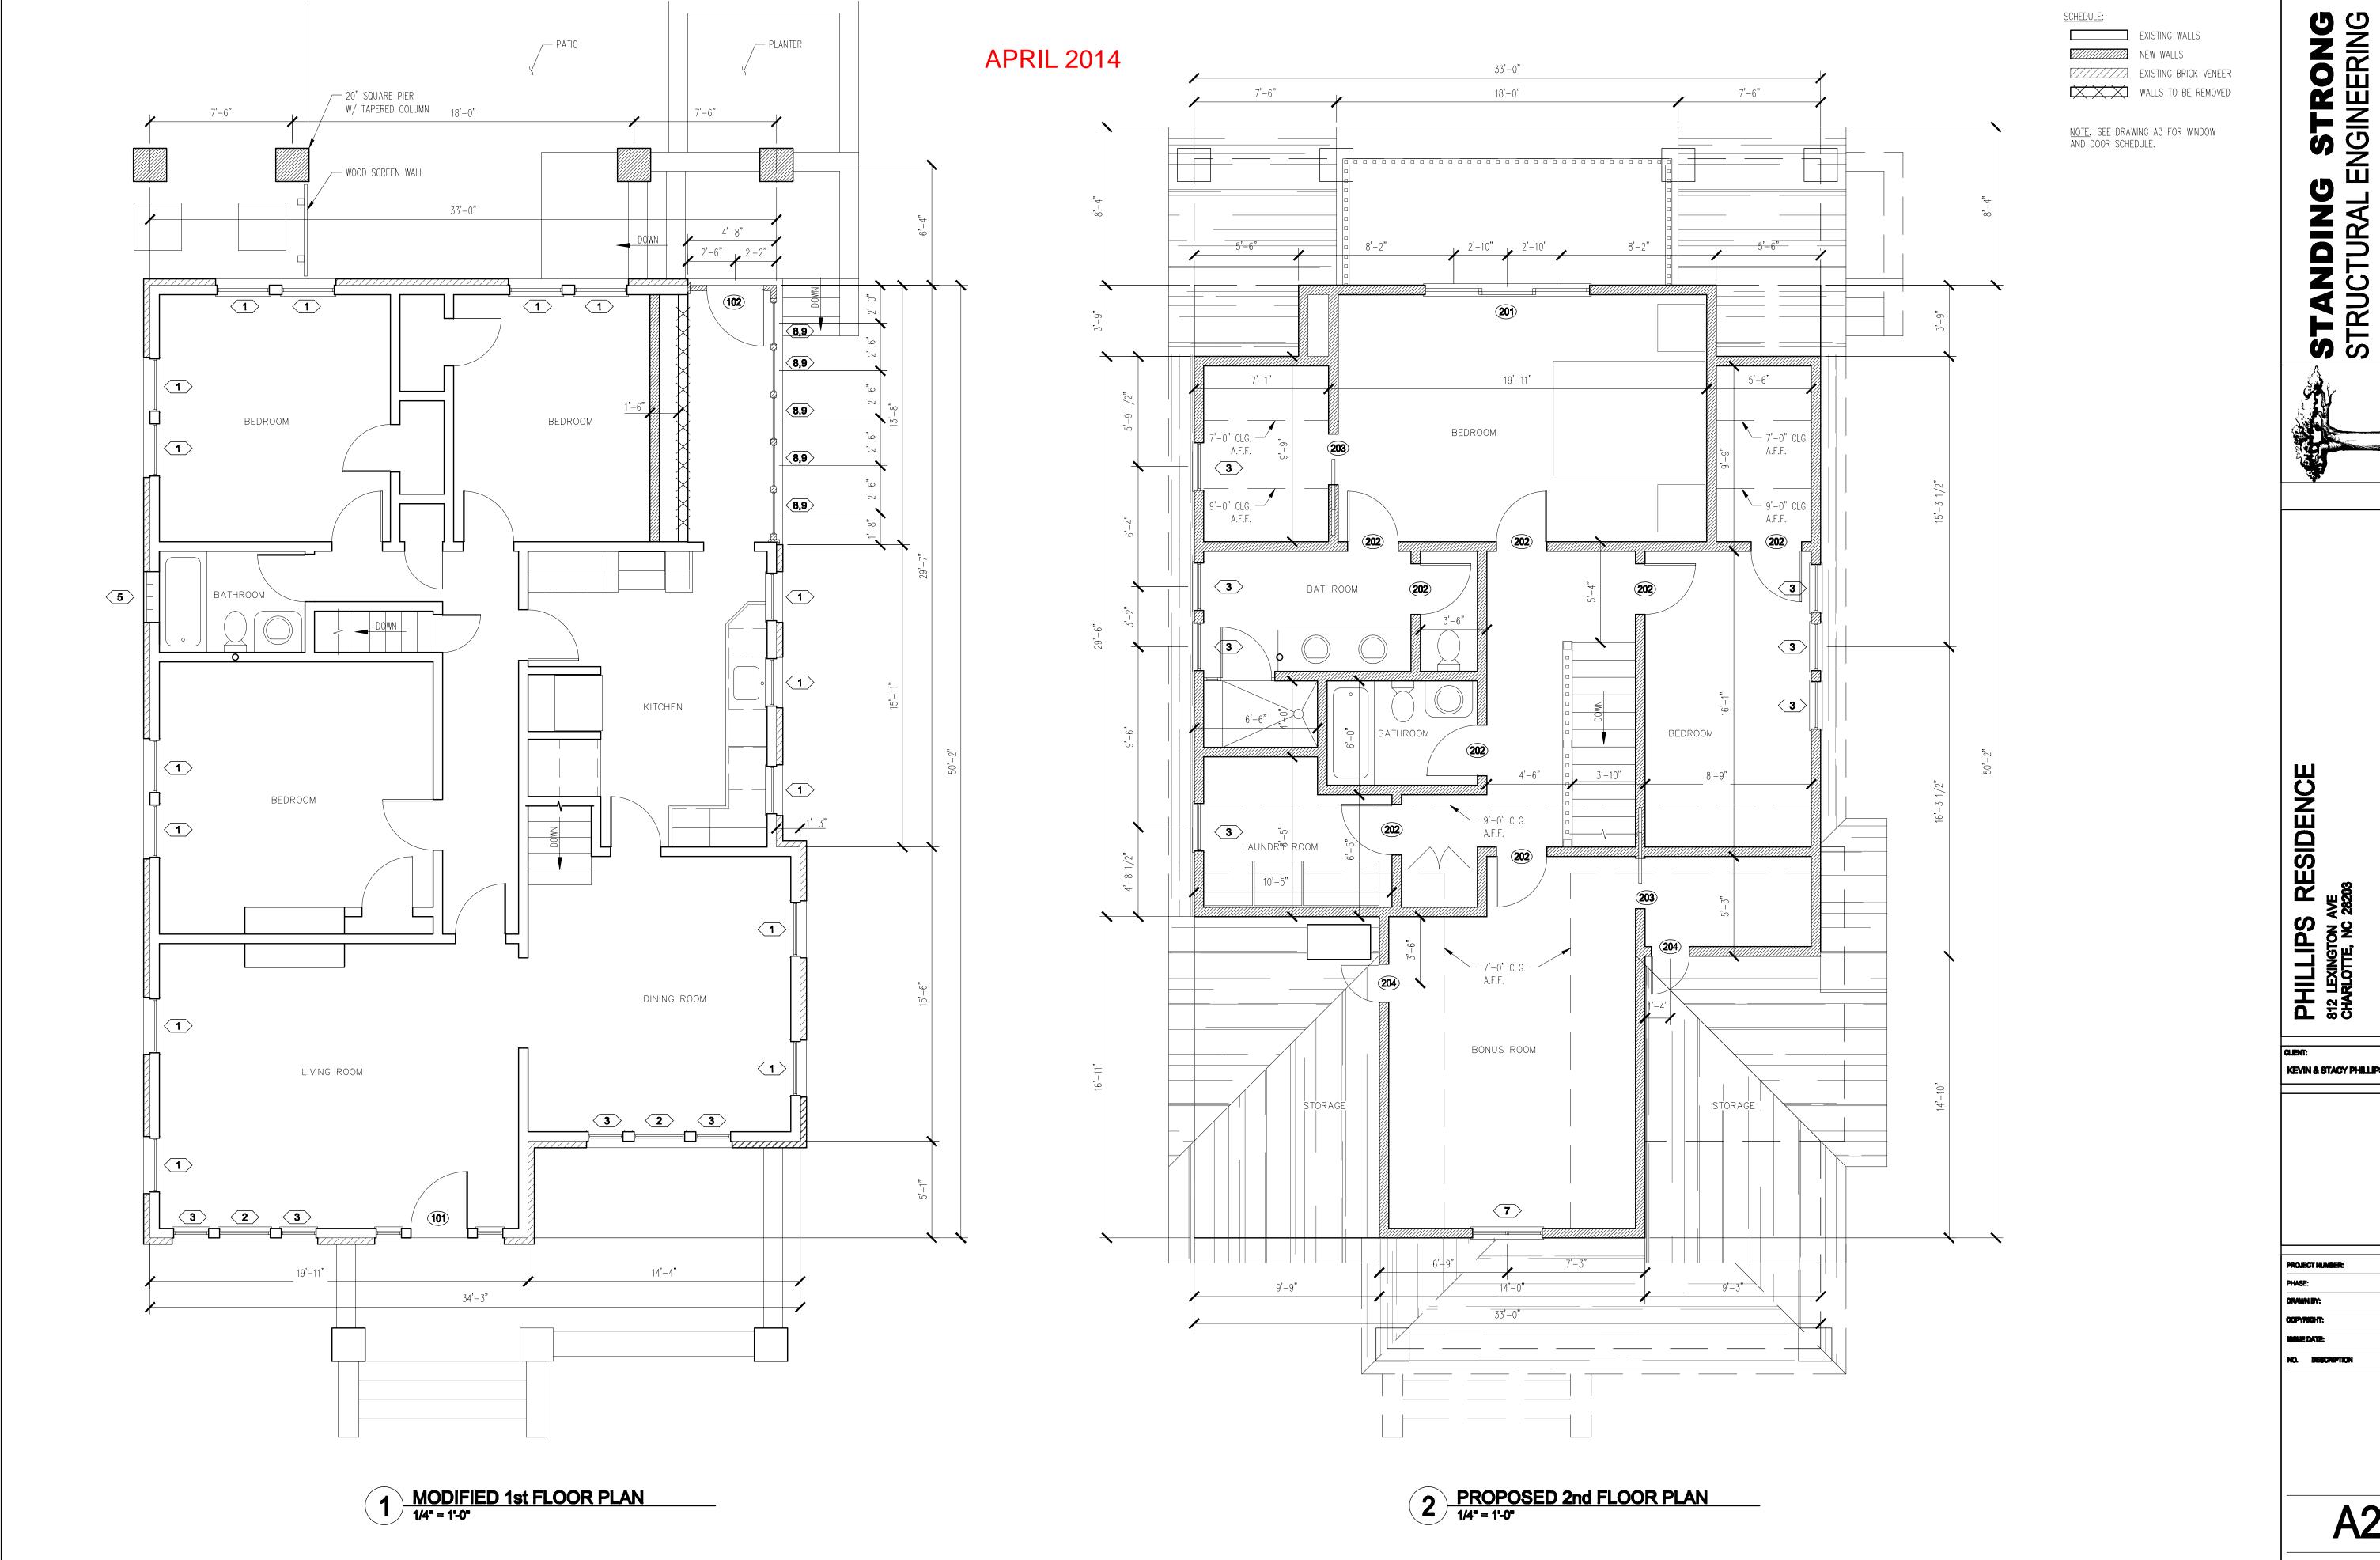

KEVIN & STACY PHILLIPS

13137 KOP

5/1/14

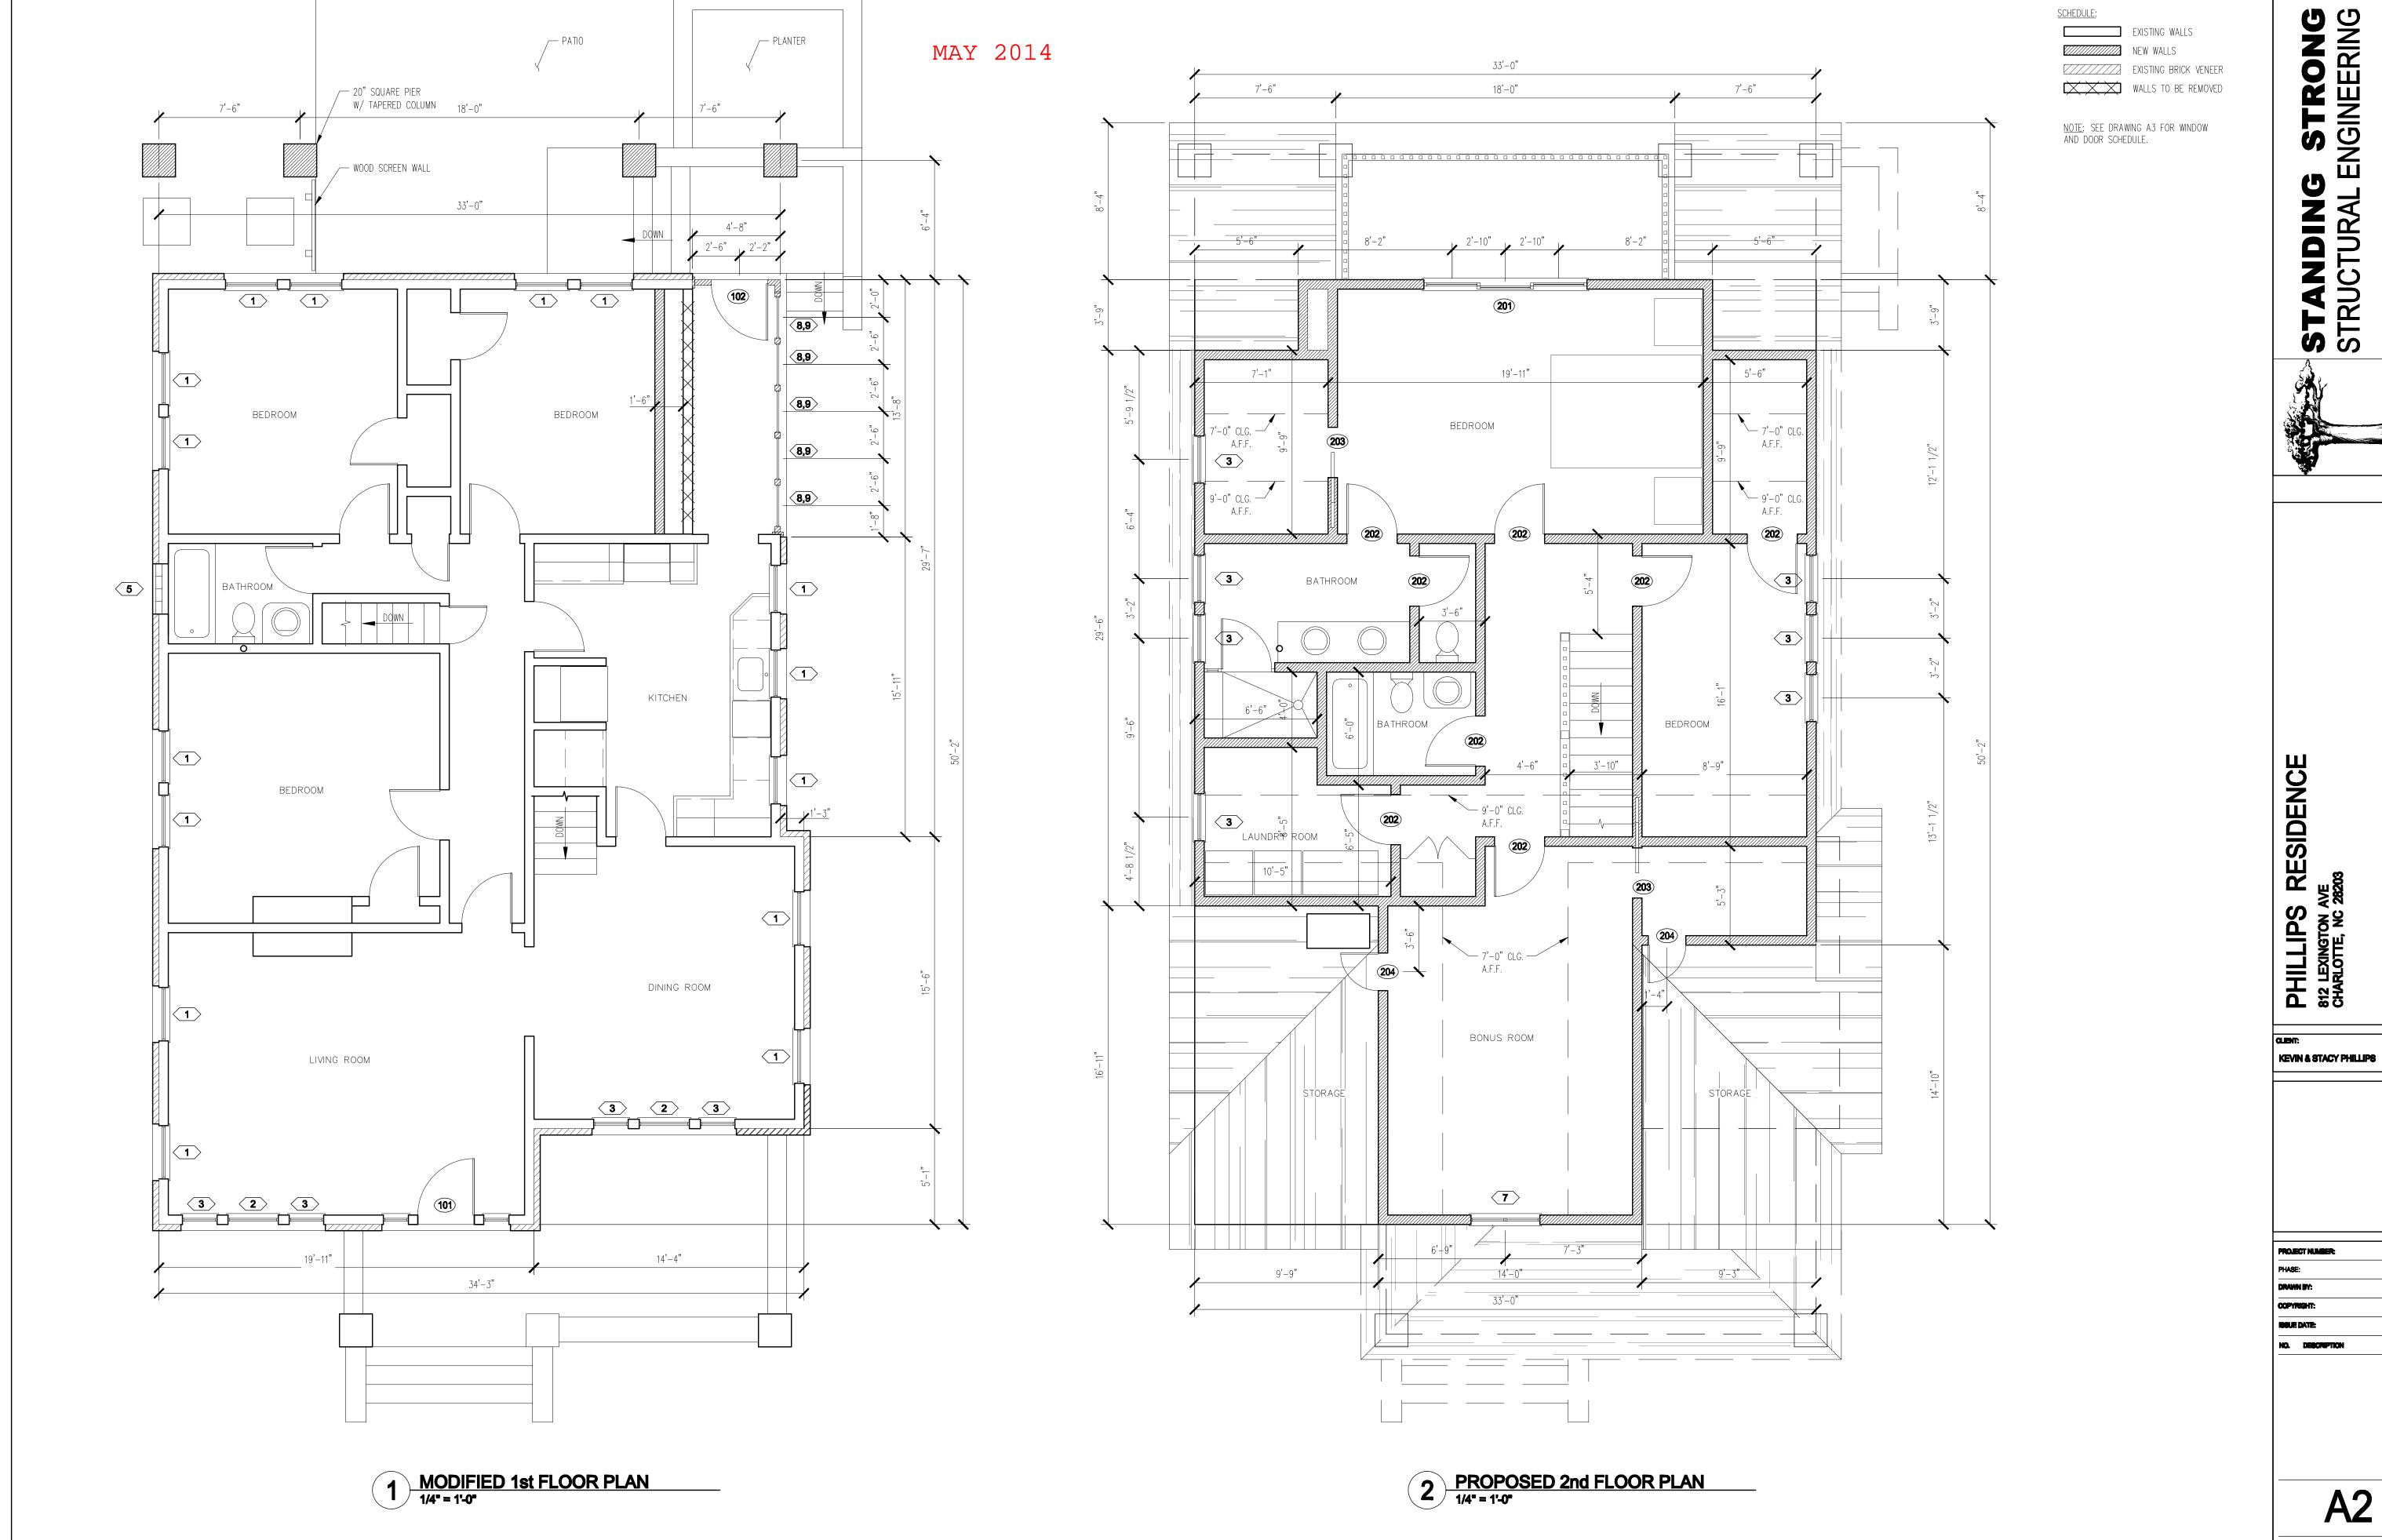

13137 KOP 6/1/14

DOUBLE CASEMENT

DIRECT SET

DIRECT SET

DOUBLE HUNG

DOUBLE HUNG

LOCATION/TYPE

3'-0" x 7'-0" | FRONT DOOR

3'-0" x 7'-0" | BACK DOOR

2'-8" x 6'-8" | BALCONY-SLIDING

2'-8" x 6'-8" | TYP INTERIOR-SLIDING

2'-8" x 6'-8" | TYP INTERIOR

2'-0" x 5'-0" | TYP STORAGE

G STRONG ENGINEERING STANDING STRUCTURAL E

**BACK ELEVATIONS** 

**FRONT** 

RESIDENCE PHILLIPS F 812 LEXINGTON AVE CHARLOTTE, NC 282

**KEVIN & STACY PHILLIPS** 

13137

**A3** 

1st FIN CLG @ 9'-0" EXIST. BRICK VENEER, TYP <u>1</u> VINYL SIDING TO BE REMOVED EXIST. WOOD DECK

EXISTING BACK ELEVATION
3/16" = 1'-0"

TO BE REMOVED

NOTE:
MATCH EXISTING WINDOWS. INSTALL WITH DRIP CAP AND FLASHING. SEE ELEVATIONS FOR MUNTIN PATTERN. VERIFY ANY REQUIREMENTS FOR EGRESS OR TEMPERED GLASS.

4'-4" x 2'-8" | 5'-6"

2'-4" x 4'-0" | 7'-6"

2'-4" x 5'-0" | 7'-6"

2'-4" x 4'-0" | 7'-2"

2'-4" x 2'-4" | -

MATCH TRIM DETAILS W/ WOOD DRIP CAP (W/ FLASHING) AND BACK BAND TRIM AT WINDOWS.

PRIOR TO ORDERING WINDOWS, SUBMIT SHOP DRAWINGS TO THE ARCHITECT FOR APPROVAL.

NOTE: ALL WINDOWS WITH 9 SF OF GLASS OR MORE AND LESS THAN 18" A.F.F. MUST BE TEMPERED PER CODE (TYP).

**# DOOR SCHEDULE** 

MARK OPENING



2 1 2

1st FIN CLG

@ 9'-0"

1st FF @ 0'-0"

2 PROPOSED FRONT ELEVATION
3/16" = 1'-0"




4 PROPOSED BACK ELEVATION
3/16" = 1'-0"

12	12	
2		


EXISTING FRONT ELEVATION
316" = 1'-0"

2 1 2

### MAY 2014

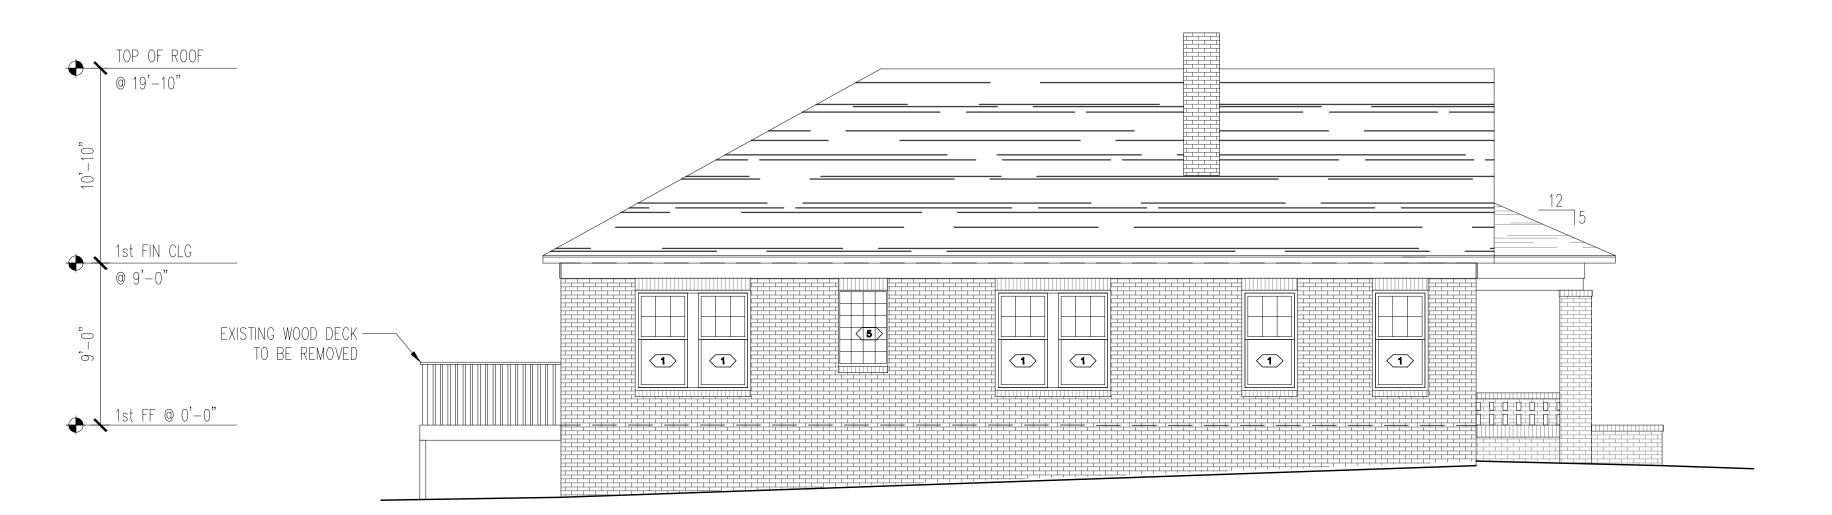

## EXISTING LEFT ELEVATION 3/16" = 1'-0"

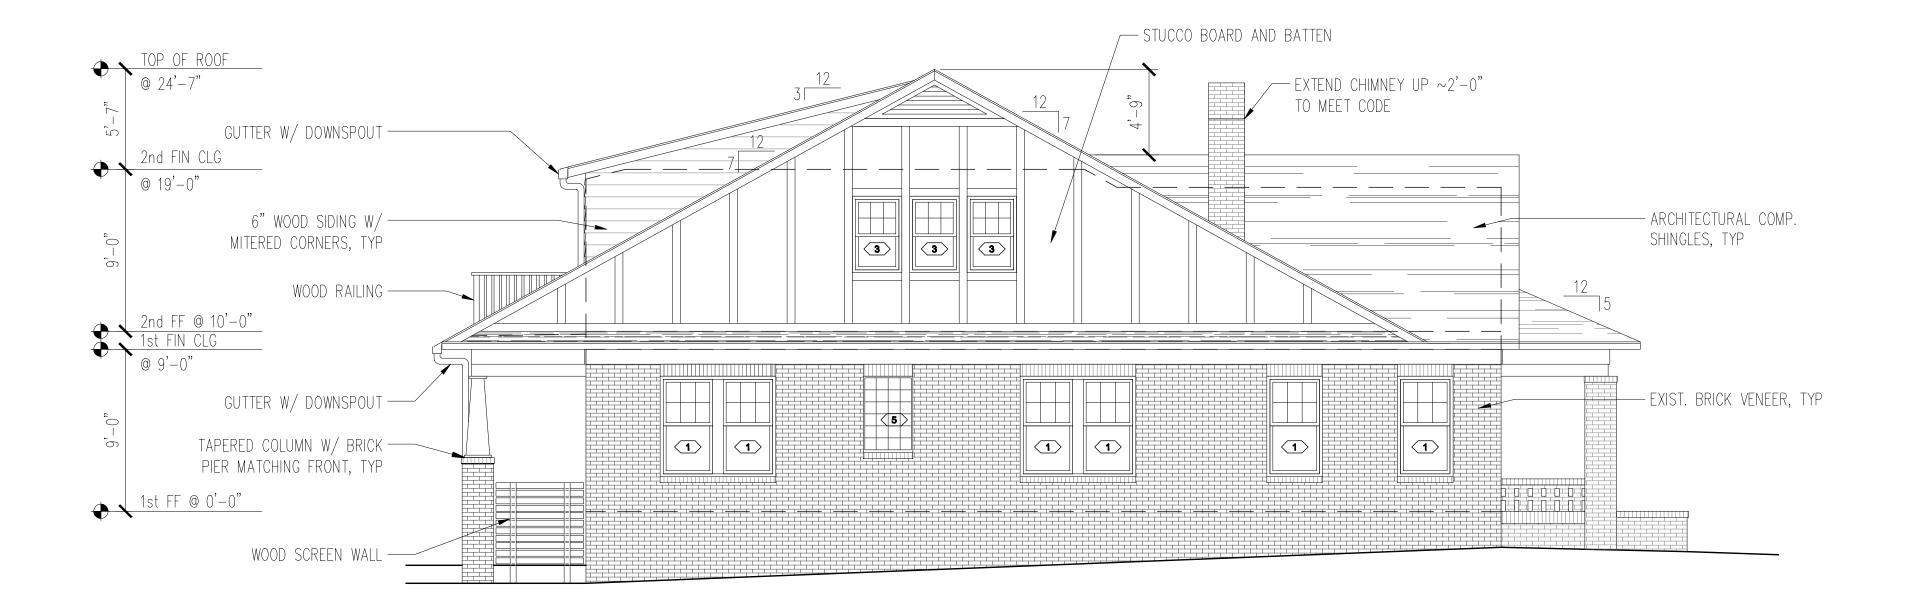






**ELEVATION** PHILLIPS RESIDENCE 812 LEXINGTON AVE CHARLOTTE, NC 28203 LEFT


KEVIN & STACY PHILLIPS

13137 KOP IOOUE DATE: 5/1/14

## **JUNE 2014**

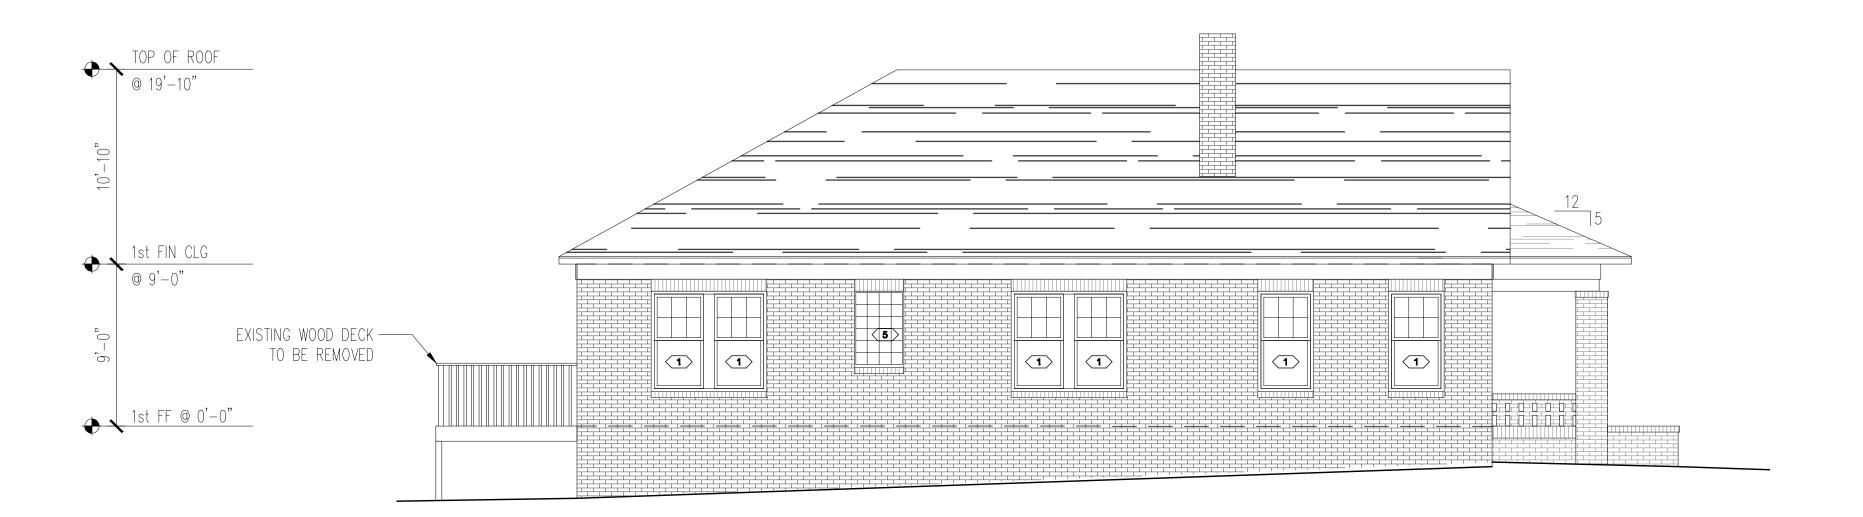

## EXISTING LEFT ELEVATION 3/16" = 1'-0"

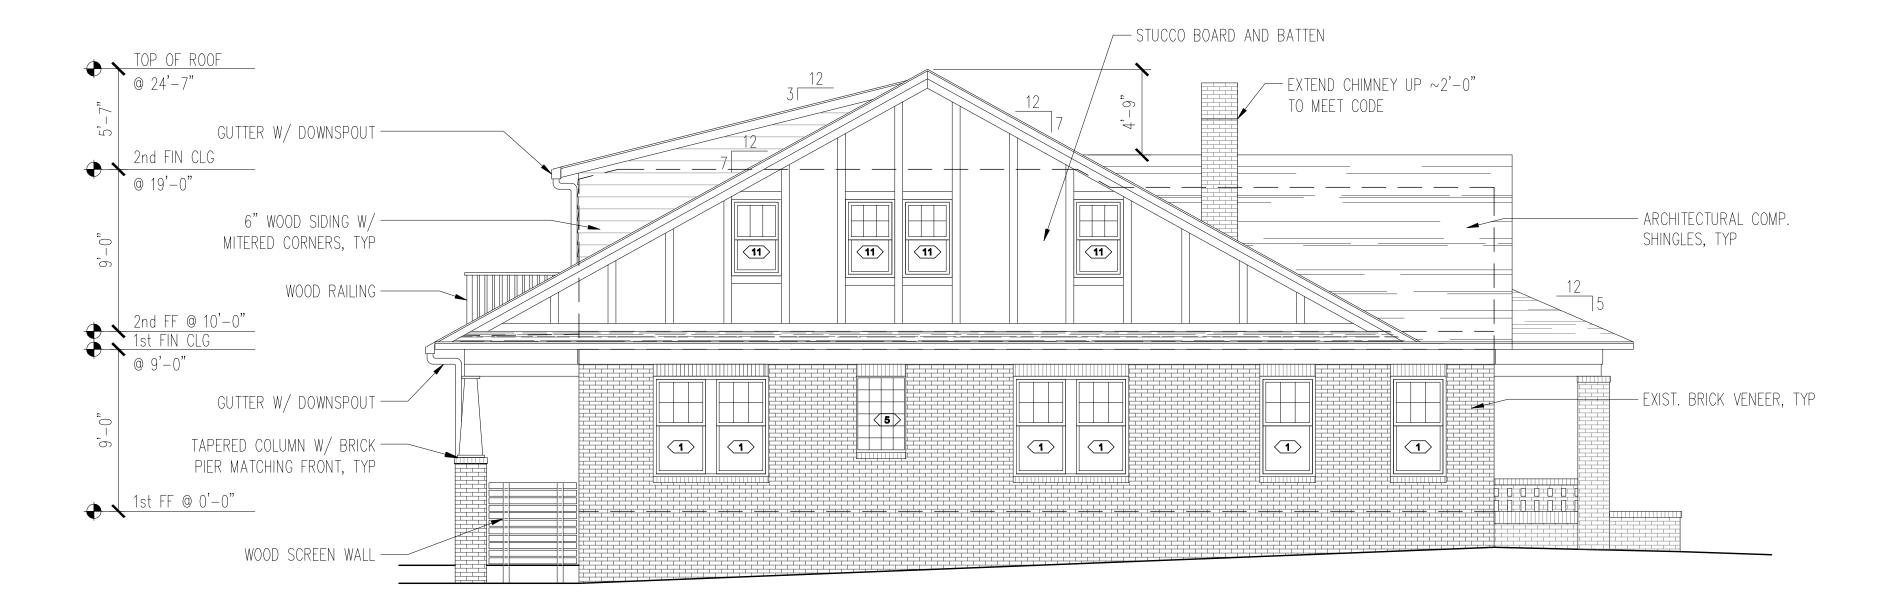



STANDING STRONG STRUCTURAL ENGINEERING

PHILLIPS RESIDENCE 812 LEXINGTON AVE CHARLOTTE, NC 28203


**ELEVATION** 

LEFT


KEVIN & STACY PHILLIPS

13137 KOP IOOUE DATE: 6/1/14

<u>NOTE:</u> SEE DRAWING A3 FOR WINDOW AND DOOR SCHEDULE.

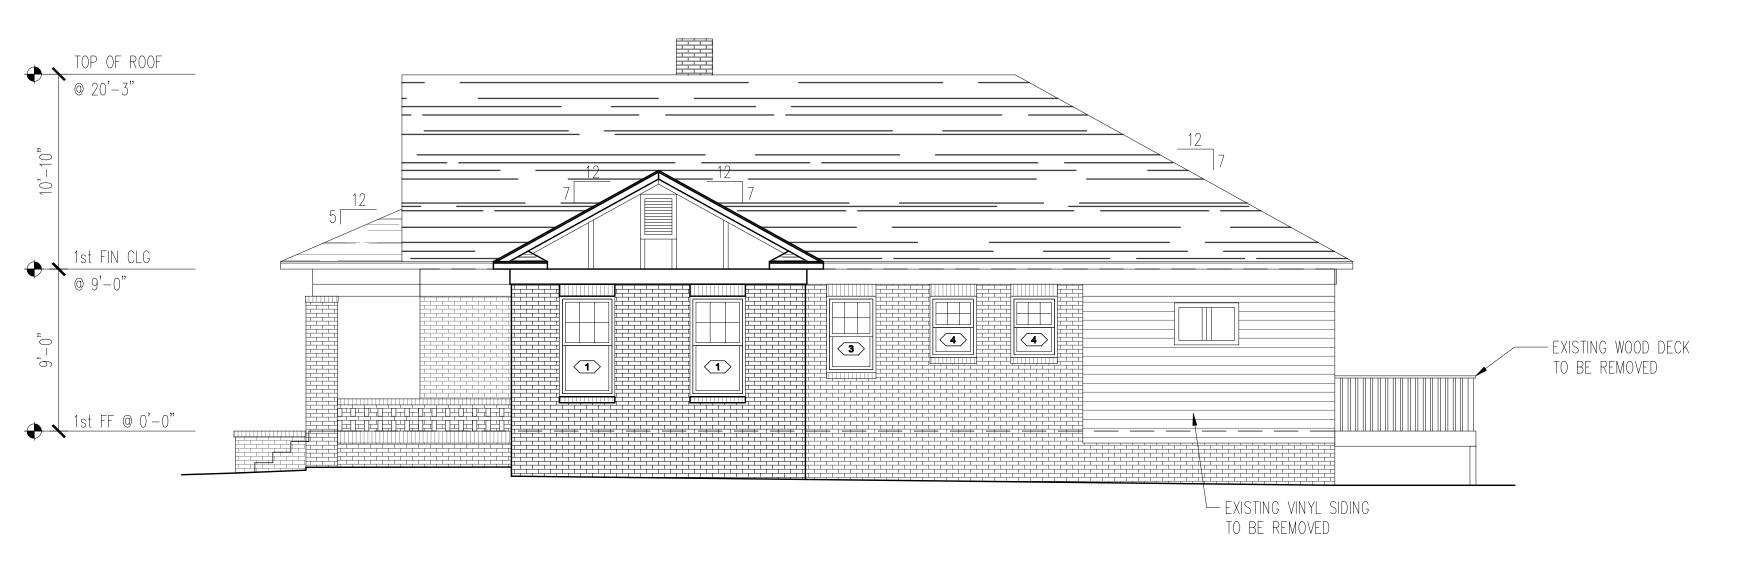

## EXISTING RIGHT ELEVATION 3/16" = 1'-0"

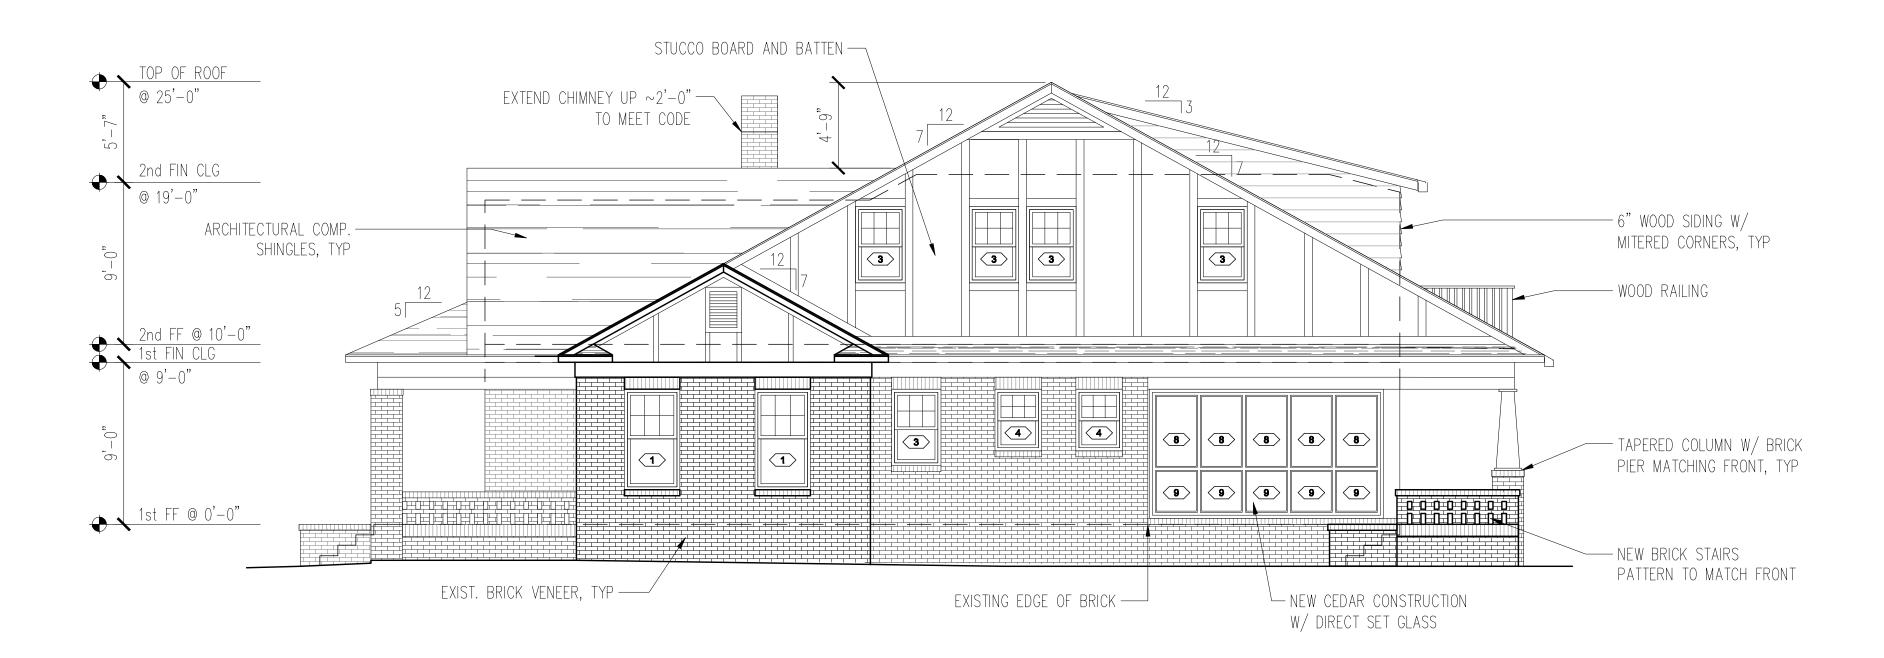



STANDING STRUCTURAL E

G STRONG ENGINEERING

RIGHT ELEVATION PHILLIPS RE 812 LEXINGTON AVE CHARLOTTE, NC 28203

RESIDENCE

KEVIN & STACY PHILLIPS


13137 KOP ISSUE DATE: 5/1/14

<u>NOTE:</u> SEE DRAWING A3 FOR WINDOW AND DOOR SCHEDULE.

### **JUNE 2014**



# 1 EXISTING RIGHT ELEVATION 3/16" = 1'-0"

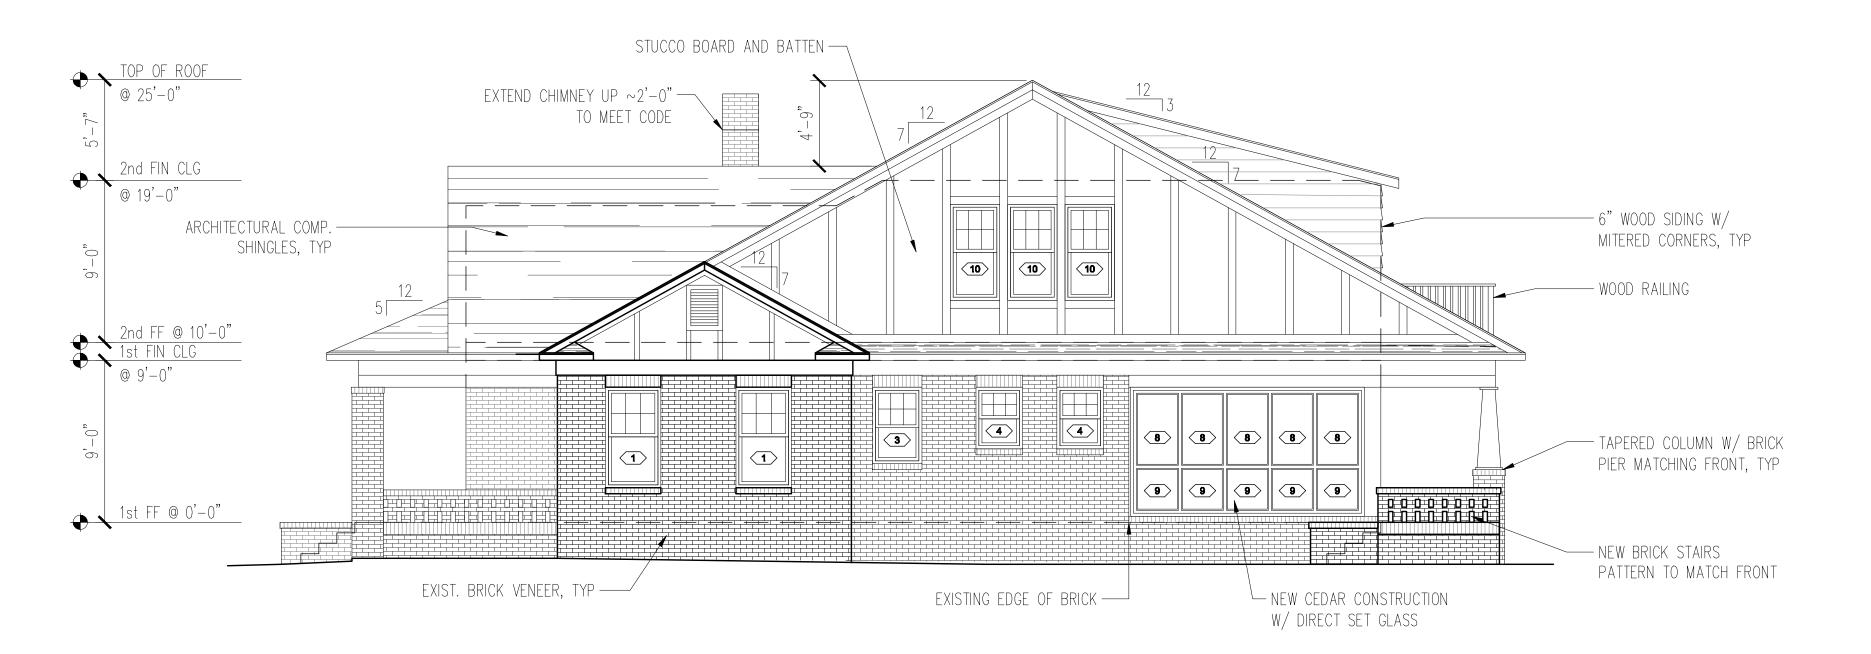



STRUCTURAL E
STRUCTURAL E

G STRONG ENGINEERING

PHILLIPS RESIDENCE 812 LEXINGTON AVE CHARLOTTE, NC 28203

RIGHT ELEVATION

CLENT:
KEVIN & STACY PHILLIP

KEVIN & STACY PHILLIPS

PROJECT NUMBER: 13137
PHASE: CD
DRAWN BY: KOP
COPYRIGHT: 888E
168UE DATE: 6/1/14















