

APPROVED BY
CITY COUNCIL
FEB 19 2007
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1313 N. Tryon St.
Charlotte, NC 28206
Tel: 704.376.1956
Fax: 704.376.7122
123 W. Main St., Ste. 620
Charlotte, NC 28202
Tel: 919.668.6200
Fax: 919.668.8900

Millennium Design Group
ARCHITECTURE

DATE	DESCRIPTION
1/24/07	Rezoning revision


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STONEHUNT (104) 609-4556
CHERRY TOWN HOMES & SENIOR LIVING
CHARLOTTE, NC

NO.	DATE	DESCRIPTION
1	1/24/07	Rezoning revision

DATE: 12-26-2006
SCALE: AS NOTED
DRAWN BY: HJ
CHECKED BY: AVH
JOB NO.:
CAD FILE: STONEHUNT12206.rvt
SHEET NO:

C0100

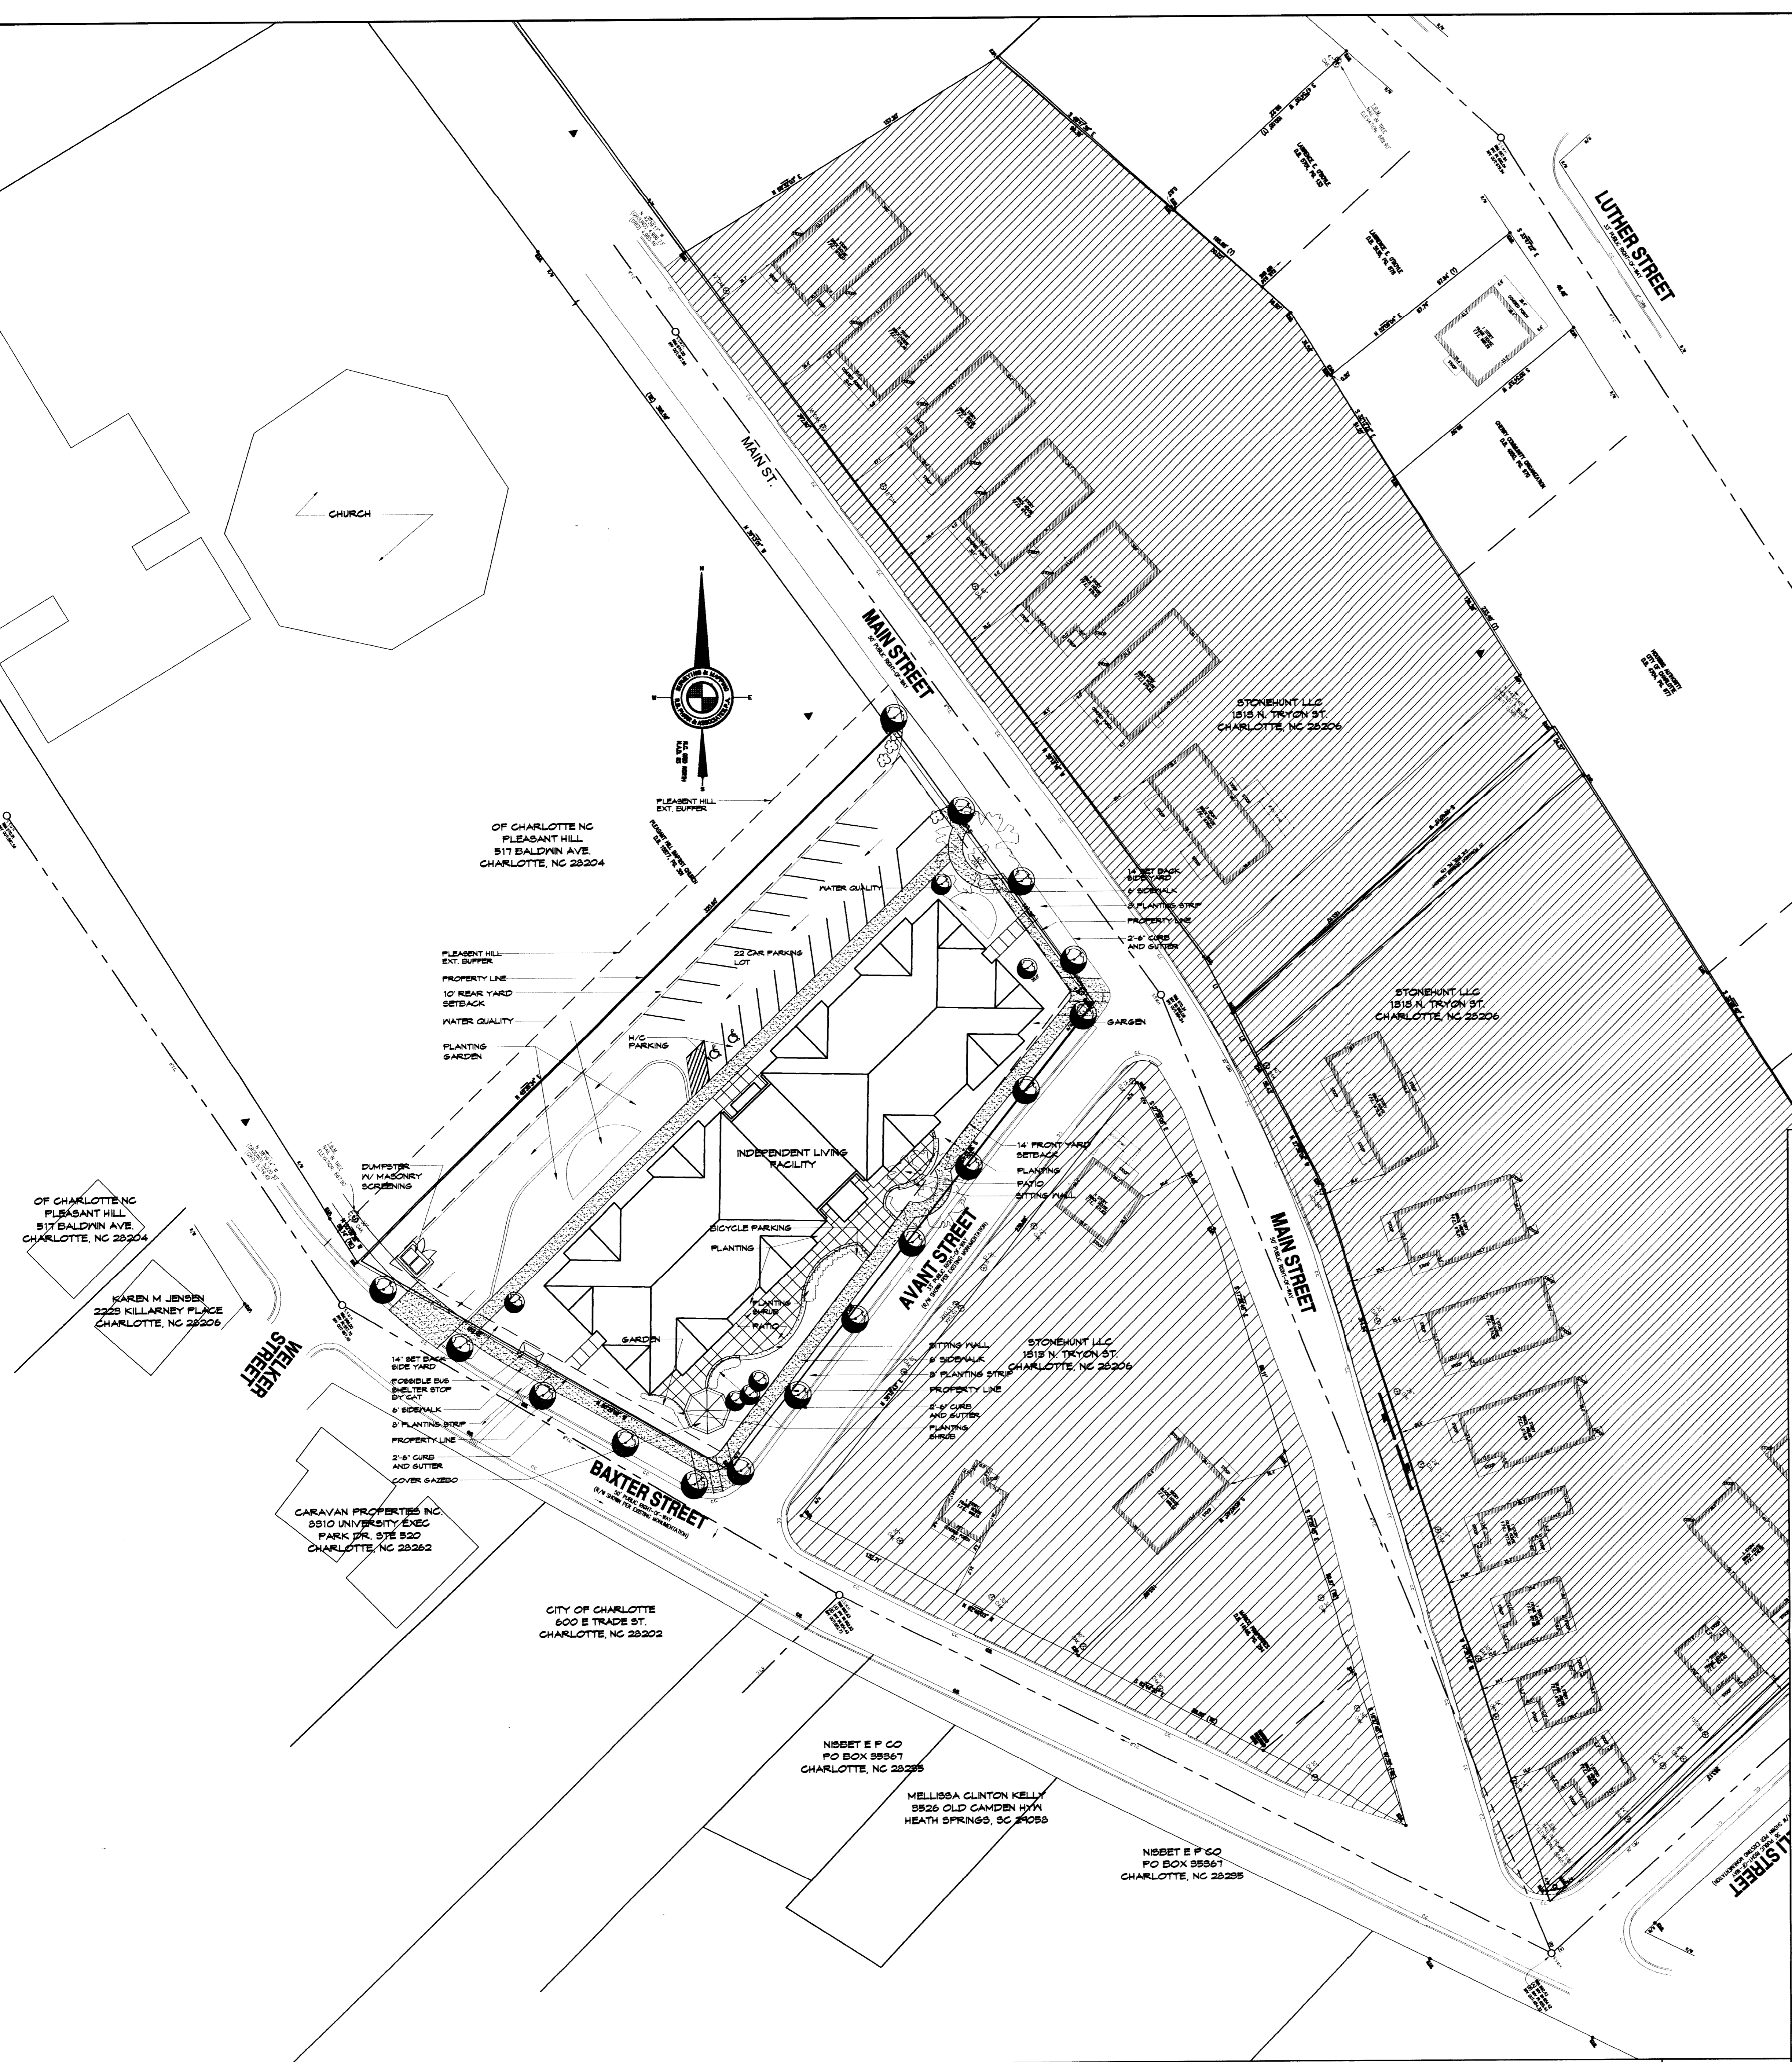

SITE LEGEND	
EXISTING ZONING	R-8
PROPOSED ZONING	UR-2(CD)
PROPOSED USE	INDEPENDENT LIVING FACILITY (42 UNITS)
SITE ACREAGE	1.0482
TAX PARCEL# FOR UR-2 (CD)	12528406
PARKING REQ.	22
6.61% TREE SAVE AREA	
ARE NOT INCLUDED FOR REZONING	

- General Notes:
- Development of the site will be controlled by the standards depicted on this site plan by the standards of the city of Charlotte, NC zoning ordinances. The development depicted on this plan is intended to reflect the arrangement of proposed uses on the sites, but the exact configuration, placement, and size of individual site elements may be altered or modified within the limits prescribed by the ordinance during the design development and construction phases per section 6.2 of the zoning ordinance.
 - Screening will comply with the applicable standards set forth in section 12.209 of the city of Charlotte zoning ordinance.
 - Parking meets the standards of the table 12.202 of the city of Charlotte zoning ordinance.
 - Maximum building height shall be 40 feet.
 - The dumpster's will be screened by a 6' solid wood fence or a solid masonry fence with a solid wood gate.
 - All proposed trees, fences and signs will not interfere with sight distance at the entrance of the site. Any fence requiring a certificate will be obtained from the cdd.
 - A standard 2'-6" curb and gutter, associated storm drainage along with a 6' sidewalk, 2' feet planting strip, and with out side lighting that will be tall cut-off at 15 feet high maximum along Luther st., Avant st., and Main st. will be provided. (A six foot wide sidewalk will be constructed by the petitioner along avant street, luther st., main st., and baxter street. Typical there will be an eight foot planting strip between curb and sidewalk. However, planting strip width may be reduced to protect existing trees along streets, with prior approval from urban forestry staff.)
 - NA

- No storm water detention in buffer or setbacks.
- The sidewalk may meander and the planting width may vary to save trees 6" in caliper and larger.
- All utilities to be underground.
- Pedestrian scale lighting will be installed and will not exceed 15' feet in height. No "wall pak" lighting will be installed, but architectural lighting on building facades will be permitted. (lighting at 15 feet high maximum.)
- Signage will be permitted in accordance with applicable zoning standards.
- Storm water Quantity Control: The petitioner shall tie-in to the existing storm water system(s). The petitioner shall have the receiving drainage system(s) analyzed to ensure that it will not be taken out of standard due to the development. If is found that development will cause the storm drainage system(s) to be taken out of standard, the petitioner shall provide alternate methods to prevent this from occurring.
- The developer will provide storm water quality treatment; for projects with defined watersheds greater than 24% built-upon area, construct water quality best management practices (BMPs) to achieve 58% Total Suspended Solid (TSS) removal for the post-development runoff volume for the runoff generated from the first 1-inch of rainfall within the proposed parking areas BMPs must be designed and constructed in accordance with the NC Department of Environment and Natural Resources (NCDENR) best management practices Manual, April 1999, section 4.0 (Design Standards shall be met occurring to the city of Charlotte best management practices manual, when available).
- The developer will provide volume and peak control; for projects with defined watersheds greater than 24% built-upon areas, control the entire volume for the 1 year, 24-hour storm. Runoff volume draundown time shall be a minimum of 24 hours, but not more than 120 hours.
- The petitioner acknowledges that other standard development requirements imposed by other city ordinances, standards, policies, and appropriate design manuals will exist. Those criteria (for example, those that required buffers, regulate streets, sidewalk, trees, storm water, and site developments, etc.) will apply to the development site. This includes chapters 6, 9, 12, 17, 18, 20, and 21 of the city code. Conditions set forth in this petition are supplemental requirements imposed on the development in addition to other standards. Where conditions on this plan differ from ordinances, standards, policies, and approaches in existence at the time of formal engineering plan review submission, the stricter condition or existing requirements shall apply.
- Throughout this rezoning petition, the terms "Owners", "Owners", "Petitioners" shall, with respect to the site, be deemed to include the heirs, devisees, personal representatives, successors in interest and assignees of the owner or owners of the site who may be involved shall apply.
- There will be under ground storm water detion system put in place