
LOCAL HISTORIC DISTRICT: Wilmore

PROPERTY ADDRESS: 1818 Wickford Place, Lot 1

SUMMARY OF REQUEST: New Construction

APPLICANT: Craig Calcasola

Details of Proposed Request

Existing Conditions

The existing structure is a one story single family house constructed in 1938 and located on the edge of the District. The HDC placed a 365-day Stay of Demolition on the property January 13, 2016. The parcel is zoned R-43 Multi-Family and is approximately .34 acres in size. The lot dimension is 150' x 100'. Adjacent uses are multi-family, industrial, commercial and single family. There are mature trees on the site. Trees to be saved, replaced or removed are identified on the plans. The parcel has been rezoned to Urban Residential-1 to construct four single family houses. The required minimum setback is 14', required minimum rear yard is 10' and required minimum lot width is 20'. The Floor Area Ratio (FAR) does not apply to single family structures on individual lots. 2019 Update: The structure has been demolished and all four parcels are currently vacant lots.

Proposal

The proposal is the construction of four single family structures with a focus on house plans for each lot and overall site layout for the four structures. Proposed lot dimensions are 37.5' x 100'. There are two models being proposed and will be identified as Lot/Plan 1, 2, 3 and 4. The setback of the proposed house for Lot 1 is the same as the existing structure which will set the location for Lots 1-4. All homes are 1.5 stories (approx. 23' to 28' in height), and feature front porches 8' in depth, wood siding, wood windows, brick foundations, and wood corner boards. The applicant is requesting cementitious siding for the porch columns and soffits.

The underlying zoning will require an 8' planting strip and 6' sidewalk. New landscaping and tree save opportunities are shown on the site plan. Included in the plan is a new private alley at the rear for the four houses. The revised plans also include numeric evidence of comparable lot coverages in the neighborhood, pervious area more clearly shown on the site plan and updated window design and placement.

Staff Recommendation

1. The original project, voted on by the HDC in April 12, 2017, is considered null and void due to inactivity.
2. HDC 2016-321_1816 Wickford Place (Lot 1) Motion, April 12, 2017: Approve with Conditions.

*“Based on compliance with **Policy & Design Guidelines – New Construction** Mr. Henningson made a **MOTION to APPROVE** this application with revised drawings to staff for probable approval. The revised drawings will include below for the lots - numbers one, two, and three.*

- *Miratek installed on columns, corners, fascia*
- *Windows– Take brick casing off, 4” wide non- tapered trim with 7/8 inch putty glaze*
- *Roof overhang extended to 24 inches at right angle to siding*
- *¾ individual V-groove bead board soffit*
- *2X8” barge rafters with bed mold installed base*
- *Tree protection plan*
- *Corner boards are to be equal to 5 ½ inches*

Ms. Stephens seconded.”

3. Roof overhang not changed per condition.
4. V-groove bead board soffit not noted on plans.
5. Staff concern over Elevation Notes on A3.1 that German-style siding, door, and window styles to be selected by owner.
6. The project is not incongruous with the district and meets guidelines for New Construction.
7. Staff Recommends reinstating the **Approval with Conditions with Staff to work with applicant**, per 10.4.1 of the Rules for Procedure.
8. If requested by a Commission member, or if an interested party has signed up to speak in opposition, then the HDC shall open the application for a full hearing.




HDC-2019-00363


PID: 11907749

LOCAL HISTORIC DISTRICT: WILMORE
PROPOSED PROJECT: CONSENT AGENDA

July Meeting 2019

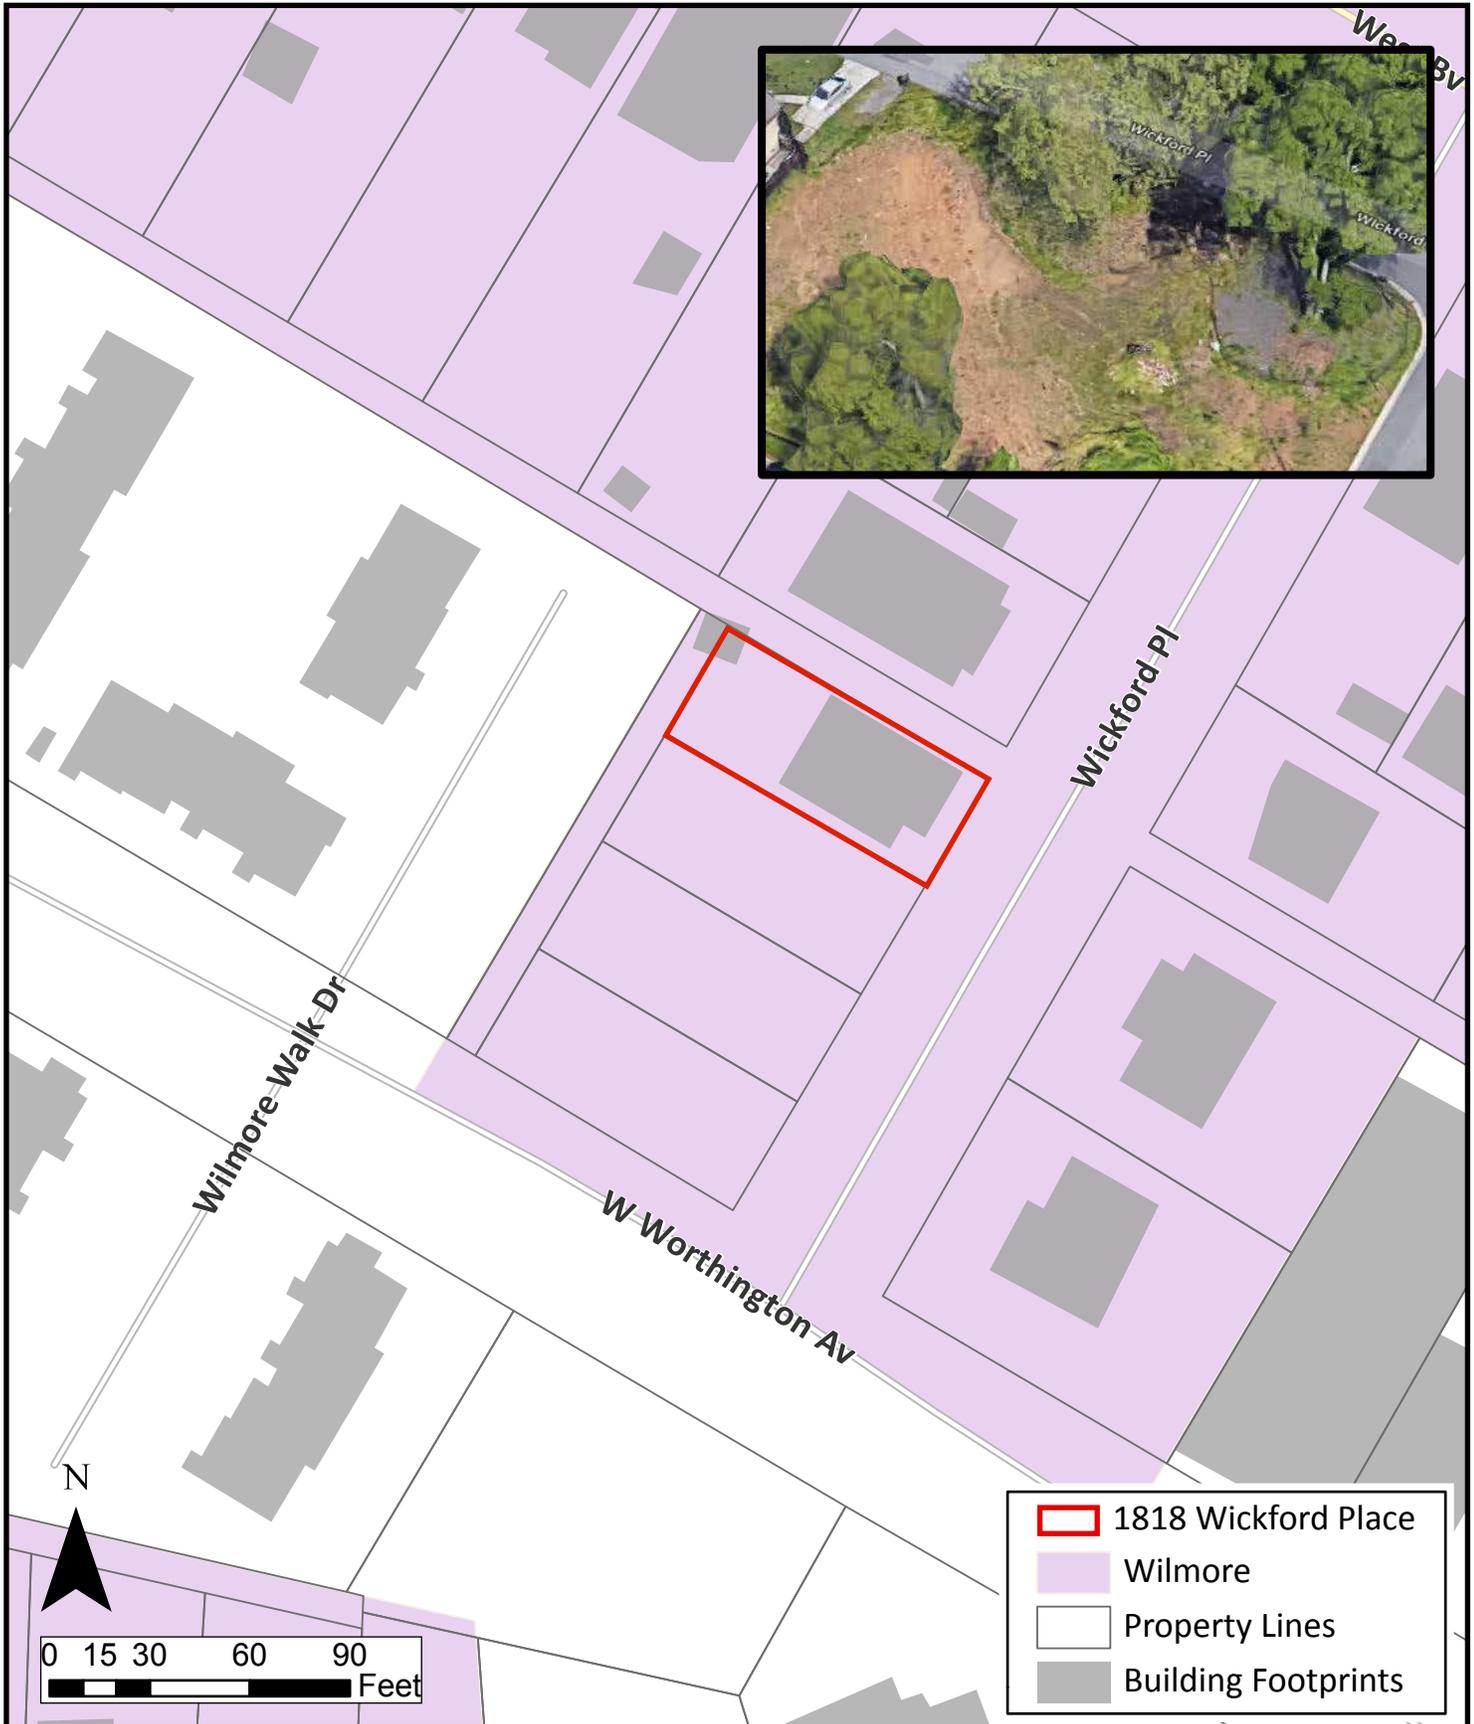


VICINITY MAP

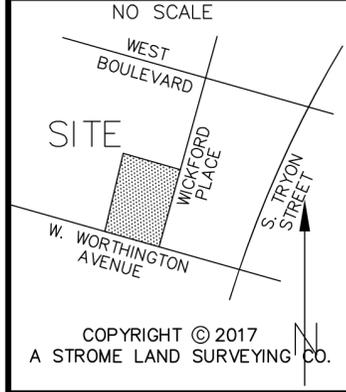

COPYRIGHT © 2017
A STROME LAND SURVEYING CO.

VICINITY MAP
(Not to Scale)

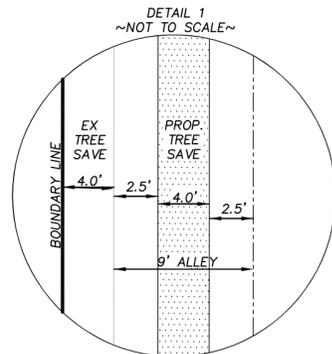

NOTES

1. AREA CALCULATED BY COORDINATE COMPUTATION.
2. ADJOINING PROPERTY OWNERS NAMES WERE TAKEN FROM MECKLENBURG COUNTY TAX OFFICE RECORDS, AND ARE CONSIDERED AS NOW OR FORMERLY.
3. IRON RODS AT ALL CORNERS UNLESS NOTED.
4. THIS MAP IS SUBJECT TO ANY AND ALL APPLICABLE DEED RESTRICTIONS, EASEMENTS, RIGHT-OF-WAY, UTILITIES AN RESTRICTIVE COVENANTS AND PRELIMINARY PLAN WHICH MAY BE OF RECORD.
5. ALL DISTANCES ARE HORIZONTAL GROUND DISTANCES, MEASURED WITH ELECTRONIC MEASURING DEVICES.
6. LOT SUBJECT TO ALL ZONING ORDINANCES OF CITY OF CHARLOTTE. BUILDER/OWNER MUST VERIFY THAT LOT IS IN COMPLIANCE WITH ALL COUNTY AND HOMEOWNERS ASSOCIATION ZONING ORDINANCES PRIOR TO ANY LAND DISTURBANCE OR CONSTRUCTION.
7. THIS SURVEY WAS PERFORMED WITHOUT THE BENEFIT OF A TITLE SEARCH.
8. NO NCGS MONUMENT FOUND WITHIN 2000 FEET.
9. OFF SITE RIGHT OF WAYS SHOWN FOR ILLUSTRATIVE PURPOSES ONLY.
10. NO OBSERVED EVIDENCE OF CEMETERIES OR BURIAL GROUNDS NOR WERE ANY REPORTED TO THIS FIRM.
11. NO OBSERVED EVIDENCE OF SITE BEING USED AS AS SOLID WASTE DUMP, SUMP, OR SANITARY LANDFILL.
12. MAINTENANCE OF THE PRIVATE ALLEY AND TREE SAVE WILL BE THE RESPONSIBILITY OF THE PROPERTY OWNER OR ASSIGN.
13. SIDEWALK AND UTILITY EASEMENT MEASURED FROM BACK OF SIDEWALK.
14. TREE SAVE AREA PER CITY TREE ORIDANCE

LEGEND

RF	REBAR FOUND
RS	REBAR SET
R/W	RIGHT-OF-WAY
SF	SQUARE FEET
MB	MAP BOOK
DB	DEED BOOK
PG	PAGE
BOUNDARY LINE	_____
ADJOINER LINE	_____
RIGHT OF WAY	_____
EASEMENT	_____
	TREE SAVE
#0000	LOT ADDRESS

FLOOD NOTE:
NO PORTION OF THE SUBJECT PROPERTY SHOWN HEREON LIES WITHIN A SPECIAL FLOOD HAZARD AREA PER F.E.M.A. FLOOD INSURANCE RATE MAP, COMMUNITY PANEL 3710454300L, DATED: SEPTEMBER 02, 2015.

LINE	BEARING	DISTANCE
T1	N 32°21'43" E	12.95'
T2	N 30°35'30" E	113.62'
T3	S 59°24'30" E	4.00'
T4	S 30°35'30" W	113.68'
T5	S 32°21'43" W	12.83'
T6	N 60°19'53" W	4.00'
T7	N 89°12'16" E	7.03'

LINE	BEARING	DISTANCE
L1	N 30°24'00" E	10.29'
L2	N 33°20'25" E	10.05'

GRAPHIC SCALE



(IN FEET)
1 inch = 20 ft.

CARLOS ORITZ &
RACHEL ORITZ
NOW OR FORMERLY
LOT 3 BLCOK 16
DB 19362 PG 430
MB 332 PG 96
PARCEL ID # 119-077-12

BRENDAN TINDALL &
KARYN TINDALL
NOW OR FORMERLY
PART OF LOT 1 & LOT 2
DB 32258 PG 689
MB 332 PG 96
PARCEL ID # 119-077-09

10' ALLEY WAY per
MB 332 PG 96
(UNOPENED)

10' ALLEY WAY per
MB 332 PG 96
(UNOPENED)

EXISTING TREE SAVE PER
MB 63 PG 746

PROPOSED TREE SAVE
506 SF
IN MIDDLE OF CONCRETE
DRIVEWAY STRIPS FOR
PRIVATE ALLEY

10' COMMON OPEN SPACE
0.034 AC
1,498 SF
MB 63 PG 746
TAX ID# 119-077-50

PRIVATE 9'
ALLEY EASEMENT
SEE DETAIL #1

WILMORE WALK
CONDOMINIUM
UNIT FILE # 749 PG 1

14' SETBACK FROM
BACK OF CURB
ALONG BACK OF
PROPOSED WALK

W WORTHINGTON AVENUE
60' PUBLIC R/W
per MB 63 PG 746

EXISTING CURB

R/W

"I, CHEVIS L. KING, CERTIFY THAT THIS PLAT WAS DRAWN UNDER MY SUPERVISION FROM AN ACTUAL SURVEY MADE UNDER MY SUPERVISION (DEED DESCRIPTION RECORDED IN BOOK 32121, PAGE 927; THAT THE RATIO OF PRECISION AS CALCULATED IS 1:10,000; THAT THIS PLAT WAS PREPARED IN ACCORDANCE WITH G.S. 47-30 AS AMENDED. WITNESS MY ORIGINAL SIGNATURE, REGISTRATION NUMBER AND SEAL THIS 17th DAY OF JULY, A.D., 2018.

PRELIMINARY
NOT FOR SALES OR CONVEYANCES



PROFESSIONAL LAND SURVEYOR

L-5188

That this plat is of a survey that creates a subdivision of land within the area of a county or municipality that has an ordinance that regulates parcels of land.

STATE OF NORTH CAROLINA
MECKLENBURG COUNTY

I, _____, REVIEW OFFICER OF MECKLENBURG COUNTY, N.C. CERTIFY THAT THE MAP OR PLAT TO WHICH THIS CERTIFICATION IS AFFIXED MEETS ALL STATUTORY REQUIREMENTS FOR RECORDING.

REVIEW OFFICER

DATE

APPROVED IN ACCORDANCE WITH THE PROVISIONS OF CH 20 (SUBDIVISION ORDINANCE) OF THE CITY CODE OF THE CITY OF CHARLOTTE, NORTH CAROLINA
CHARLOTTE-MECKLENBURG PLANNING DEPARTMENT

PLANNING DEPARTMENT STAFF

DATE

THIS PROPERTY IS LOCATED IN THE CHARLOTTE HISTORIC DISTRICT.

DEVELOPMENT DATA:
PROPERTY AREA IS 15,029 SF, 0.345 AC

ZONING PER CASE 2017-162
UR-1 (CD)
MINIMUM LOT SIZE- 3,000 SF
FRONT SETBACK- 21.5' FROM BACK OF CURB (WICKFORD PLACE)
14' FROM EXISTING CURB (WORTHINGTON AVENUE)
SIDE- 5'
REAR-10'
MAXIMUM BUILDING HEIGHT- 40'
MINIMUM LOT WIDTH- 35'


TREE SAVE AREA PROVIDED- 1,782 SF (11.8%)

PURPOSE STATEMENT

THE PURPOSE OF THIS PLAT IS RELOCATE THE TREE SAVE FROM LOT 4 TO THE PRIVATE ALLEY AS SHOWN. ALSO, TO REVISE THE 2' SIDEWALK AND UTILITY EASEMENT TO 1'. THIS PLAT REPLACES AND SUPERCEDES MB 63 PG 746 AS RECORDED IN THE MECKLENBURG REGISTRY.

REVISED FINAL PLAT

AT PROPERTY KNOWN AS
LOTS 1-4, TREESAVE & COS
WICKFORD PLACE
MB 63 PG 746
DB 30469 PG 385
CITY OF CHARLOTTE, MECKLENBURG COUNTY, NC
DATE: JUNE 8, 2019

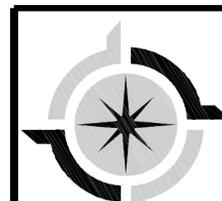

CAROLINA
GEOMATICS
PLLC

3833 STREAMSIDE DR
GASTONIA, NC 28056


P (980) 329-3382

CKING@CAROLINAGEOMATICS.COM
NC #P-1965

OWNER:
RCMD, LLC
15617 SULLIVAN RIDGE DRIVE
CHARLOTTE, NC 28277

Job No.:	Drawn:	Checked:	Date:
014-19-001	CLK	CLK	06/08/19

SURVEY

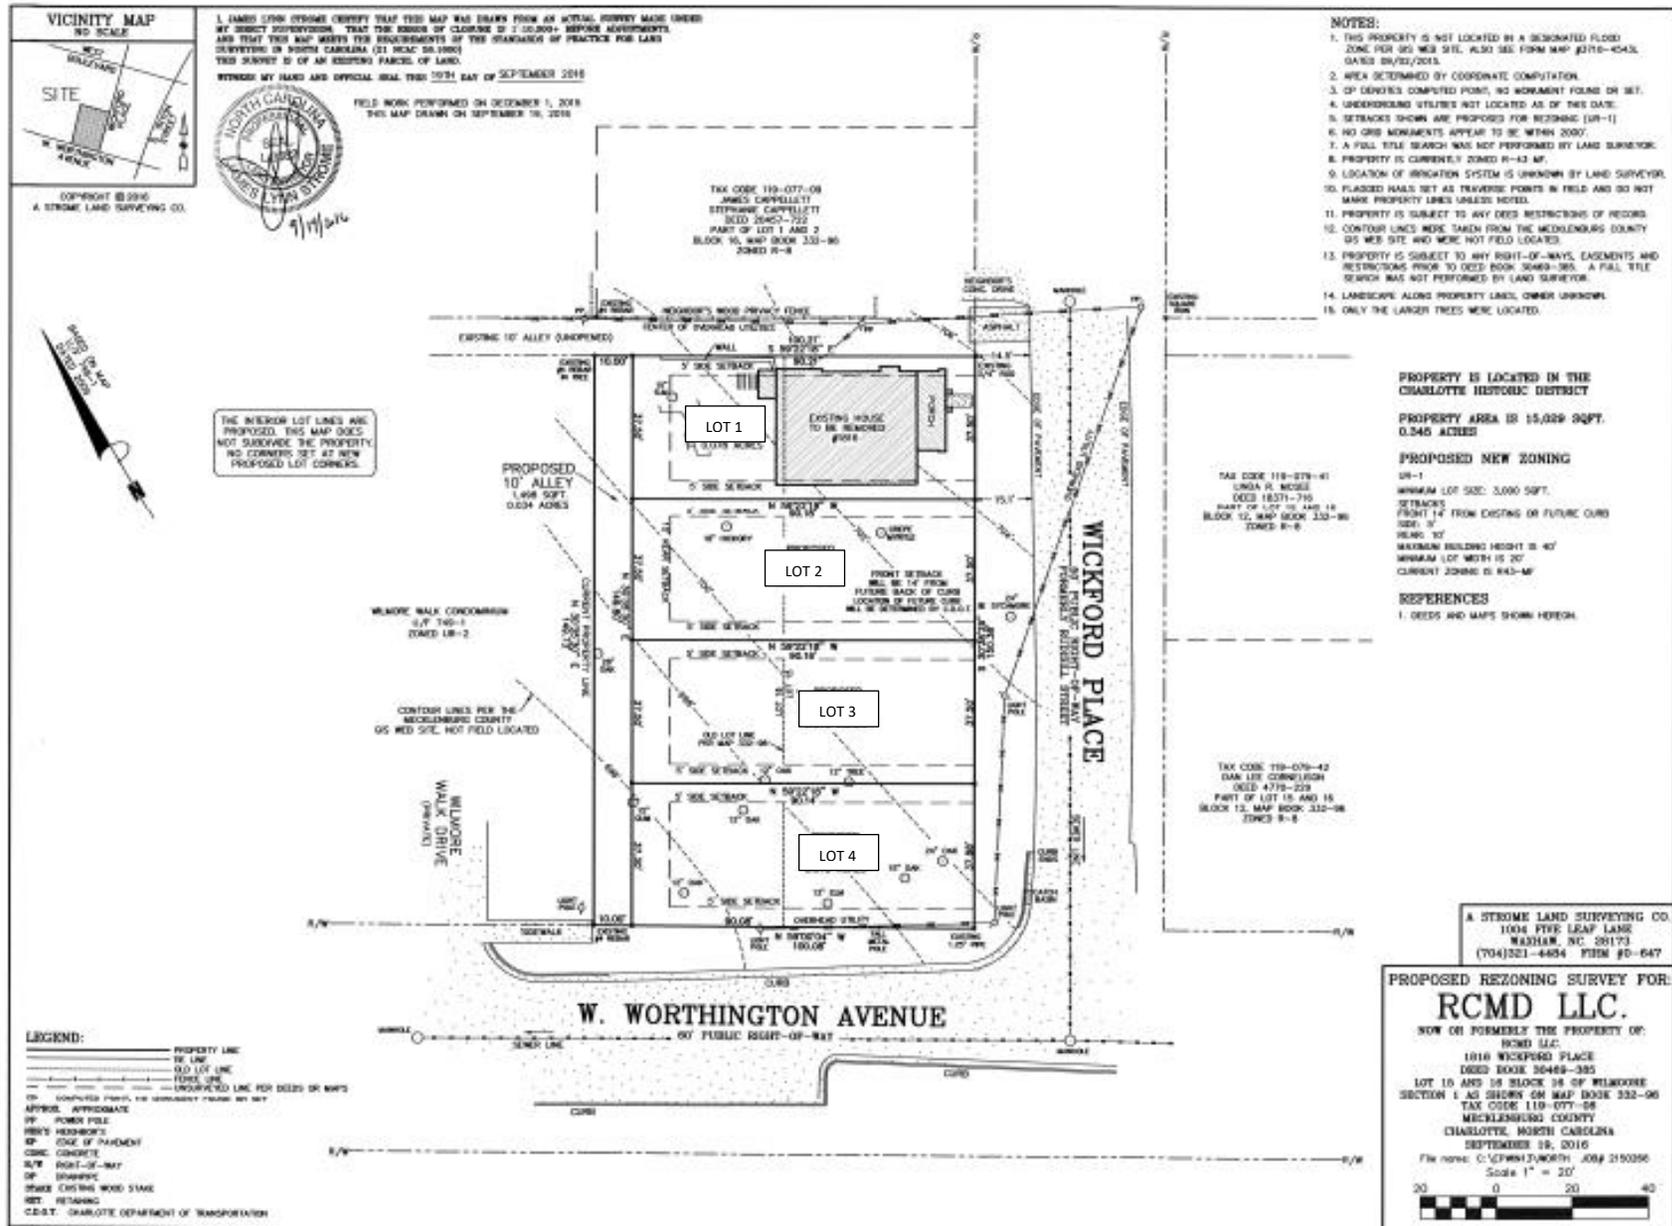

TYP. HANGERS FOR JOIST & BEAMS

NOTE: ALL HANGERS BY SIMPSON STRONG TIE CO., INC. (BRAND-NAME EQUIVALENTS ACCEPTABLE)

MEMBERS	HANGER
2x8	LUS28
2x10	LUS210
2x12	LUS212
(2) 2x8	HUS28-2
(2) 2x10	HUS210-2
(2) 2x12	HUS212-2
(3) 2x8	LUS28-3
(3) 2x10	LUS210-3
(3) 2x12	HUZ12-3 MIN.
(2) 1-3/4"x9-1/4" LVL	HGUS410
(2) 1-3/4"x9-1/2" LVL	HGUS410
(2) 1-3/4"x11-1/4" LVL	HGUS412
(2) 1-3/4"x11-7/8" LVL	HGUS412
(2) 1-3/4"x14" LVL	HGUS414
(2) 1-3/4"x16" LVL	HGUS414
(2) 1-3/4"x18" LVL	HGUS414
(3) 1-3/4"x9-1/4" LVL	HGUS5,501/10
(3) 1-3/4"x9-1/2" LVL	HGUS5,501/10
(3) 1-3/4"x11-1/4" LVL	HGUS5,501/12
(3) 1-3/4"x11-7/8" LVL	HGUS5,501/12
(3) 1-3/4"x14" LVL	HGUS5,501/14
(3) 1-3/4"x16" LVL	HGUS5,501/14
(3) 1-3/4"x18" LVL	HGUS5,501/14
(4) 1-3/4"x9-1/4" LVL	HGUS7,251/10
(4) 1-3/4"x9-1/2" LVL	HGUS7,251/10
(4) 1-3/4"x11-1/4" LVL	HGUS7,251/12
(4) 1-3/4"x11-7/8" LVL	HGUS7,251/12
(4) 1-3/4"x14" LVL	HGUS7,251/14
(4) 1-3/4"x16" LVL	HGUS7,251/14
(4) 1-3/4"x18" LVL	HGUS7,251/14

HEADER SIZE REQUIREMENTS

SIZES	EXTERIOR SPANS	INTERIOR SPANS	JACK STUDS
(2) 2x8s	< 2'-0"	< 2'-6"	1
(2) 2x8s	2'-0" thru 3'-0"	2'-6" thru 3'-6"	2
(2) 2x10s	3'-0" thru 5'-0"	3'-6" thru 6'-6"	2
SEE PLAN	5'-0" <	6'-6" <	SEE PLAN

WALL STUD REQUIREMENTS

EXTERIOR WALL HEIGHT	STUD SIZE AND SPACING
H < 10'-0"	2x4 @ 16" o.c.
10'-0" < H < 11'-0"	2x4 @ 12" o.c.
10'-0" < H < 11'-0"	2x6 @ 16" o.c.
H > 18'-0"	CONSULT ENGINEER

GENERAL PLAN NOTES

- DRAWINGS ARE NOT TO BE SCALED. DIMENSIONS IN QUESTION SHALL BE CLARIFIED BY ARCHITECT.
- ALL EXTERIOR DIMENSIONS ARE SHOWN TO THE OUTSIDE FACE OF STUD, UNLESS NOTED OTHERWISE.
- ALL INTERIOR DIMENSIONS ARE SHOWN TO THE INSIDE FACE OF STUD, UNLESS NOTED OTHERWISE.
- ALL INTERIOR WALLS ARE ASSUMED TO BE 3-1/2" WOOD STUDS, UNLESS NOTED OTHERWISE.
- ALL EXTERIOR WALLS ARE ASSUMED TO BE 3-1/2" WOOD STUDS (PLUS 1/2" EXTERIOR WALL SHEATHING); UNLESS NOTED OTHERWISE.
- ALL DOORS TO BE CENTERED, UNLESS NOTED OTHERWISE.
- PROVIDE WOOD BLOCKING IN WALLS FOR MOUNTING OF ALL CABINETS, TOILET ACCESSORIES AND OTHER WALL MOUNTED ITEMS.
- ALL CABINETRY TO BE DESIGNED BY OTHERS AND SHALL MEET ALL APPLICABLE ACCESSIBILITY CODES (IF REQUIRED)
- ALL FINISH AND COLOR SELECTIONS TO BE APPROVED BY ARCHITECT/CLIENT.
- NUMBER OF EXTERIOR RISERS TO BE FIELD VERIFIED, AT LOCATIONS WHERE 4 OR MORE ARE REQUIRED A HANDRAIL WILL ALSO BE REQUIRED.
- PROVIDE TERMITE CHEMICAL AT FOUNDATION, AS REQUIRED.
- MINIMUM 22-1/2" (w) x 54-1/2" (l) ATTIC ACCESS DOOR w/ PULL DOWN LADDER TO BE DETERMINED ON SITE AND WEATHERSTRIPPED AND INSULATED WITH MIN. R-5.
- HVAC RETURN (S) TO BE DETERMINED ON SITE.
- ALL COUNTERTOPS TO BE 3/4" AFF. UNLESS NOTED OTHERWISE.
- ALL DOOR HEIGHTS ARE SHOWN ON PLANS.

FRAMING CONSTRUCTION-OTHER THAN ROOF

- STEEL BEAMS MUST HAVE (3) 2x4 STUD JACKS UNDER EACH END SUPPORT, UNLESS NOTED OTHERWISE.
- MICRO-LAM BEAMS, SEE S0.1, CONSTRUCTION OTHER THAN ROOFS, NOS. 7
- ALL BRICK OVER LOWER ROOFS MUST HAVE ANGLE WITH STOPS LAG SCREWS TO STUDS ABOVE AND ACCORDANCE WITH DETAIL.
- ALL WOOD JOISTS AND OPEN JOISTS MUST BE BRACED IN ACCORDANCE WITH MANUFACTURER'S DIRECTIONS PLUS DETAILS SHOWN ON PLANS.
- ALL RAFTER BRACES MUST HAVE 2 STUDS FROM PLATE TO FOUNDATION OR BEAM BELOW THEM AT ALL FLOORS. NO BRACES ON CEILING PLATE WITHOUT STUDS DIRECTLY UNDER THEM.
- WHERE PARTITIONS FALL BETWEEN FLOOR TRUSSES, 2"x4" LADDERS @ 16" o.c. MUST BE PLACED PERPENDICULAR TO THE TRUSSES TO SUPPORT THE PLYWOOD DECKING.
- ON ALL OPEN WEB FLOOR TRUSSES OVER A 10' SPAN A MIN. SINGLE LINE OF 2"x4" SHALL BE NAILED TO DIAGONAL MEMBERS OR VERTICAL MEMBERS IN THE APPROXIMATE MID-SPAN AS A LOAD DISTRIBUTION MEMBER.
- WHERE CEILING JOISTS ARE PARALLEL TO EXTERIOR WALLS AND RAFTERS BEAR ON STUD WALL TOP PLATE ADJACENT TO CEILING JOISTS, BRACE RAFTERS AND TOP PLATE TO 2x6 HOGS 8" LONG (MIN.) ON 6" CENTERS ALONG LENGTH OF CEILING JOISTS.
- ALL 2-STORY OPEN GREAT ROOMS, LIVING ROOMS, WITH 2 OR MORE ADJACENT OPENINGS OF 3' OR LESS MUST USE A 3-1/2"x3-1/2"x1/2" STEEL ANGLE VERTICALLY FROM FLOOR TO TOP PLATE LAGGED TO KING STUDS WITH (3) 6"x3" LAGS @ 24" o.c. VERTICALLY AND LAGGED TO FLOOR AND TOP PLATE WITH (1) 3/16"x3" LAG THROUGH A 1/4" PLATE AT THE TOP AND BOTTOM. MULTIPLE OPENINGS WITH 3' OR LESS SPACE BETWEEN ROUGH OPENINGS SHALL HAVE AT LEAST (1) STEEL ANGLE VERTICALLY IN EACH MULLION SPACE. THE SHEATHING ON THIS STEEL REINFORCED PARTITION SHALL BE 1/2" PLYWOOD, NO OTHER SHEATHING SHALL BE PERMITTED.

STARWAYS:


- TREADS SHALL BE 9" DEEP PLUS A 1" NOSING
- RISERS SHALL BE FIELD VERIFIED (NOT TO EXCEED 8-1/4")
- STAIR SHALL BE 36" WIDE CLEAR MINIMUM AND SHALL HAVE A HANDRAIL AT A HEIGHT ABOVE THE NOSING OF 34"-38"
- GUARD RAIL HEIGHT SHALL BE A MINIMUM OF 36" IN HEIGHT PER R312.1.2
- REQUIRED GUARDS SHALL NOT HAVE OPENINGS FROM WALKING SURFACE TO GUARD RAIL HEIGHT THAT ALLOW PASSAGE OF A 4" SPHERE.
- GUARDS ON OPEN SIDES OF STAIRS SHALL NOT HAVE OPENINGS ALLOWING PASSAGE OF A 4-3/8" SPHERE
- TRIANGLE FORMED BY RISER, TREAD AND BOTTOM GUARD RAIL SHALL NOT ALLOW PASSAGE OF A 6" SPHERE.

EGRESS WINDOW REQUIREMENTS

NCRC 2018 310.2.1
EVERY SLEEPING ROOM SHALL HAVE AT LEAST ONE OPERABLE EXTERIOR WINDOW OR EXTERIOR DOOR APPROVED FOR EMERGENCY EGRESS OR RESCUE. THE UNITS MUST BE OPERABLE FROM THE INSIDE TO A FULL CLEAR OPENING WITHOUT THE USE OF A KEY OR TOOL. WHERE WINDOWS ARE PROVIDED AS A MEANS OF EGRESS OR RESCUE, THEY SHALL HAVE A SILL HEIGHT OF NOT MORE THAN 44" ABOVE THE FLOOR.

NCRC 310.2.1

THE MIN. NET CLEAR OPENING HEIGHT DIMENSION SHALL BE 20". THE MIN. NET CLEAR OPENING WIDTH DIMENSION SHALL BE 20". THE NET CLEAR OPENABLE AREA SHALL NOT BE LESS THAN 4 SQ. FT.

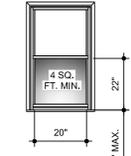


NCRC 310.2.1


EACH EGRESS WINDOW FROM SLEEPING ROOMS MUST HAVE A MIN. TOTAL GLASS AREA OF NOT LESS THAN 5 SQ. FT. IN THE CASE OF A GROUND FLOOR WINDOW AND NOT LESS THAN 5.7 SQ. FT. IN THE CASE OF A SECOND STORY WINDOW.



LVL BOLTING PATTERN DETAIL

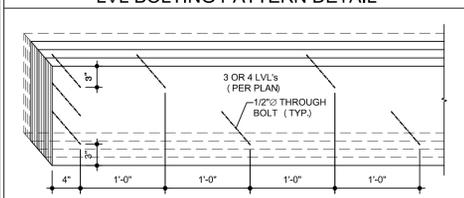

MAIN LEVEL	
HEATED SQUARE FOOT	1,615 SQ. FT.
DECK	112 SQ. FT.
COVERED FRONT PORCH	185 SQ. FT.
UPPER LEVEL	
HEATED SQUARE FOOT	647 SQ. FT.
TOTAL	
HEATED SQUARE FOOT	2,262 SQ. FT.
UNHEATED SQUARE FOOT	297 SQ. FT.

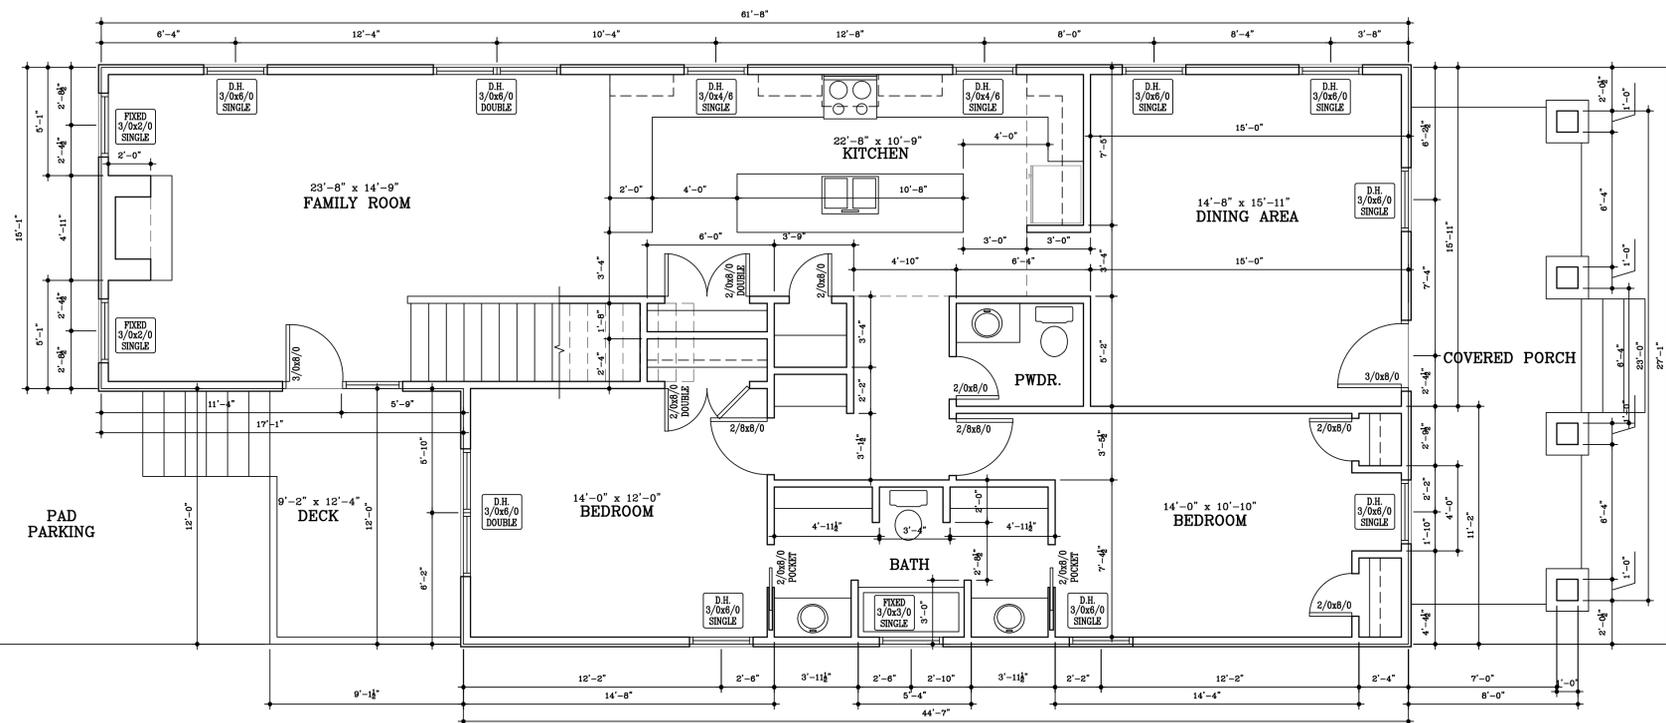

101 LOWER LEVEL PLAN
A1.0

1/4" = 1'-0"

R. ALLEN
 CONSTRUCTION
 1871 POARCH ROAD
 LINCOLNTON, NORTH CAROLINA
 (704) 735-8844
 (704) 735-1720
 TELEPHONE
 (704) 735-8844
 (704) 735-1720
 FAX

A NEW RESIDENCE AT:
WILMORE #1
 CHARLOTTE, NC

PROJECT NO.	WILMORE01	
DATE:	JUNE 21, 2016	
DRAWN BY:	MSB	
CHECKED BY:	MSB	
REVISIONS:		
NO.	DATE:	BY
COMPUTER REFERENCE NUMBER	WILMORE01	125
SHEET NO.	A1.0	OF 4


ELEVATION NOTES:

1. ALL SHINGLES ARE TO BE SELECTED BY OWNER
2. ALL BRICK VENEER IS TO BE SELECTED BY OWNER
3. ALL GERMAN STYLE SIDING IS TO BE SELECTED BY OWNER
4. ALL DOOR AND WINDOW STYLES ARE TO BE SELECTED BY OWNER
5. ALL GRADE SHOWN IS PROPOSED AND IS TO BE FIELD VERIFIED BY G.C.
6. ALL OVERHANGS ARE TO BE 1'-0" TYPICAL
7. ALL STEPS SHOWN ARE TO ADJUST TO GRADE AS NEEDED




301 FRONT ELEVATION
A3.0

1/4" = 1'-0"

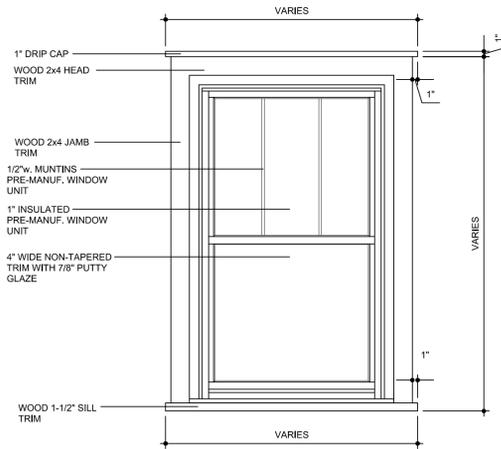


303 WINDOW TRIM DTL. TYP. 3/4" = 1'-0"
A3.0

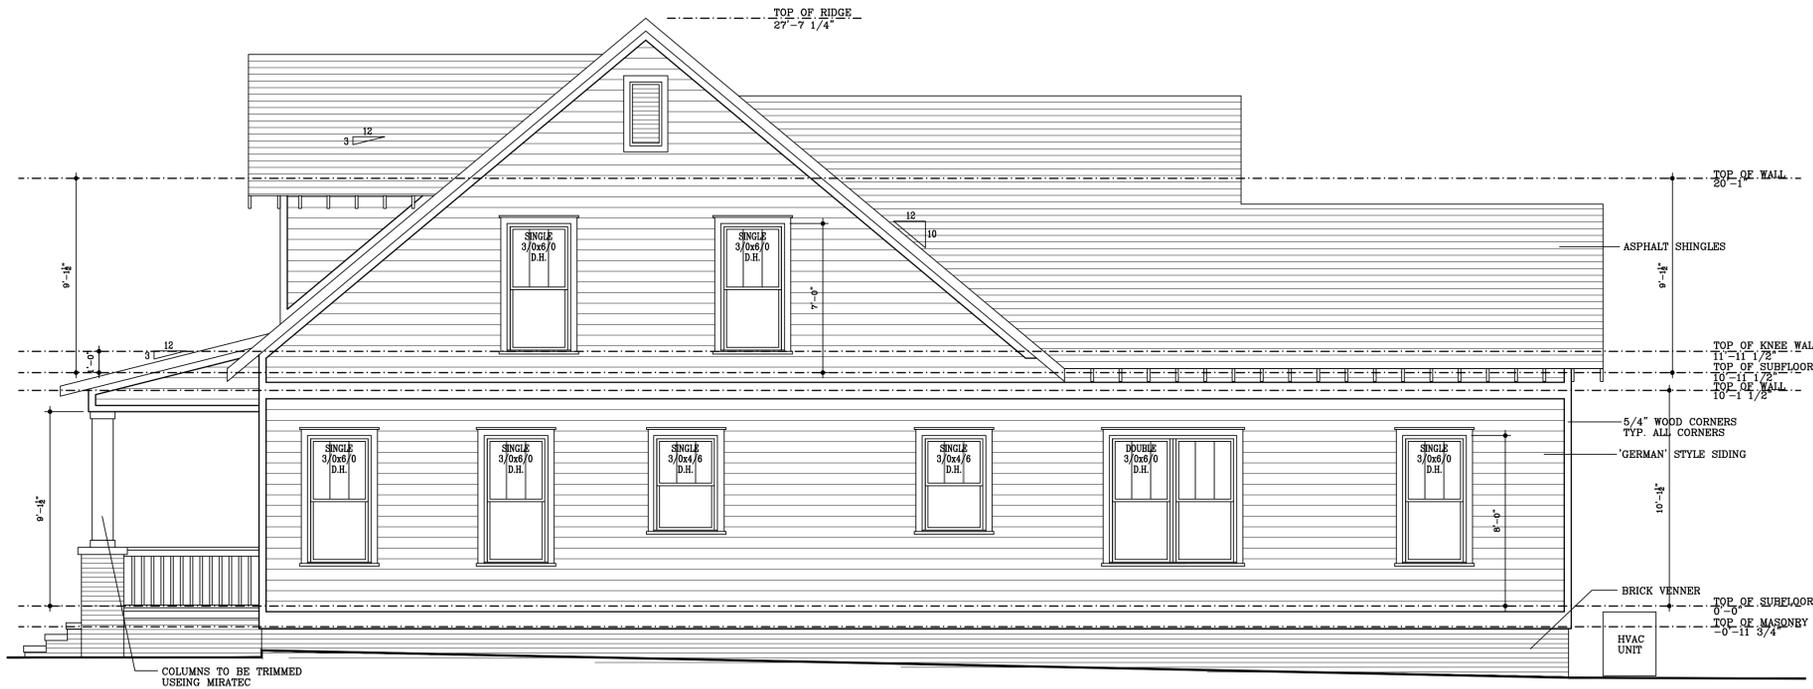

302 RIGHT SIDE ELEVATION
A3.0

1/4" = 1'-0"

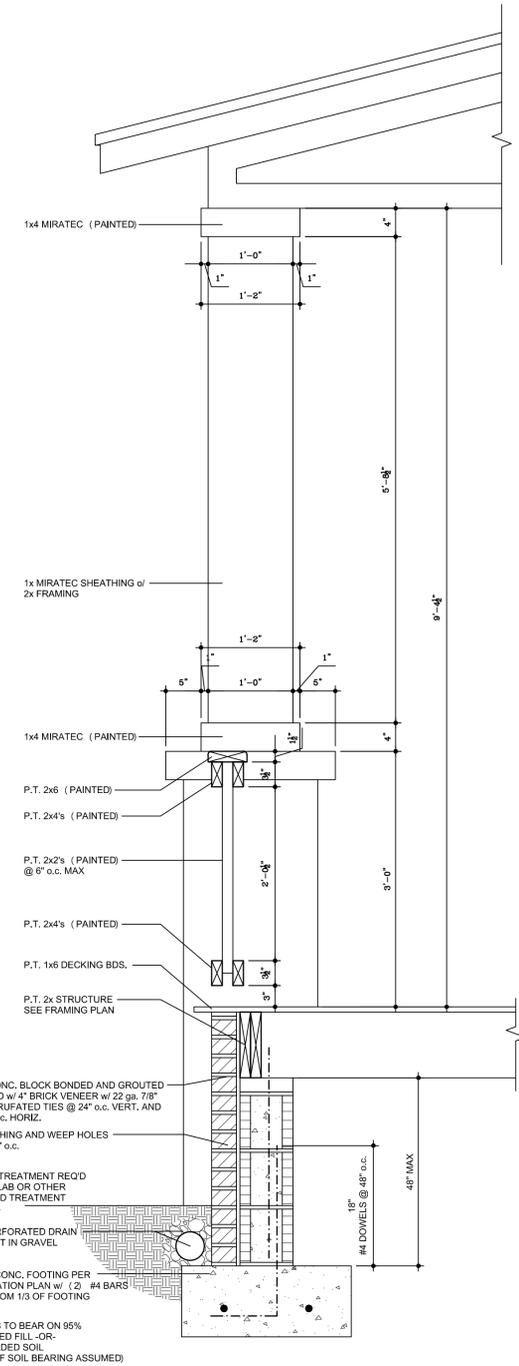

304 RAILING DETAILS
A3.1


1" = 1'-0"

M S J D R A F T I N G
 1871 POARCH ROAD
 LINCOLTON, NORTH CAROLINA
 TELEPHONE (704) 732-8844
 FAX (704) 732-1720

R. ALLEN
CONSTRUCTION

A NEW RESIDENCE AT:
WILMORE #1
 CHARLOTTE, NC

PROJECT NO.	WILMORE01	
DATE:	JUNE 21, 2016	
DRAWN BY:	MSB	
CHECKED BY:	MSB	
REVISIONS:		
NO.	DATE:	BY
COMPUTER REFERENCE NUMBER	WILMORE01 .125	
SHEET NO.	A3.0 of 4	

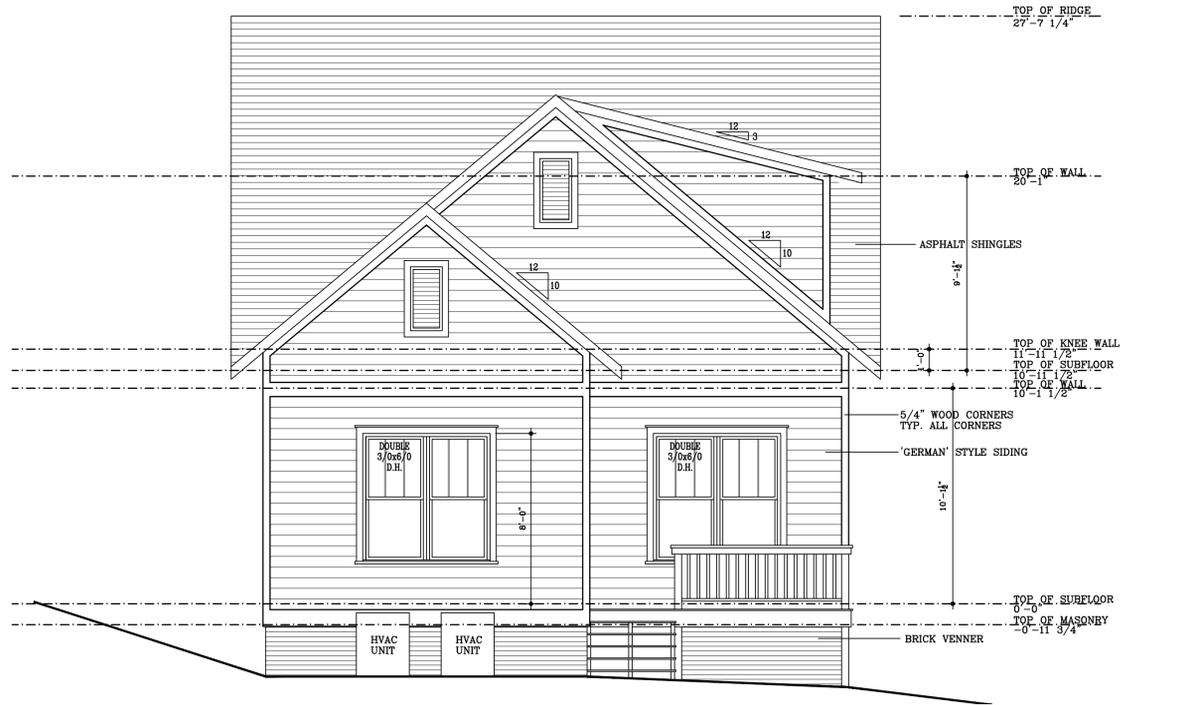


301 REAR ELEVATION
A3.1


1/4" = 1'-0"

ELEVATION NOTES:


1. ALL SHINGLES ARE TO BE SELECTED BY OWNER
2. ALL BRICK VENEER IS TO BE SELECTED BY OWNER
3. ALL GERMAN STYLE SIDING IS TO BE SELECTED BY OWNER
4. ALL DOOR AND WINDOW STYLES ARE TO BE SELECTED BY OWNER
5. ALL GRADE SHOWN IS PROPOSED AND IS TO BE FIELD VERIFIED BY G.C.
6. ALL OVERHANGS ARE TO BE 1'-0" TYPICAL
7. ALL STEPS SHOWN ARE TO ADJUST TO GRADE AS NEEDED

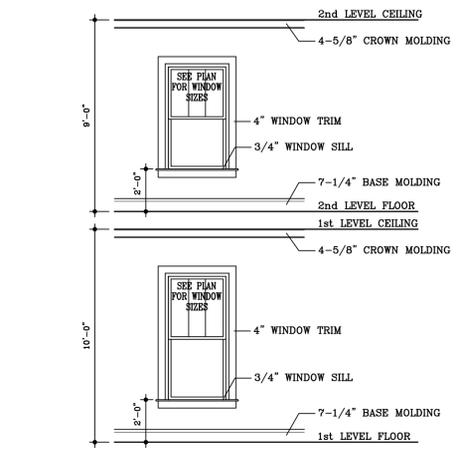

305 TRIM DETAILS
A3.1

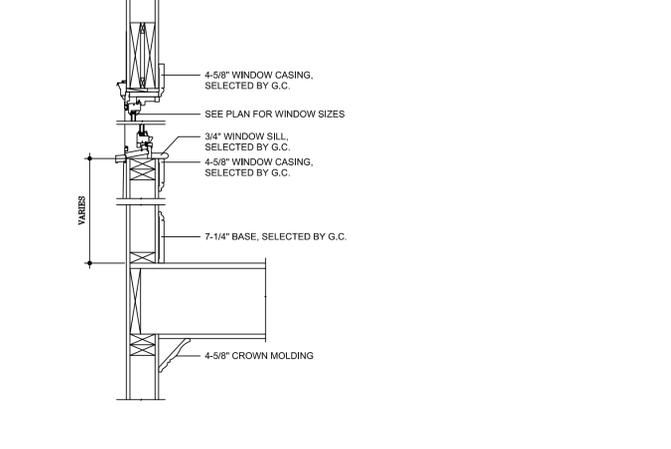


304 TRIM DETAILS
A3.1

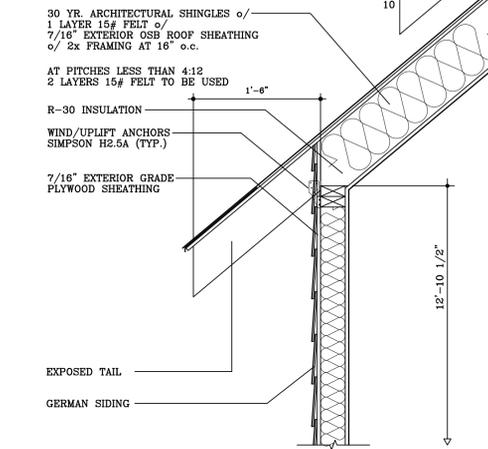

303 SOFFIT DETAILS
A3.1

1/4" = 1'-0"

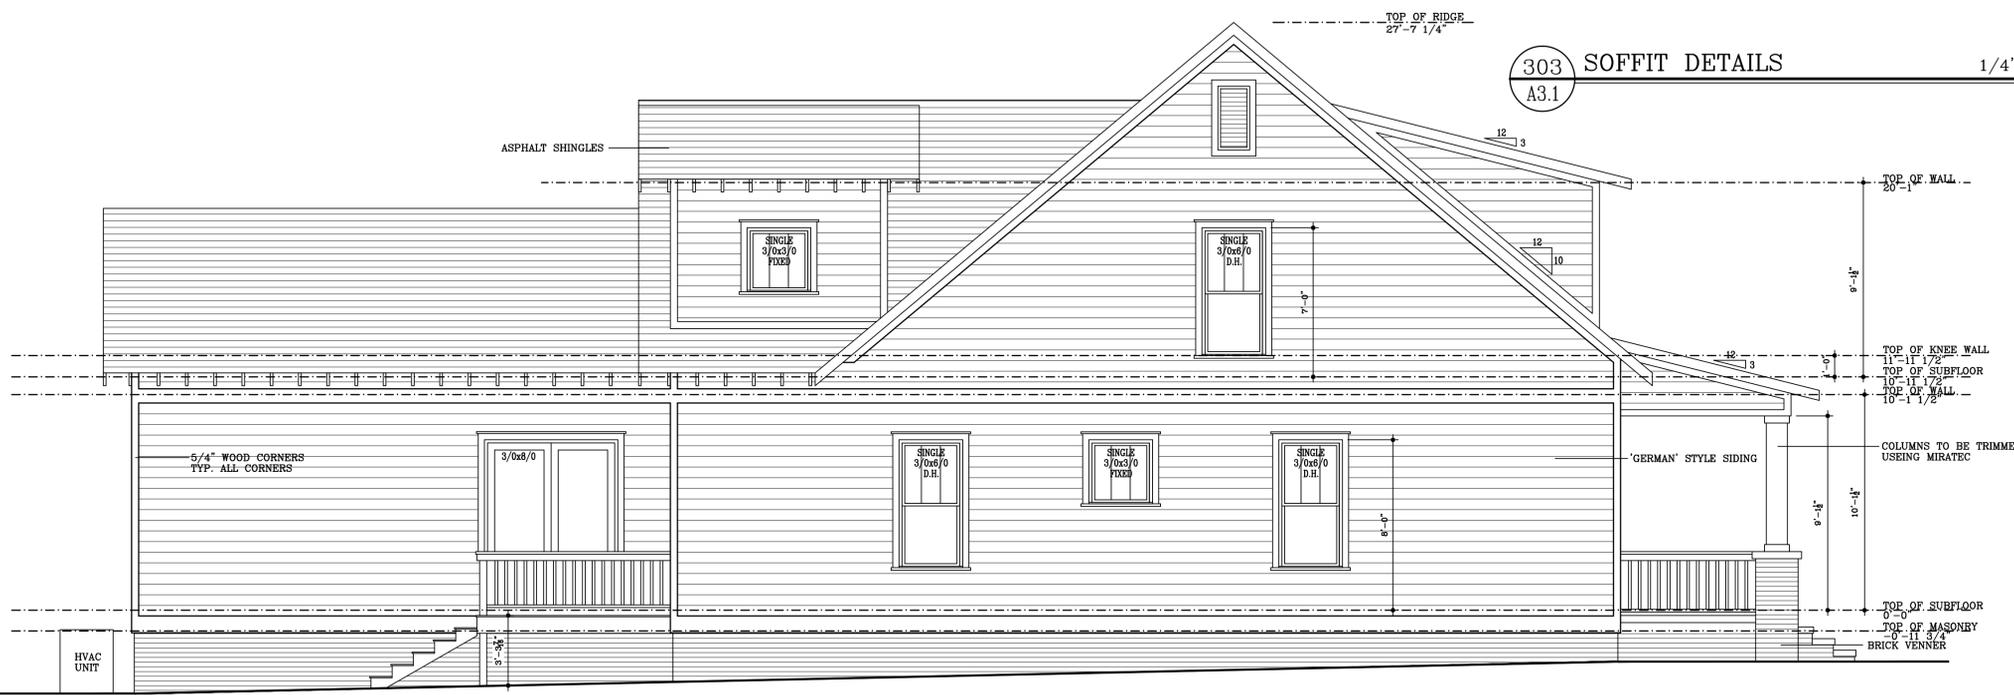

302 LEFT SIDE ELEVATION
A3.1

1/4" = 1'-0"

M S J D R A F T I N G
 1871 POARCH ROAD
 LINCOLNTON, NORTH CAROLINA
 TELEPHONE (704) 732-8844
 FAX (704) 732-1720

R. ALLEN
CONSTRUCTION

A NEW RESIDENCE AT:
WILMORE #1
 CHARLOTTE, NC

PROJECT NO.	WILMORE01	
DATE:	JUNE 21, 2016	
DRAWN BY:	MSB	
CHECKED BY:	MSB	
REVISIONS:		
NO.	DATE:	BY
COMPUTER REFERENCE NUMBER	WILMORE01 125	
SHEET NO.	A3.1 of 4	



Residential Structures, P.C.
 Engineering and Design
 Charlotte: 704-332-5460
 Charleston: 843-406-7174
 Myrtle Beach/Florence: 704-301-9521
 www.residentialstructurespc.com



RESIDENTIAL STRUCTURES, P.C.
 3410 N. Davidson St.
 Charlotte, N.C. 28205
 Seal For Structural Only

A NEW RESIDENCE AT:
WILMORE #1
 CHARLOTTE, NC

2ND FLOOR CEILING FRAMING NOTES:

- ALL EXTERIOR WALLS TO BE SHEATHED w/ 5/8" OSB ATTACHED TO FRAMING w/ 8d NAILS AT 6" O.C. EDGE AND 12" O.C. FIELD. PROVIDE BLOCKING AT ALL PANEL SPICES.
- ALL INT./EXT. LOAD BEARING HEADERS TO BE 2-2X8'S U.N.O w/ (1) JACK AT EACH END U.N.O.
- ALL EXTERIOR HEADERS TO HAVE (1) KING PER EVERY 3 FEET OF OPENING @ EACH END.
- AT CLIP LINES, CEILING JOISTS TO BE NAILED TO RAFTERS w/ (8)10d NAILS U.N.O.

- ④ = NUMBER OF STUDS. STUDS TO BE SAME SIZE AS ASSOCIATED WALL FRAMING STUDS
- * #KING@E.E. = # of jack studs and # of king studs at each end of header.
- ① = 2X8 (SPF #2) CEILING JOISTS @ 16" O.C. U.N.O.
- ② = 2X6 (SPF #2) @ 16" O.C. U.N.O.


NOTE THE WALL BRACING FOR THIS STRUCTURE HAS BEEN DESIGNED TO MEET OR EXCEED THE INTENT OF THE 2018 NBC.

TYPICAL HANGERS

MEMBER	HANGER
2X8	LUS28
2X10	LUS210
2X12	LUS212
(2) 2X8	HUS28-2
(2) 2X10	HUS210-2
(2) 2X12	HUS212-2
(3) 2X8	LUS28-3
(3) 2X10	LUS210-3
(3) 2X12	LUS212-3
(2) 9L / (2) 11L LVL	HGUS410
(2) 14" / (2) 16" / (2) 18" LVL	HGUS414
(3) 9L LVL	HGUS5.50/10
(3) 11L LVL	HGUS5.50/12
(3) 14" / (3) 16" / (3) 18" LVL	HGUS5.50/14
(4) 9L LVL	HGUS7.25/10
(4) 11L LVL	HGUS7.25/12
(4) 14" / (4) 16" / (4) 18" LVL	HGUS7.25/14

WALL STUD REQUIREMENTS

EXT. WALL HT. (h)	STUD SIZE AND SPACING
h < 10'-0"	2X4 @ 16" (O.C.)
10'-0" < h < 11'-0"	2X4 @ 12" (O.C.)
11'-0" < h < 18'-0"	2X6 @ 16" (O.C.)
h > 18'-0"	CONSULT ENGINEER

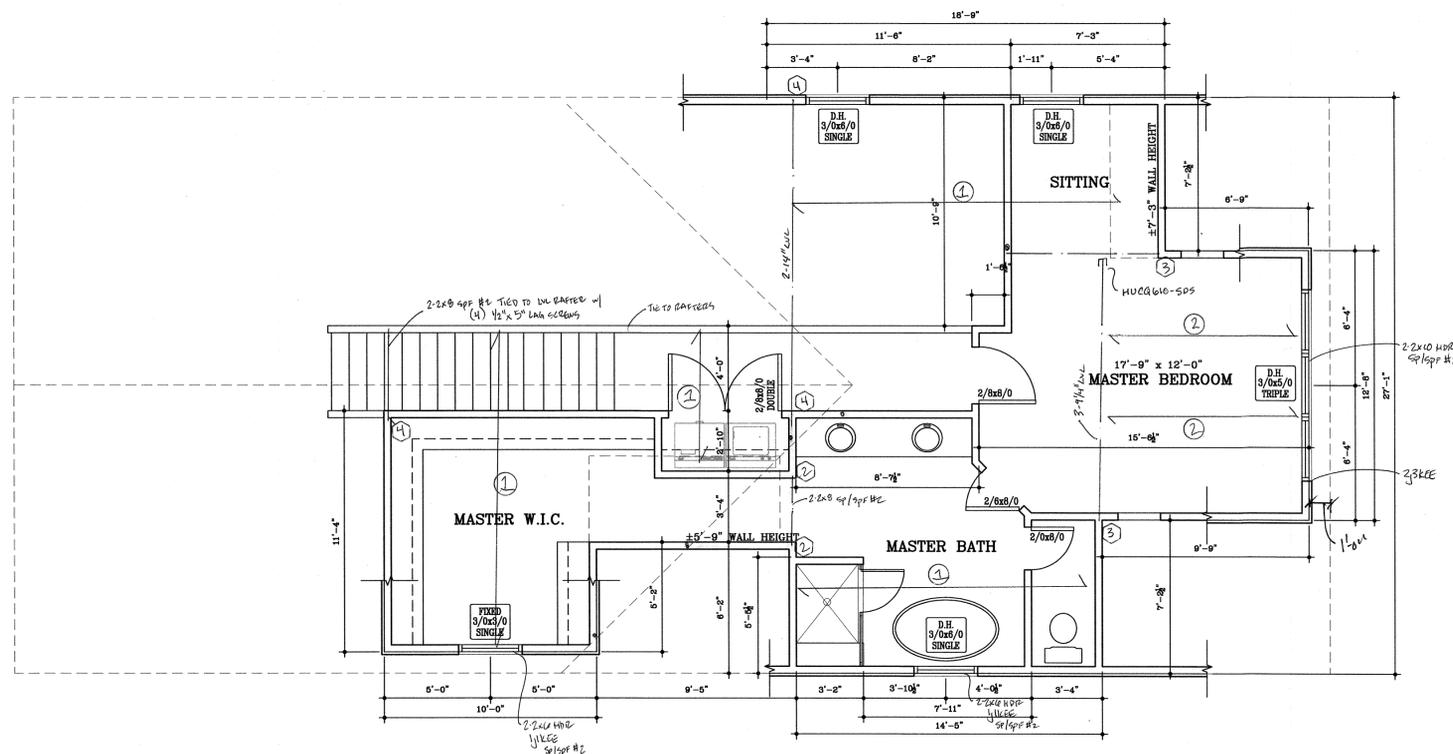

UPPER LEVEL PLAN

1/4" = 1'-0"

REV. DATE DESCRIPTION


DESIGNER: PRS

SCALE:

DATE:

SHEET:

S4

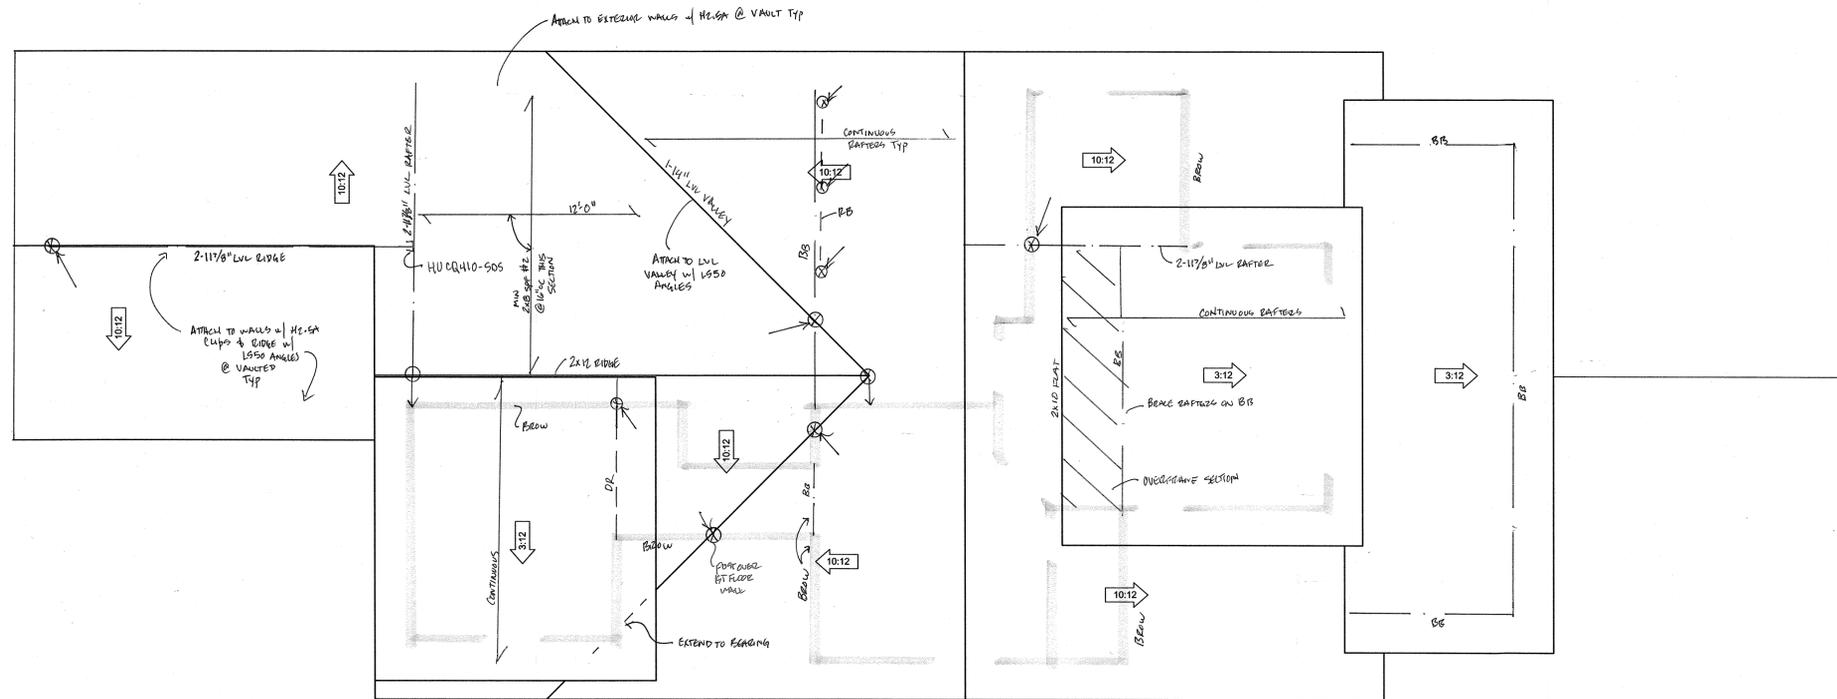

- ROOF NOTES**
1. ALL RAFTERS TO BE 2X6's (SPF #2) @ 16" O.C. U.N.O
 2. ALL RIDGES TO BE 2X10's (SPF #2) U.N.O
 3. ALL HIPS AND VALLEYS TO BE 2X10's (SPF #2) U.N.O
 4. D.R. = DOUBLE RAFTER
 5. T.R. = TRIPLE RAFTER
 6. R.B. = RAFTER BRACE (2-2X6)
 7. B.B. = BEAM BELOW
- = AREA TO BE OVERFRAMED
 = ROOF BRACE POINT AND BRACE TO POINT
 BROW = BRACE ROOF ON WALL
 = NUMBER OF STUDS. STUDS TO BE SAME SIZE AS ASSOCIATED WALL FRAMING STUDS
 RIGS 2.7 PROVIDE 2 LAYERS UNDERLAMENT ON ROOF WITH 2:12 SLOPE UP TO 4:12 SLOPE WHERE ASPHALT SHINGLES ARE USED

ROOF PLAN

1/4" = 1'-0"



Residential Structures, P.C.
 Engineering and Design
 Charlotte: 704-332-5460
 Charleston: 843-406-7174
 Myrtle Beach/Florence: 704-301-9521
 www.residentialstructurespc.com




A NEW RESIDENCE AT:
WILMORE #1
 CHARLOTTE, NC

REV.	DATE	DESCRIPTION
DESIGNER:		PRS
SCALE:		
DATE:		
SHEET:	S5	

UPDATED ITEMS FOR LOT 1 - 3

1. **TREE SAVE** – attached is a letter from Barry Gemberling (Arboguard) in regard to his recommendations on how to keep the LOT 4 (Willow Oak) tree safe prior and during construction.
2. **MIRATEC** – to be installed on all columns, corners and fascia with corner boards being 5.5 inches
3. **OPEN TAILS / SOFFITS** – roof to extend 24 inches at right angle to siding, with $\frac{3}{4}$ v-groove bead board and 2x8" rafters with bed mold installed base
4. **WINDOWS** – 4" wide non-tapered trim with $\frac{7}{8}$ putty glaze, removed brick casing

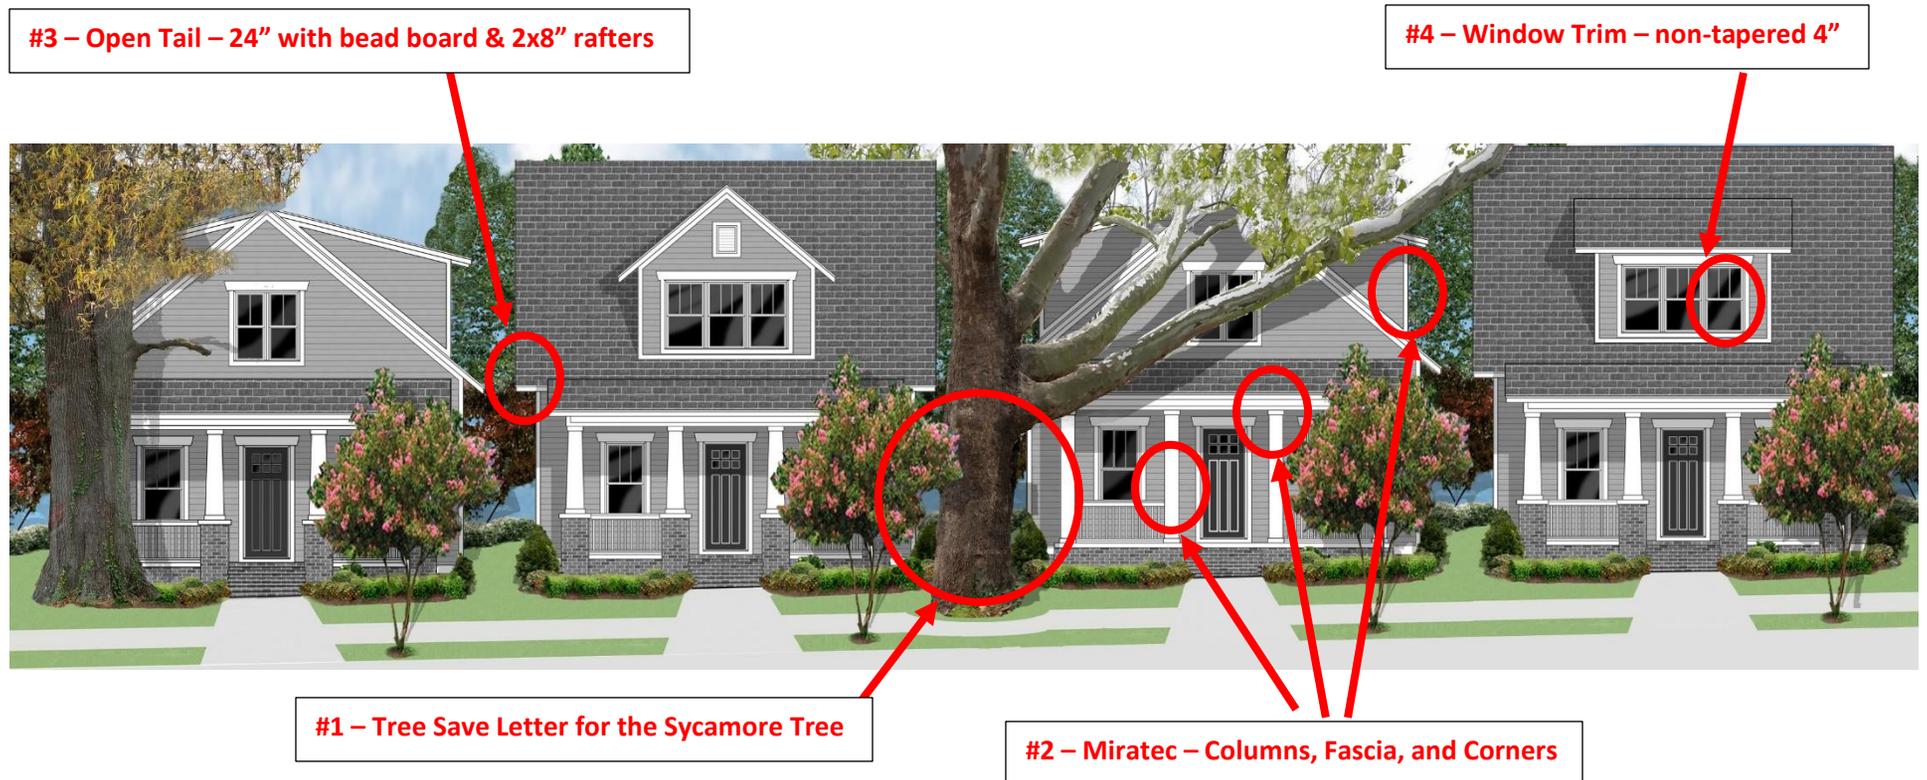

HOUSE VARIATION STREETScape

LOT 4

LOT 3

LOT 2

LOT 1



- LOT 1 - stays the same but we have taken the roofline down 1 ft.
- LOT 2 - stays the same but we have taken the roofline down 1 ft.
- LOT 3 – the front dormer has a gable above it, and the roofline came down 1 ft.
- LOT 4 – the front porch wraps-around along Worthington and is positioned for us to save the Oak Tree



LOT 1 - HEIGHT / MASSING


- We have reduced the roofline by 1 foot to 27' 7.25", by making the 2nd Floor 9' ceiling height.




LOT 1 – (UPDATED)




RIGHT (UPDATED)

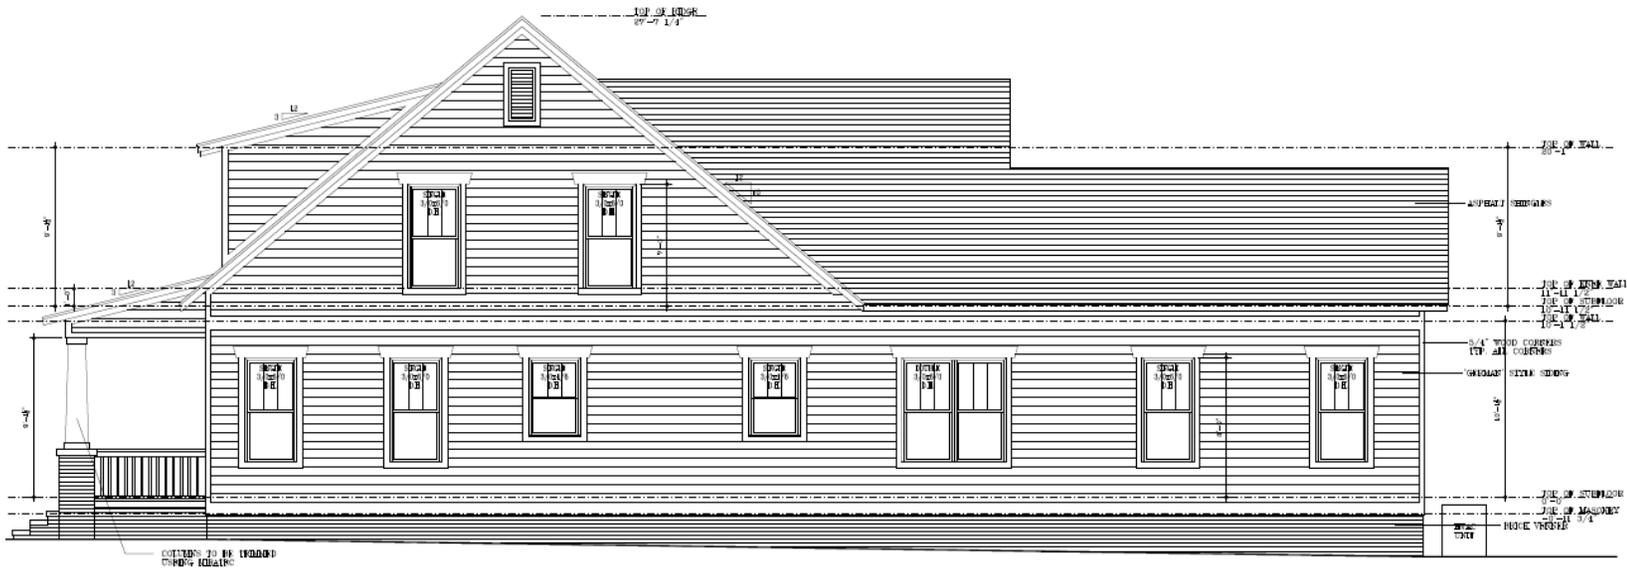



LEFT (UPDATED)

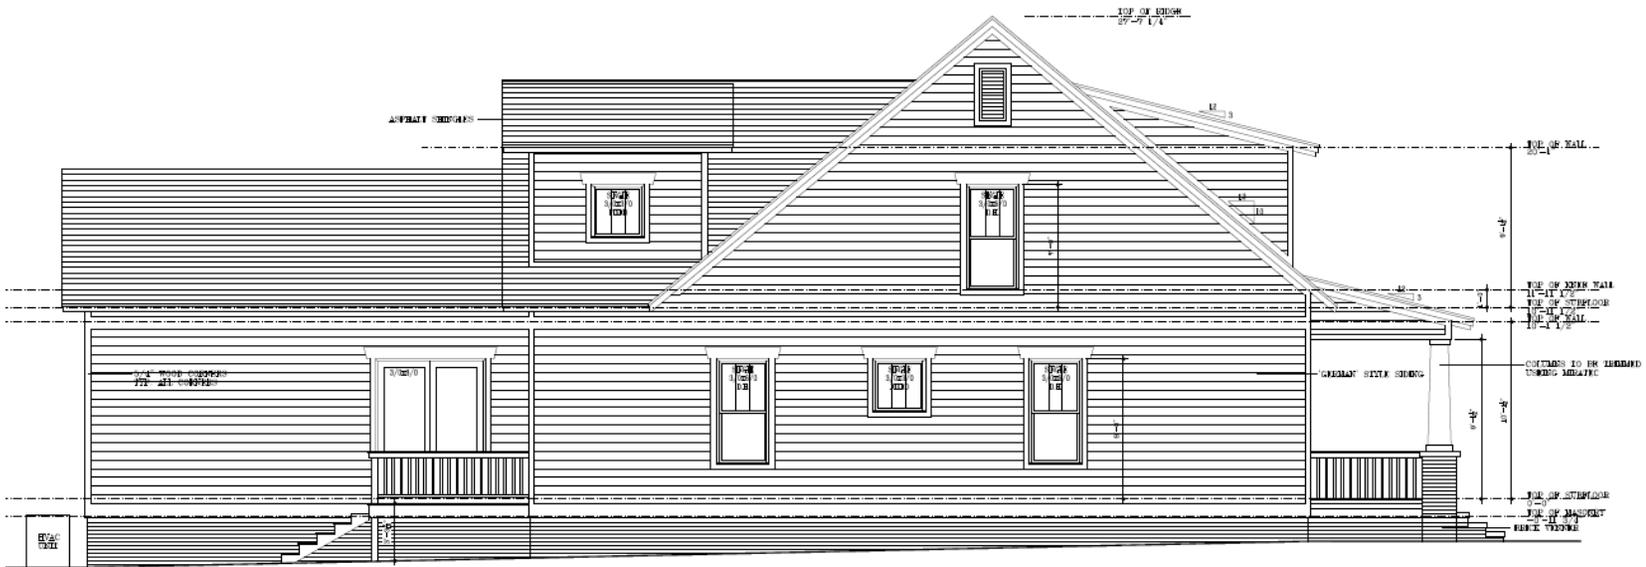

REAR (UPDATED)

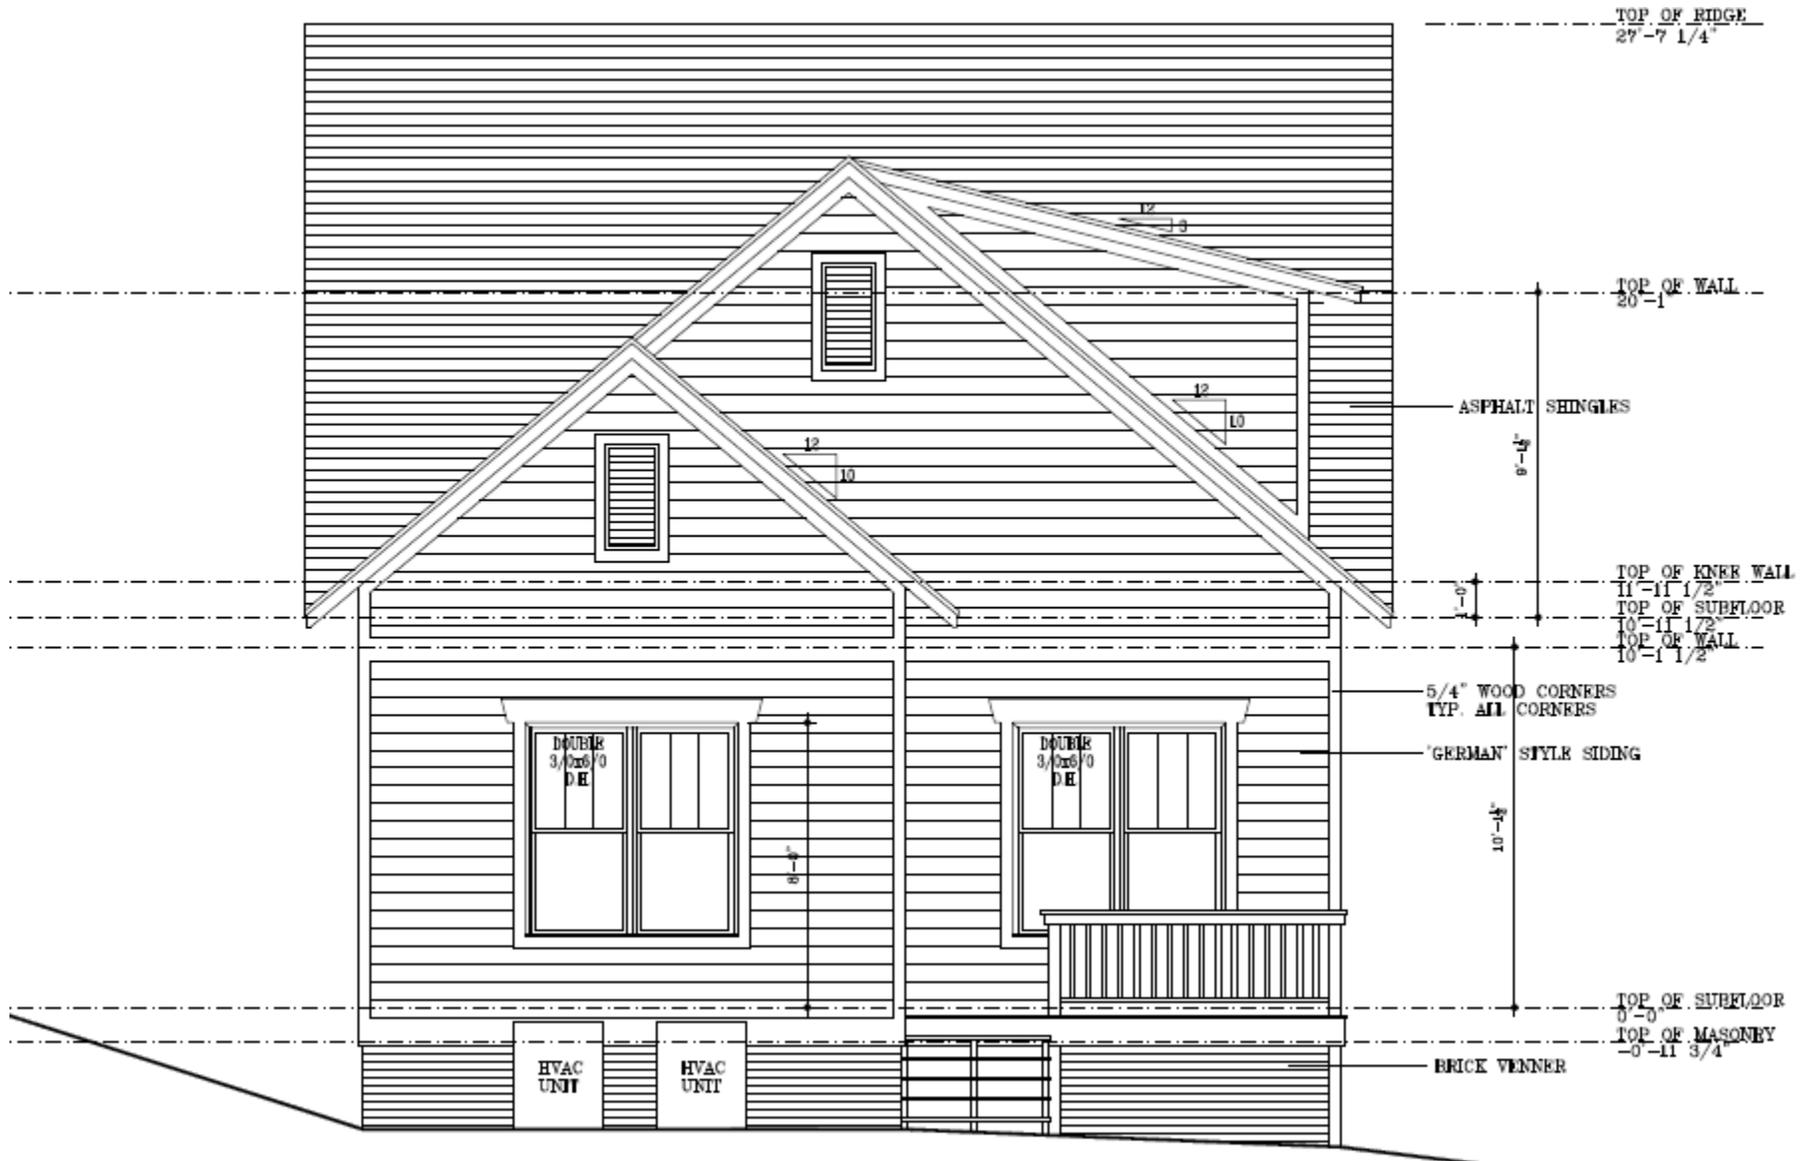


LOT 1 FLOORPLAN

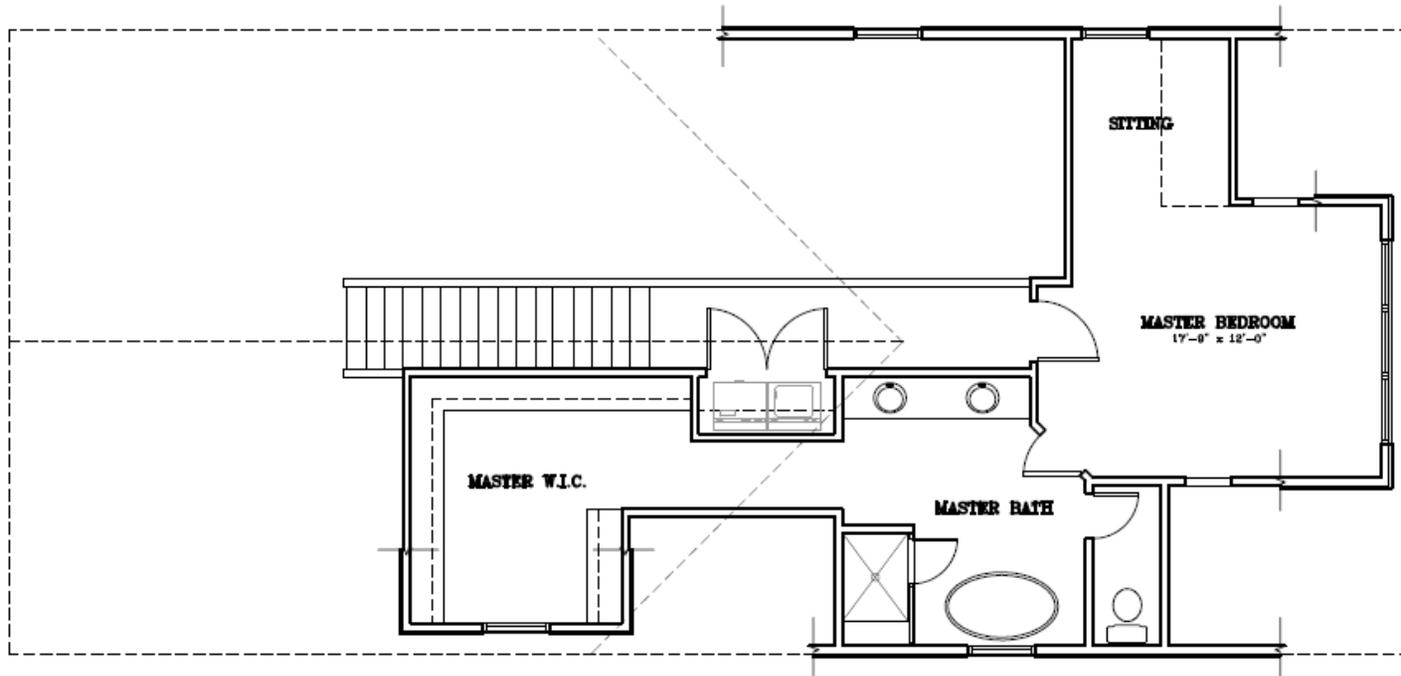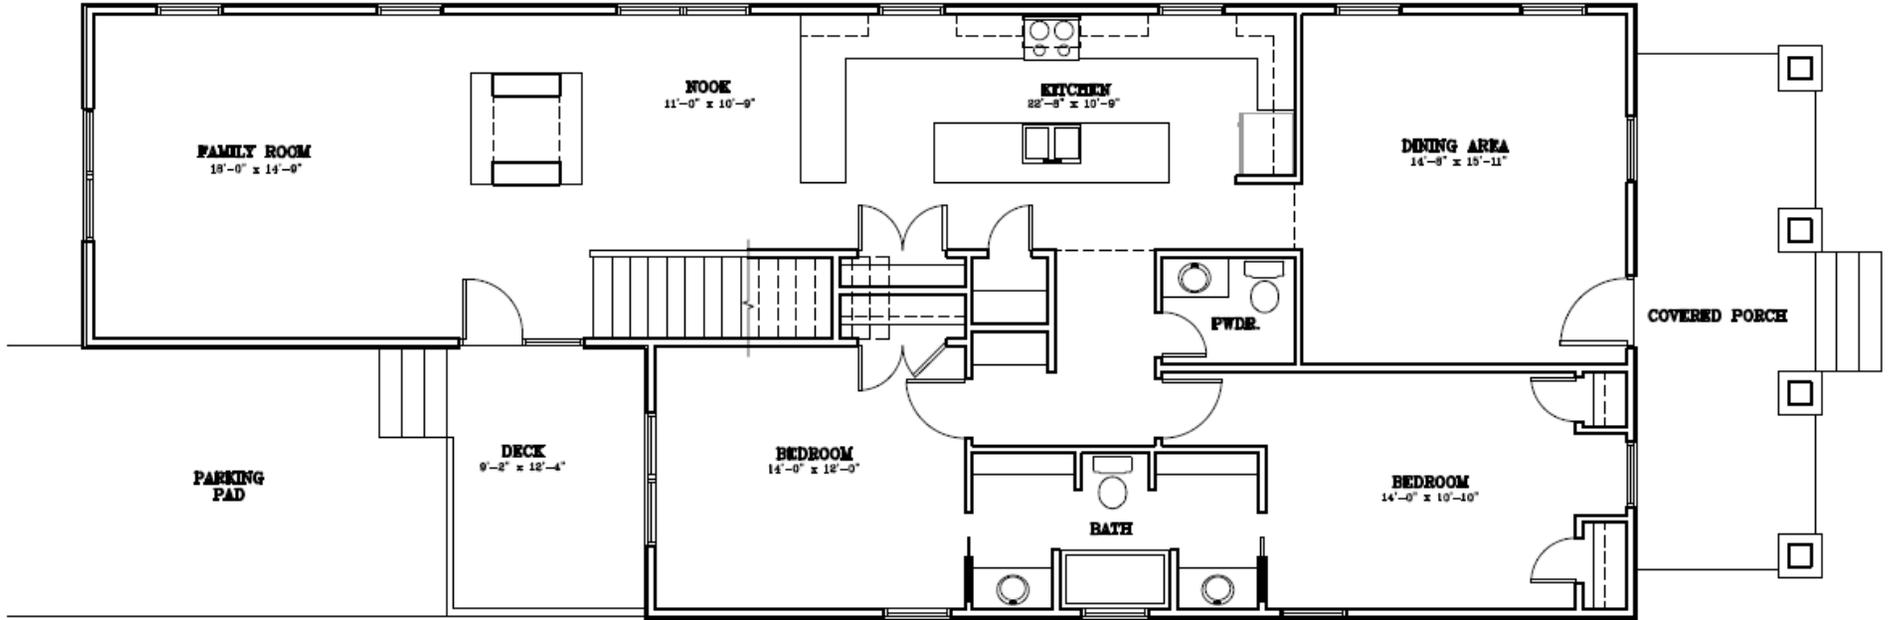


STREET SURVEYS

Wickford Place (across the Street – from West Blvd. to Worthington)

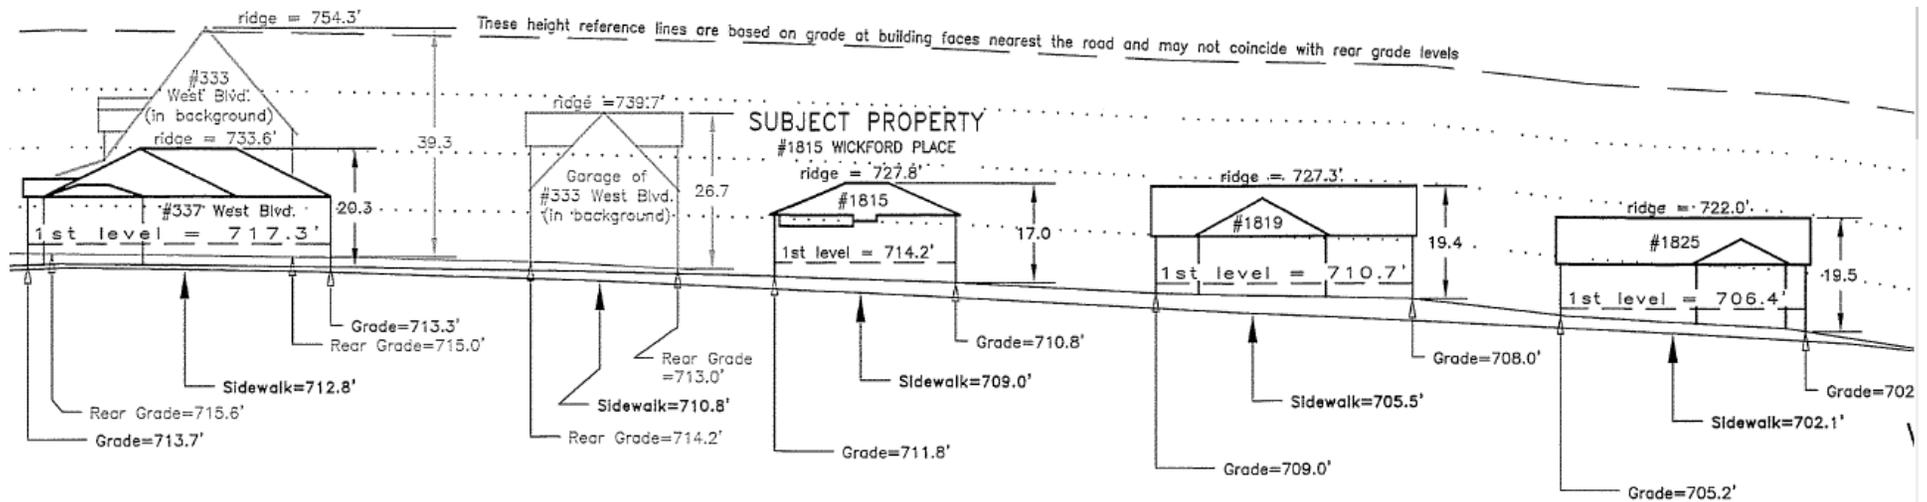

Worthington Ave (Wickford Place)

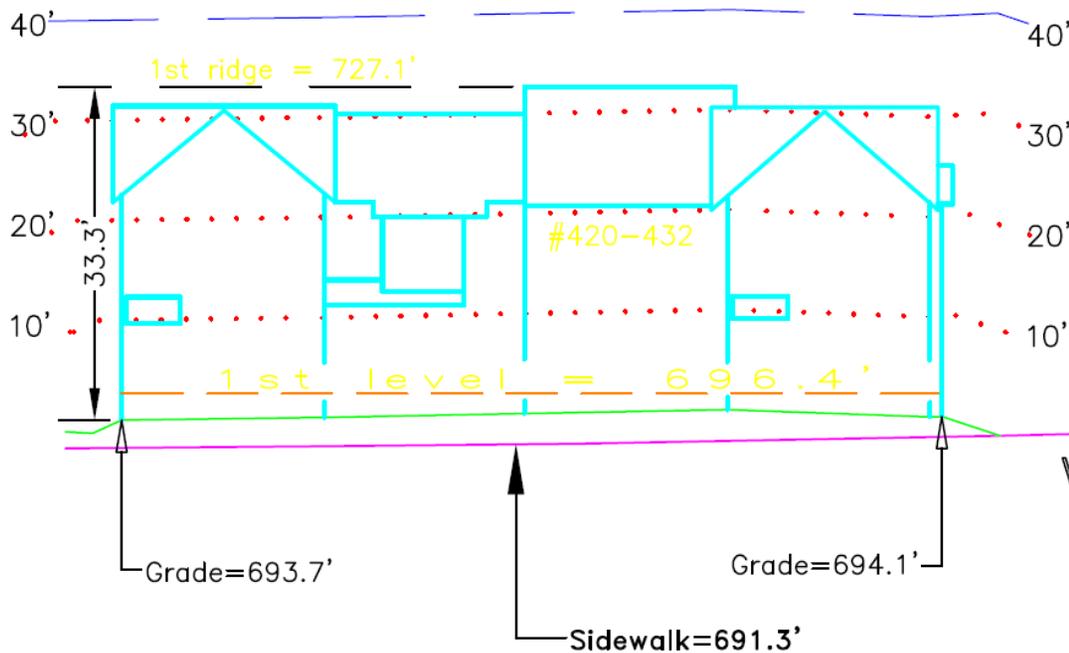


1816 Wickford Place


LOT #	Roofline	Elevation to Grade
1	27' 7.25"	730.3'
2	23' 11.5"	728.6'
3	27' 7.25"	730.8'
4	23' 11.5"	724.8'

HEIGHT / STREETScape / SCALE

Wickford Place (across the Street – from West Blvd. to Worthington)

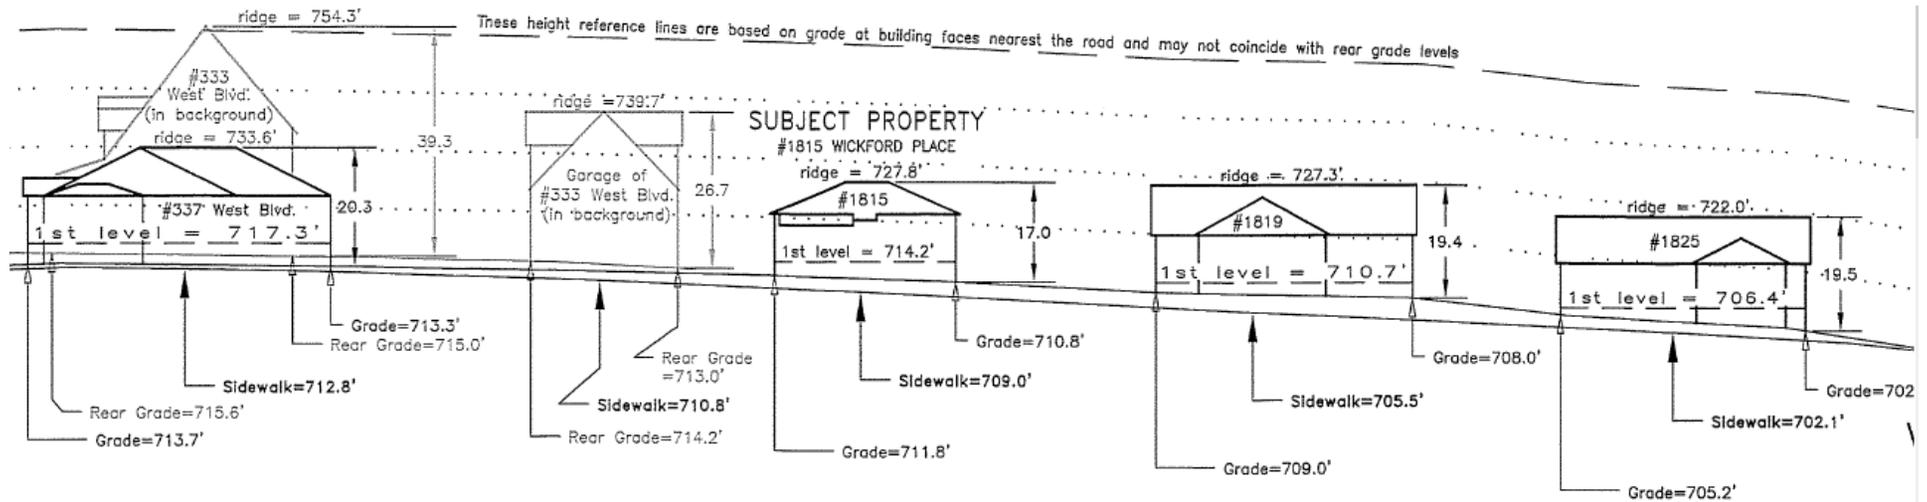


Wickford Place (our side including the neighbor's house to the right of our property)

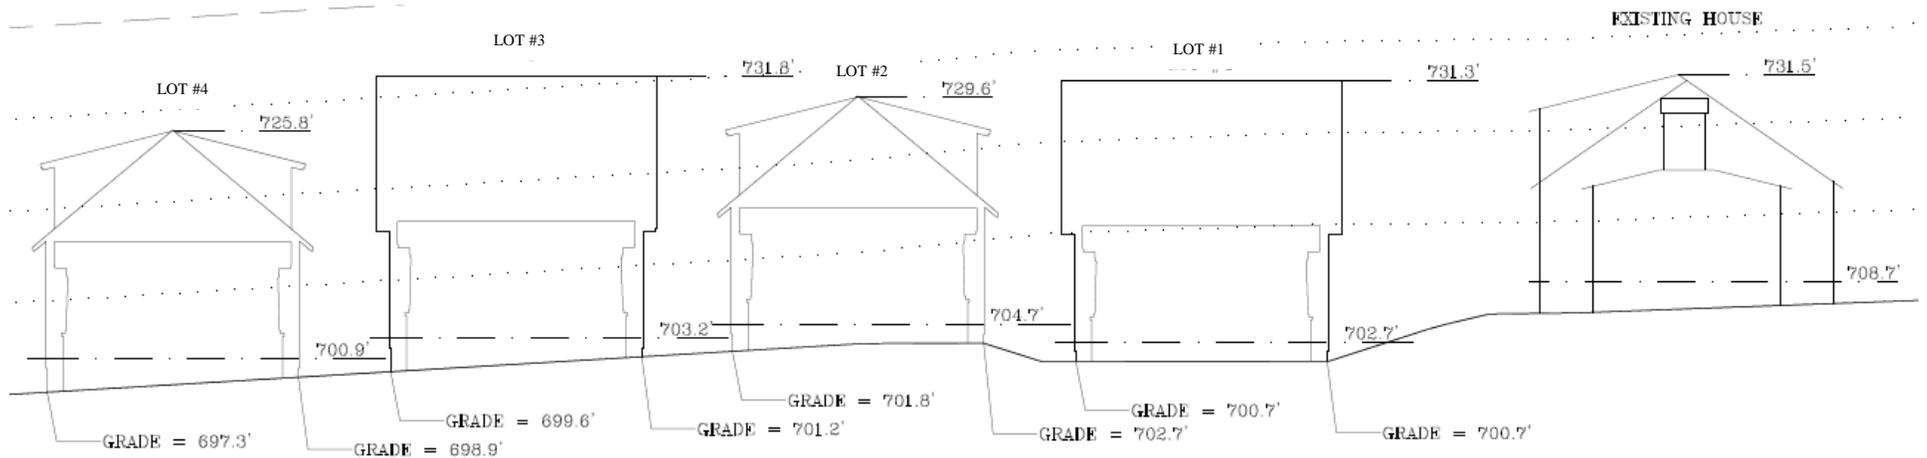

- Our Hip Roof Houses are within 3 inches of our neighbor's roofline and within 4 feet of the roofline across the street.
- Our Gable Style Houses are 2 feet lower than our neighbor's roofline and between 2-3 feet of across the street.

FOOTPRINT / LOT DIMENSIONS / RATIO

There is an additional 10' green space (Unopened Alley) that runs between our property and the neighbor to our

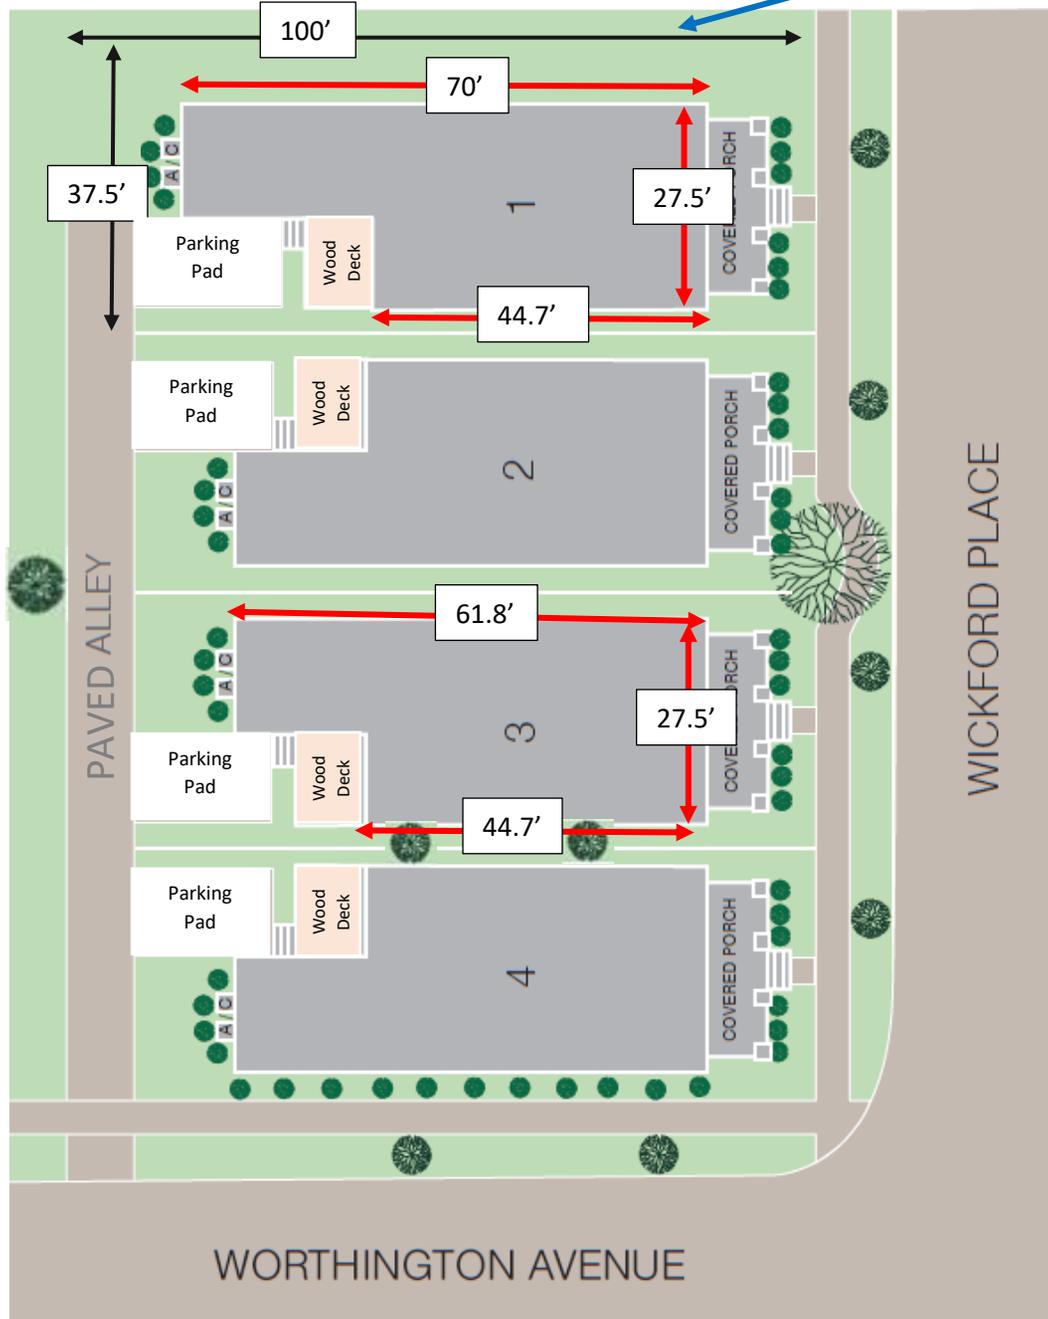

LOT 1 Footprint

- Depth of 70' & 44.7' heated square feet
- Width of 27.5' heated square feet
- Total 1,615 heated sq. ft. Footprint
- 184' sq. ft. covered porch

LOT 2 – 4 Footprint

- Depth of 61.8' & 44.7' heated square feet
- Width of 27.5' heated square feet
- Total 1,487 heated sq. ft. Footprint
- 184' sq. ft. covered porch

LOT Size 1 – 4

- Depth 100' / 37.5'
- Total Lot Size 3,750 sq. ft.


Footprint % to Lot Size / % of Lot that's Permeable

Lot 1 43% heat sq. ft. / 48% is Permeable*

Lot 2-4 39% heat sq. ft. / 45% is Permeable*

*Paved Alley is included as Non-Permeable

WINDOW DETAIL – UPDATED

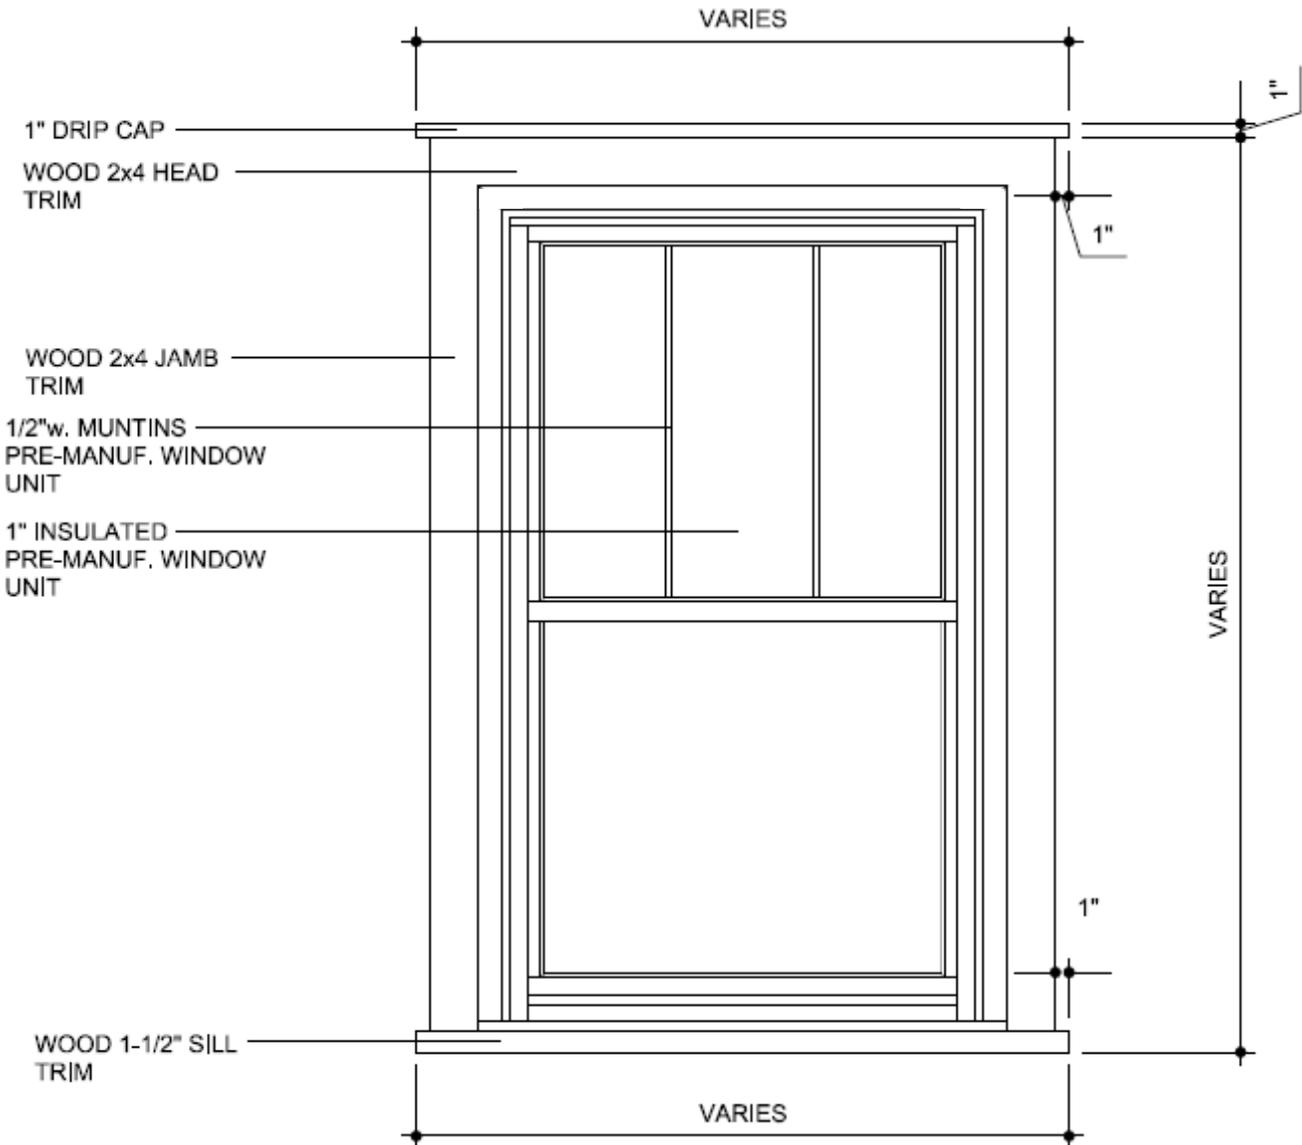

SOFFIT DETAIL – UPDATED OPEN TAIL

30 YR. ARCHITECTURAL SHINGLES o/
1 LAYER 15# FELT o/
7/16" EXTERIOR OSB ROOF SHEATHING
o/ 2x FRAMING AT 16" o.c.

AT PITCHES LESS THAN 4:12
2 LAYERS 15# FELT TO BE USED


R-30 INSULATION

WIND/UPLIFT ANCHORS
SIMPSON H2.5A (TYP.)


7/16" EXTERIOR GRADE
PLYWOOD SHEATHING

EXPOSED TAIL


GERMAN SIDING

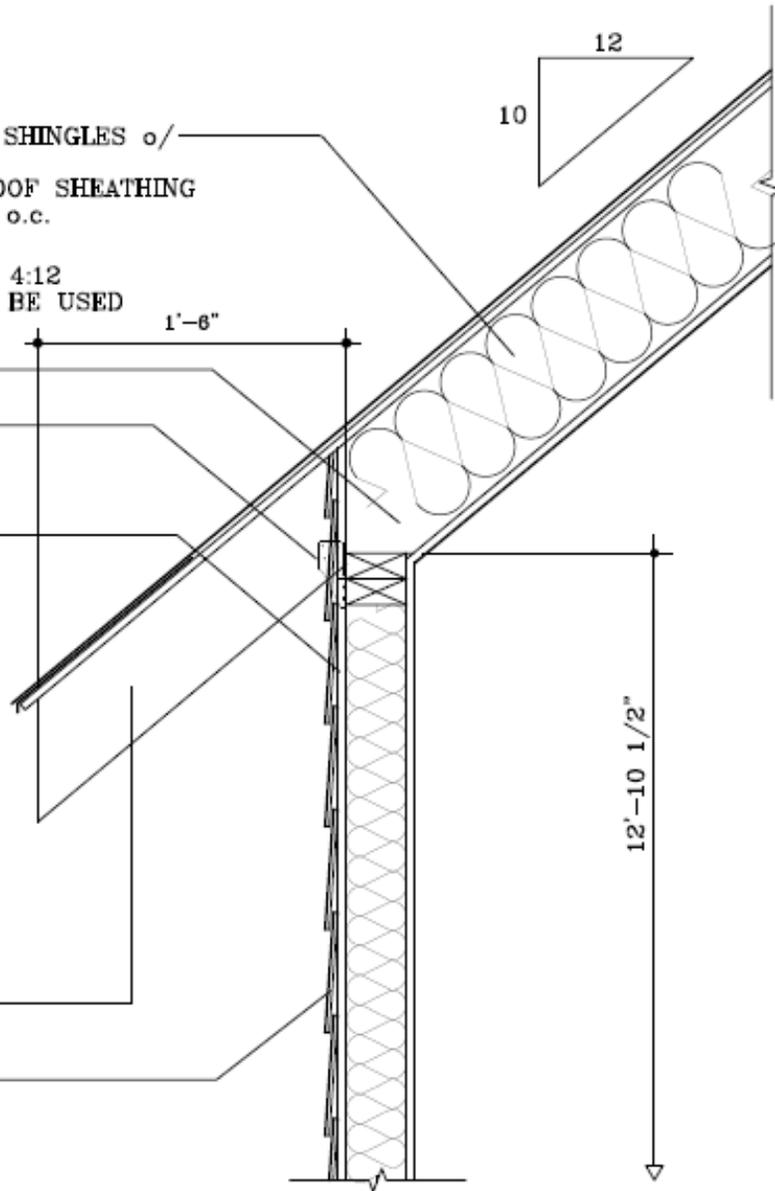

INTERIOR WINDOW HEIGHTS, TRIM, & CROWN

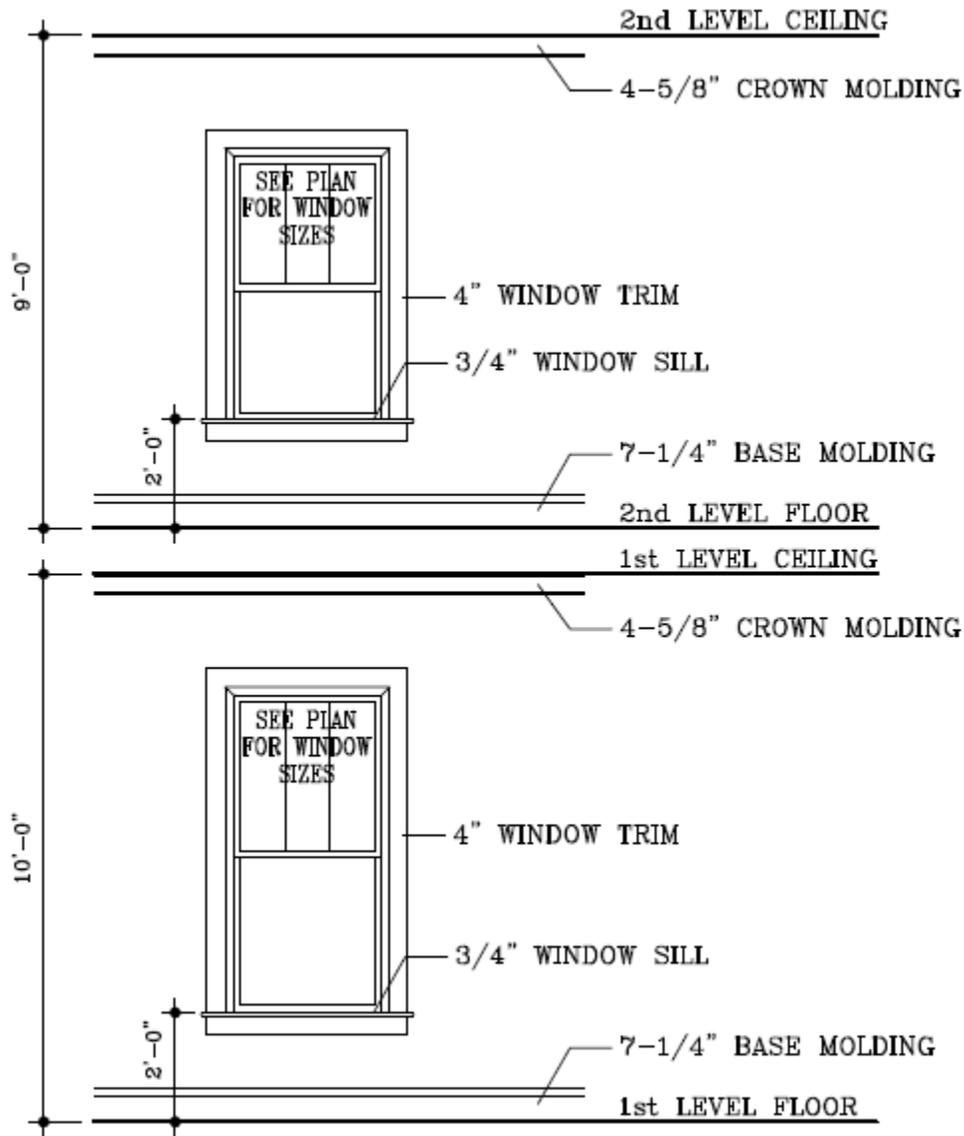

EXTERIOR WINDOW DETAIL

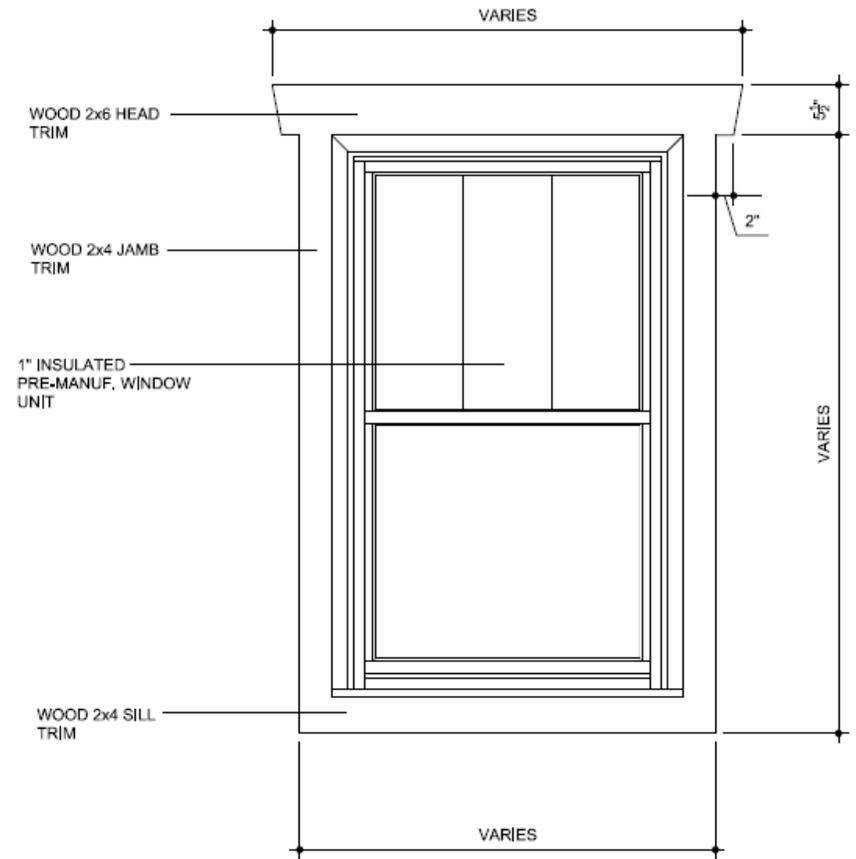

PORCH RAILING & COLUMN DETAIL

