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**LOCAL HISTORIC DISTRICT:** Wilmore

**PROPERTY ADDRESS:** 300 West Park Avenue

**SUMMARY OF REQUEST:** New Construction and garage

**APPLICANT:** Robert and Kelly St. Louis/Liz Sheik

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**Details of Proposed Request**

*Existing Conditions*

The existing site is a vacant corner parcel in an area with one and two story homes. The site is approximately 3 feet above the sidewalk, the lot size is 50' x 200'. Setbacks are consistent along the block. An alley exists behind the property. Houses on the block range in height from approximately 20'-5" to 30'-5".

*Proposal*

The proposal is a new single family house and detached garage. The height from grade is approximately 33'-3". Design features include cedar siding in the gables and brick foundation. The front porch is full width. The applicant is requesting the use of cementitious lap siding.

The detached garage is one story and will be accessed from the alley. Exterior materials will match the house.

**Policy & Design Guidelines for New Construction, page 34**

New construction in Local Historic Districts has an obligation to blend in with the historic character and scale of the Local Historic District in which it is located. Designs for infill projects and other new construction within designated Local Historic Districts must be designed with the surroundings in mind. The Historic District Commission will not specify a particular architectural style or design for new construction projects. The scale, mass and size of a building are often far more important than the decorative details applied. However, well designed stylistic and decorative elements, as well as building materials and landscaping, can give new construction projects the attributes necessary to blend in with the district, while creating a distinctive character for the building. New construction projects in Local Historic Districts must be appropriate to their surroundings.

The Historic District Commission will review the building details for all new construction as part of their evaluation of new construction project proposals.

**Staff Analysis** - The Commission will determine if the proposal meets the guidelines for garages/new construction.

# SLIDE 30

Charlotte Historic District Commission

August 10, 2016

Application for Certificate of Appropriateness


300 W. Park Ave, Charlotte, NC 28203

The site is a vacant lot located on the corner of W. Park Avenue and Southwood Avenue. The lot is a rectangular lot that measures 50' across the front and back and is 200' deep. Adjacent properties are approximately 30' back from the sidewalk, and are a mix of 1.5 and 2 story craftsman style homes. The materials on the homes in the vicinity of the proposed property are Wood, Cement Fiberboard, and Vinyl.

We are proposing a two story home, with a bonus room in the attic. Placing the bonus room in the attic will add no additional height to the house and will look as if it is only a 2 story home. The home is 32' 7" tall and is comparable to 5 homes on W. Park Avenue. On the rear of the house will be a detached garage that will complement the craftsmen style of the home. The homeowners will use the existing ally drive to access the garage in order to preserve the natural yard-space between the home and the garage. Project details include; Wood windows and trim, Cement fiberboard siding, brick foundation, and brick bases for tapered columns.

*Charlotte Historic District Commission - Case 2016-149*  
**HISTORIC DISTRICT: WILMORE**

**SLIDE 31**

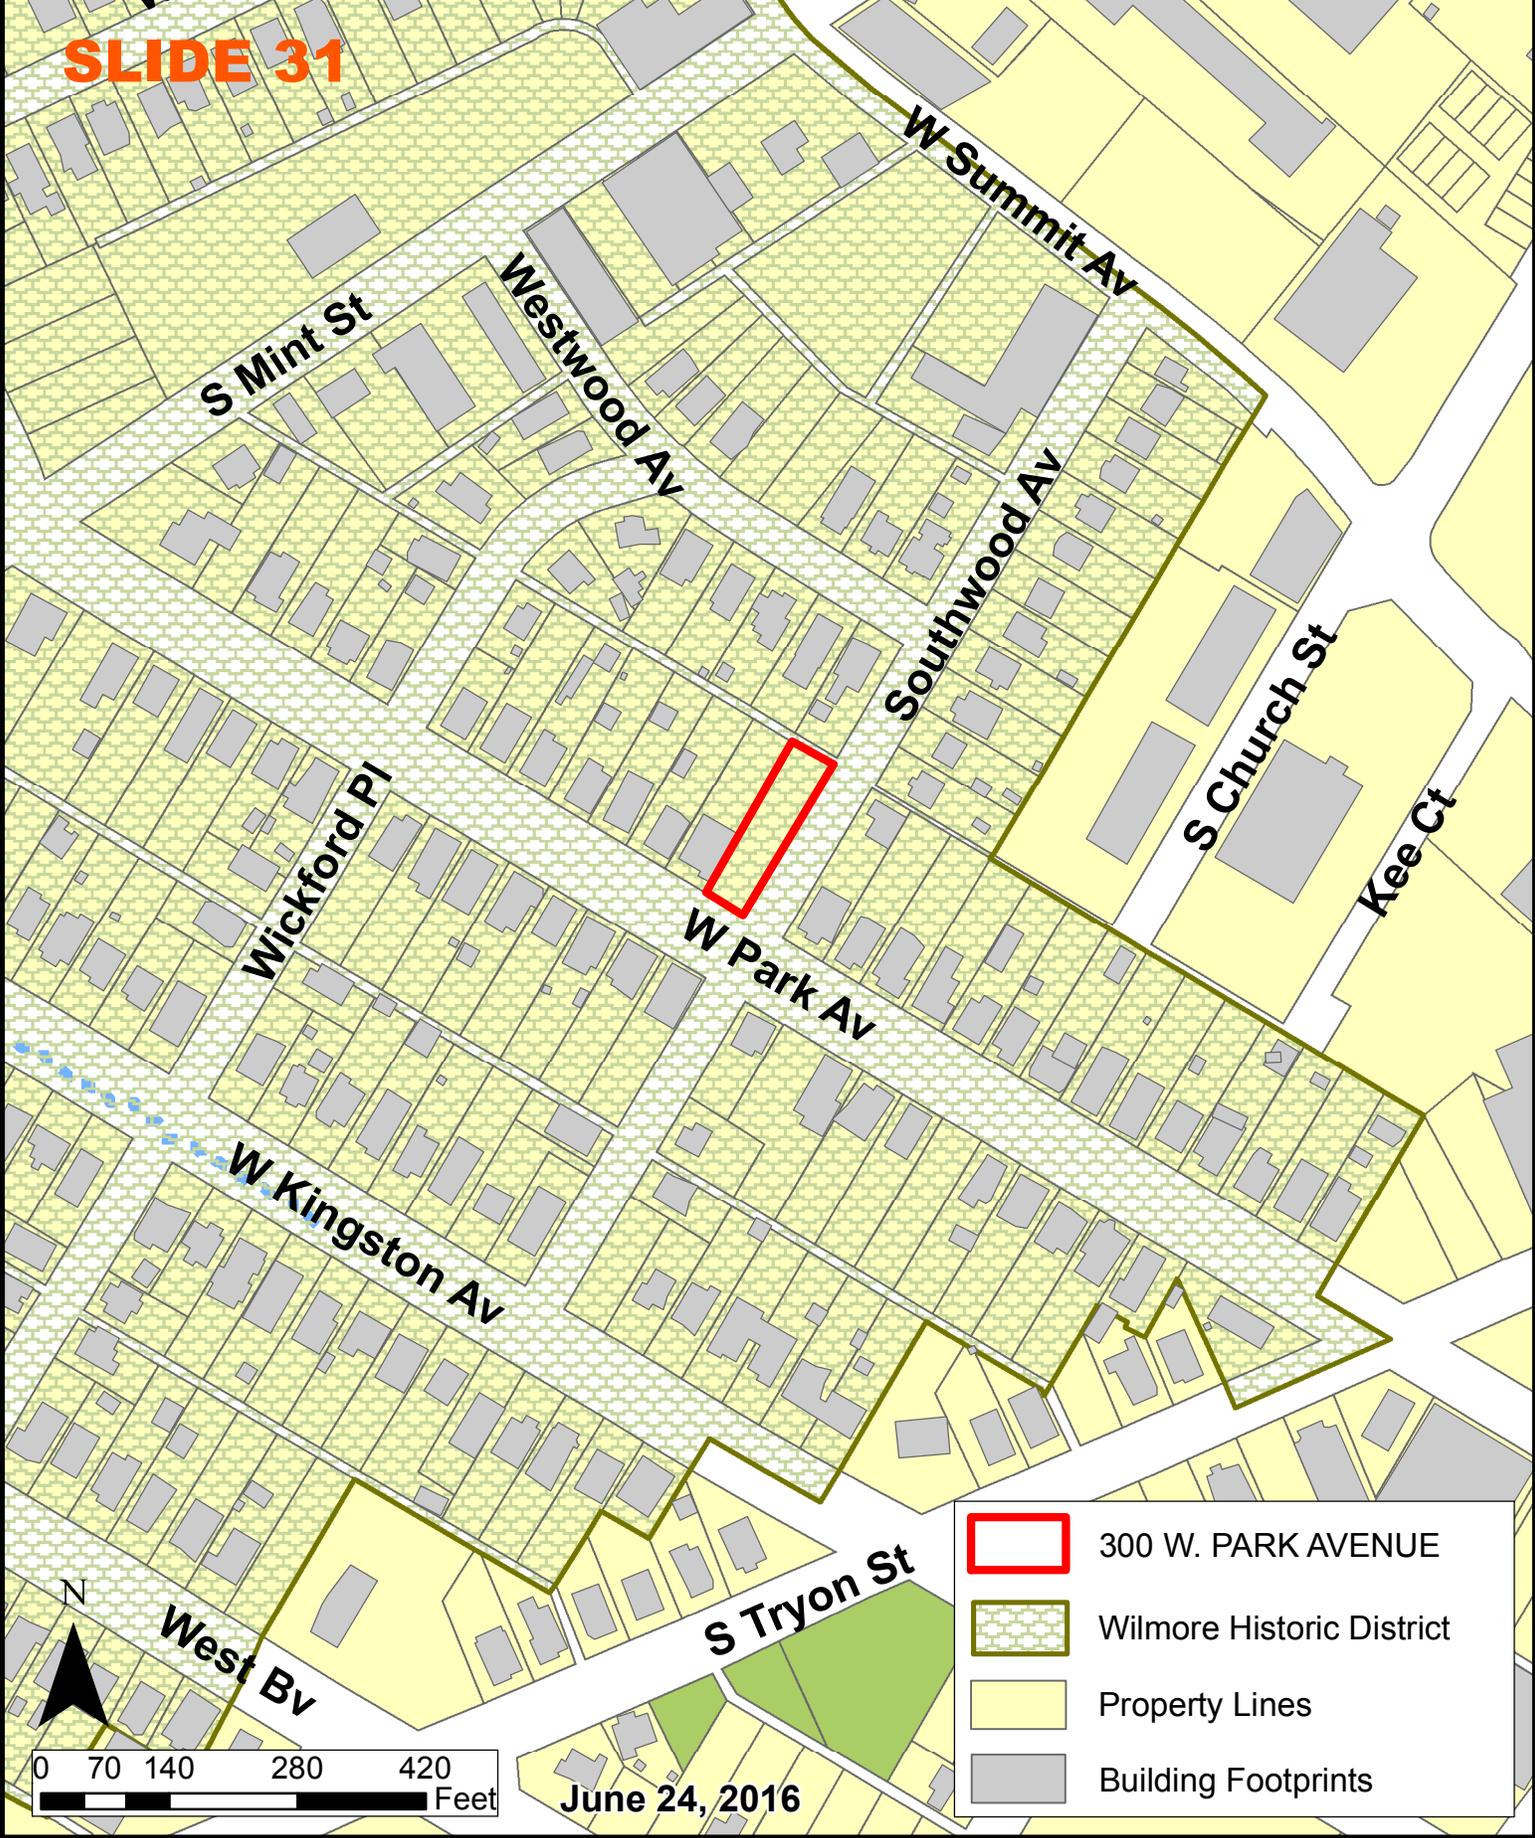

-  300 W. PARK AVENUE
-  Wilmore Historic District
-  Property Lines
-  Building Footprints

0 70 140 280 420 Feet

June 24, 2016

# SLIDE 32



Side View of Lot – 200'



Corner View – Existing Stairs will be kept to maintain historic integrity

# SLIDE 33

Stand at the top of the Stairs looking towards Back of the Property.



Standing on W Park Ave looking at Front of the lot.






# SLIDE 34

## NOTES

1. AREA CALCULATED BY COORDINATE COMPUTATION.
2. ADJOINING PROPERTY OWNERS NAMES WERE TAKEN FROM MECKLENBURG COUNTY TAX OFFICE RECORDS, AND ARE CONSIDERED AS NOW OR FORMERLY.
3. IRON RODS AT ALL CORNERS UNLESS NOTED.
4. THIS MAP IS SUBJECT TO ANY AND ALL APPLICABLE DEED RESTRICTIONS, EASEMENTS, RIGHT-OF-WAY, UTILITIES AND RESTRICTIVE COVENANTS AND PRELIMINARY PLAN WHICH MAY BE OF RECORD.
5. ALL DISTANCES ARE HORIZONTAL GROUND DISTANCES, MEASURED WITH ELECTRONIC MEASURING DEVICES.
6. LOT SUBJECT TO ALL ZONING ORDINANCES OF CITY OF CHARLOTTE. BUILDER/OWNER MUST VERIFY THAT LOT IS IN COMPLIANCE WITH ALL COUNTY AND HOMEOWNERS ASSOCIATION ZONING ORDINANCES PRIOR TO ANY LAND DISTURBANCE OR CONSTRUCTION.
7. THIS SURVEY WAS PERFORMED WITHOUT THE BENEFIT OF A TITLE SEARCH.
8. NO NCGS MONUMENT FOUND WITHIN 2000 FEET.


## LANDSCAPING BED CONSIST OF:

- EDIBLE ORNAMENTAL BLUEBERRY BUSHES
- CREeping THYME
- ROSEMARY
- FERN
- ASTIBLE
- CLIMBING ROSE
- HYDRANGEA
- MIXED ORNAMENTAL GRASSES

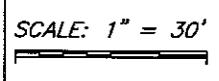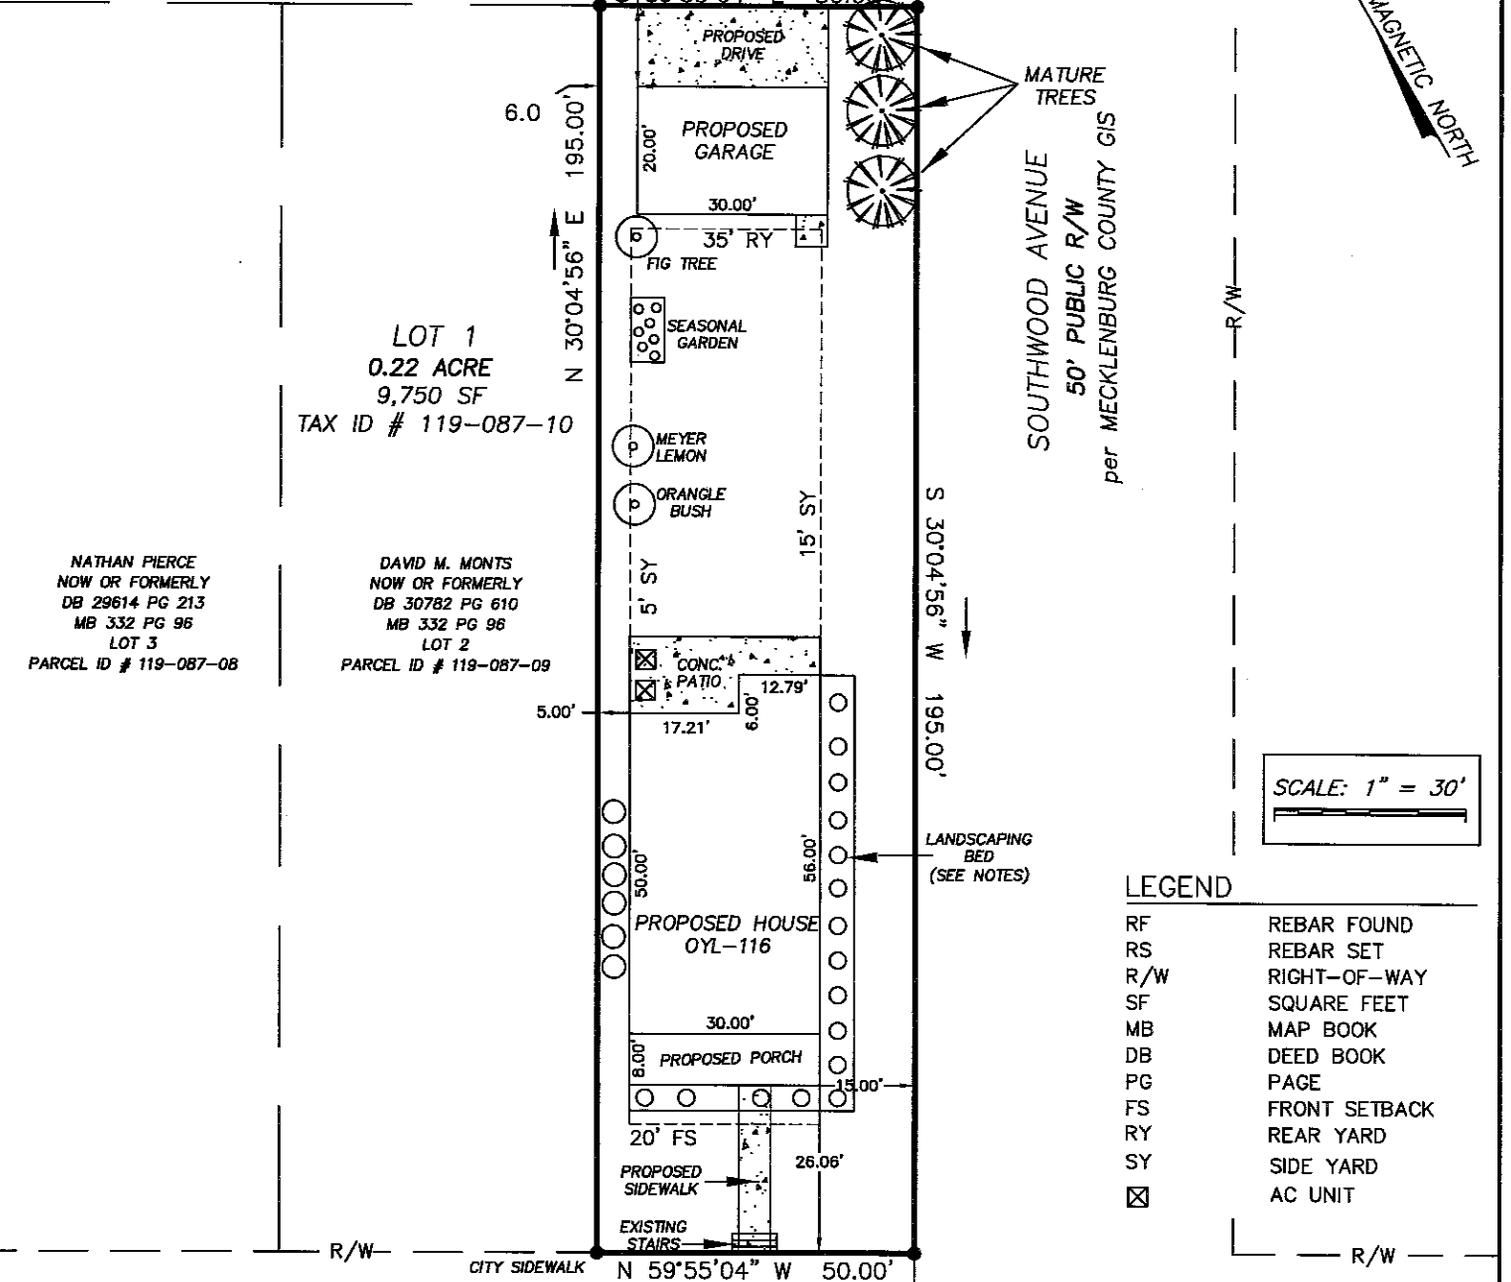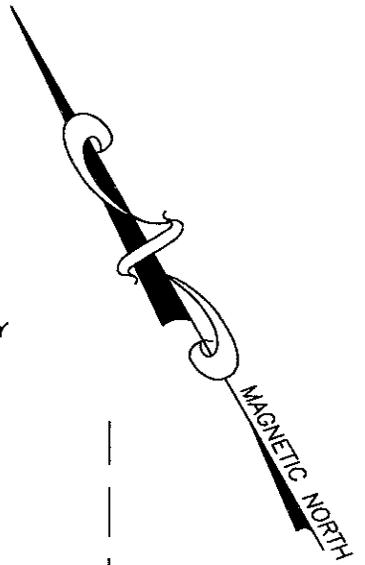

LEGEND	
RF	REBAR FOUND
RS	REBAR SET
R/W	RIGHT-OF-WAY
SF	SQUARE FEET
MB	MAP BOOK
DB	DEED BOOK
PG	PAGE
FS	FRONT SETBACK
RY	REAR YARD
SY	SIDE YARD
☒	AC UNIT

**FLOOD NOTE:**  
NO PORTION OF THE SUBJECT PROPERTY SHOWN HEREON LIES WITHIN A SPECIAL FLOOD HAZARD AREA PER F.E.M.A. FLOOD INSURANCE RATE MAP, COMMUNITY PANEL 3710454300L, DATED: SEPTEMBER 2, 2015.

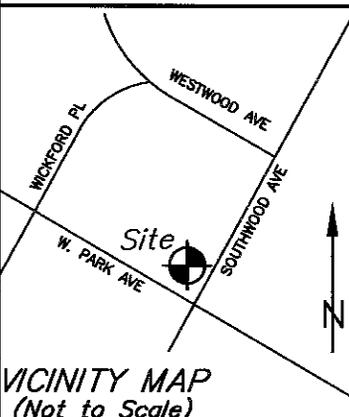

**PLOT PLAN**  
AT PROPERTY KNOWN AS  
# 300 W. PARK AVENUE  
LOT 1, BLOCK 9, WILMORE SUBDIVISION  
PARCEL ID # 119-087-10, MB 332 PG 96, DB 30302 PG 255  
CITY OF CHARLOTTE, MECKLENBURG COUNTY, NC  
FOR  
**TRUE HOMES**



**METROLINA ENGINEERING & SURVEYING ASSOCIATES**

4400-N STUART ANDREW BLVD  
CHARLOTTE, NC 28217  
P (704) 334-1325  
F (704) 334-1330  
NC #C-1170 & SC #C00946

Job No.	011-16-014
Date	6/14/16
Proj. Mgr.	CDF
Drawn	CDF



328 W. Park Av



324 W. Park Av




320 W. Park Av



316 W. Park Av



312 W. Park Av

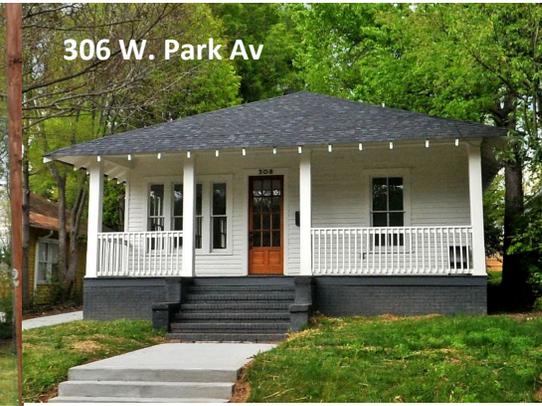

306 W. Park Av



304 W. Park Av

**SLIDE 35**

1) 1557 Wilmore Dr. Wood



2) 1600 Wilmore Dr. Wood



3) 420 W Park Ave. Wood



4) 421 W Park Ave. CFB



5) 412 W Park Ave. Wood



6) 255 W Park Ave. Wood



7) 235 W Park Ave. Wood



8) 245 W Park Ave. Wood



**SLIDE 37**

9) 401 W Kingston Ave. CFB



10) 409 W Kingston Ave. CFB



11) 417 W Kingston Ave. Wood



**SLIDE 38**



1600 Wilmore Dr.  
Wood




1557 Wilmore Dr.  
Wood



255 W Park Ave.  
Wood

\*Please see  
additional  
sheets for  
larger images\*

# SLIDE 39

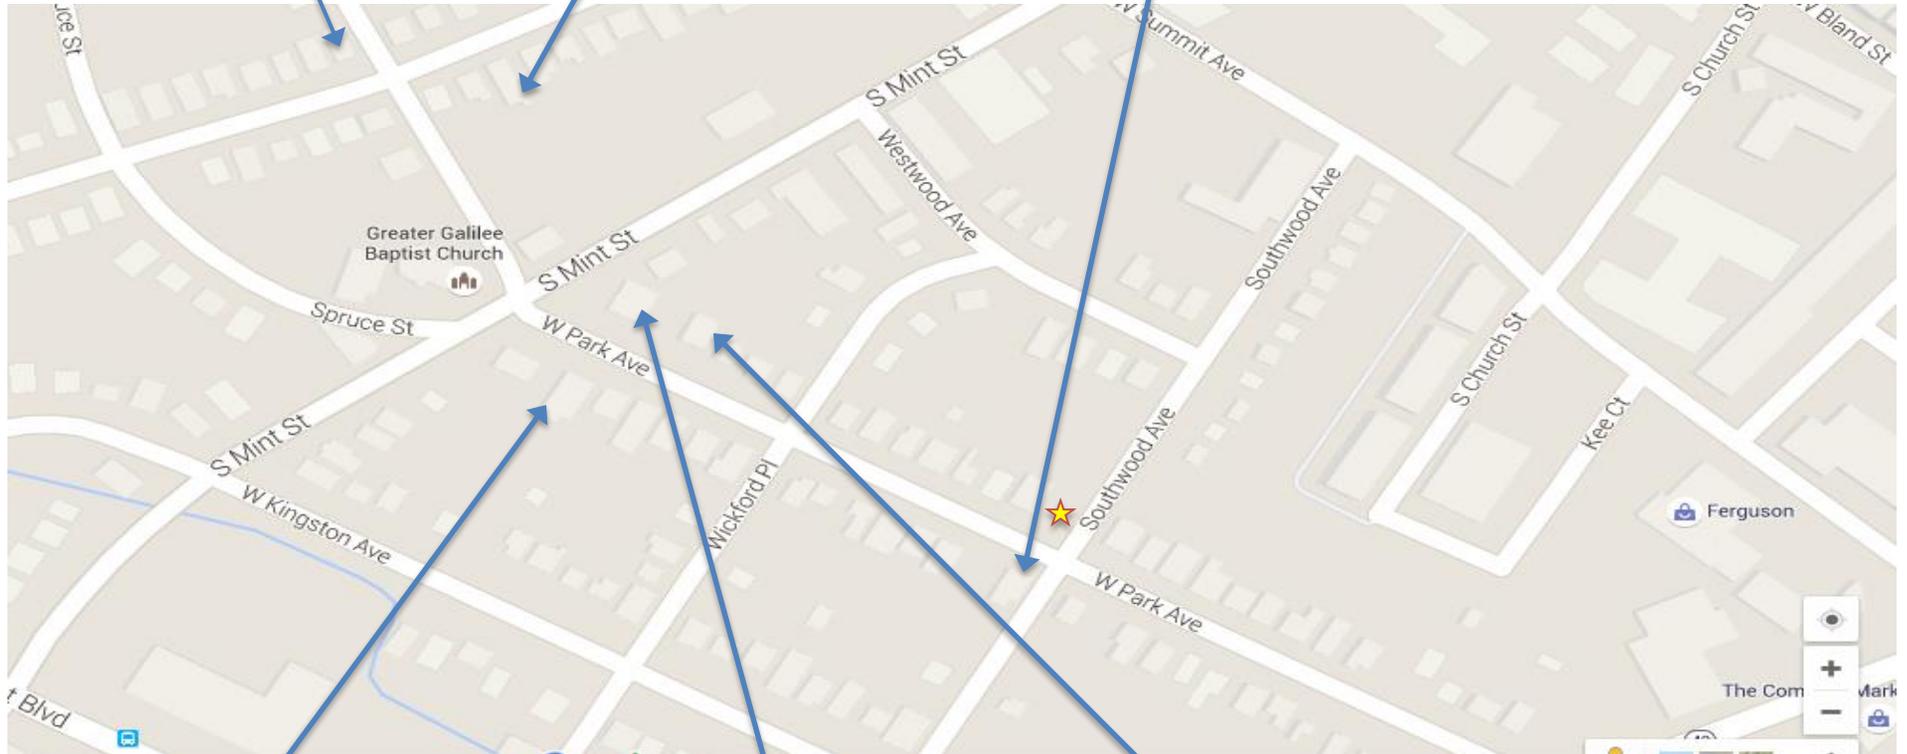

421 W Park Ave.  
CFB



420 W Park Ave.  
Wood



412 W Park Ave.  
Wood

\*Please see additional sheets for larger images\*

# SLIDE 40





417 W Kingston Ave.  
Wood




409 W Kingston Ave.  
CFB



245 W Kingston Ave.  
Wood

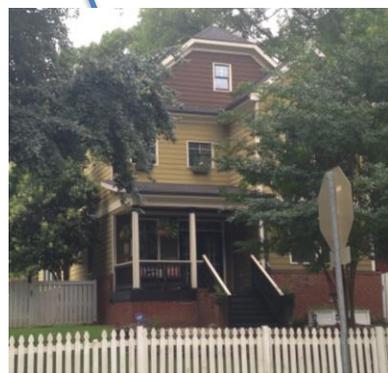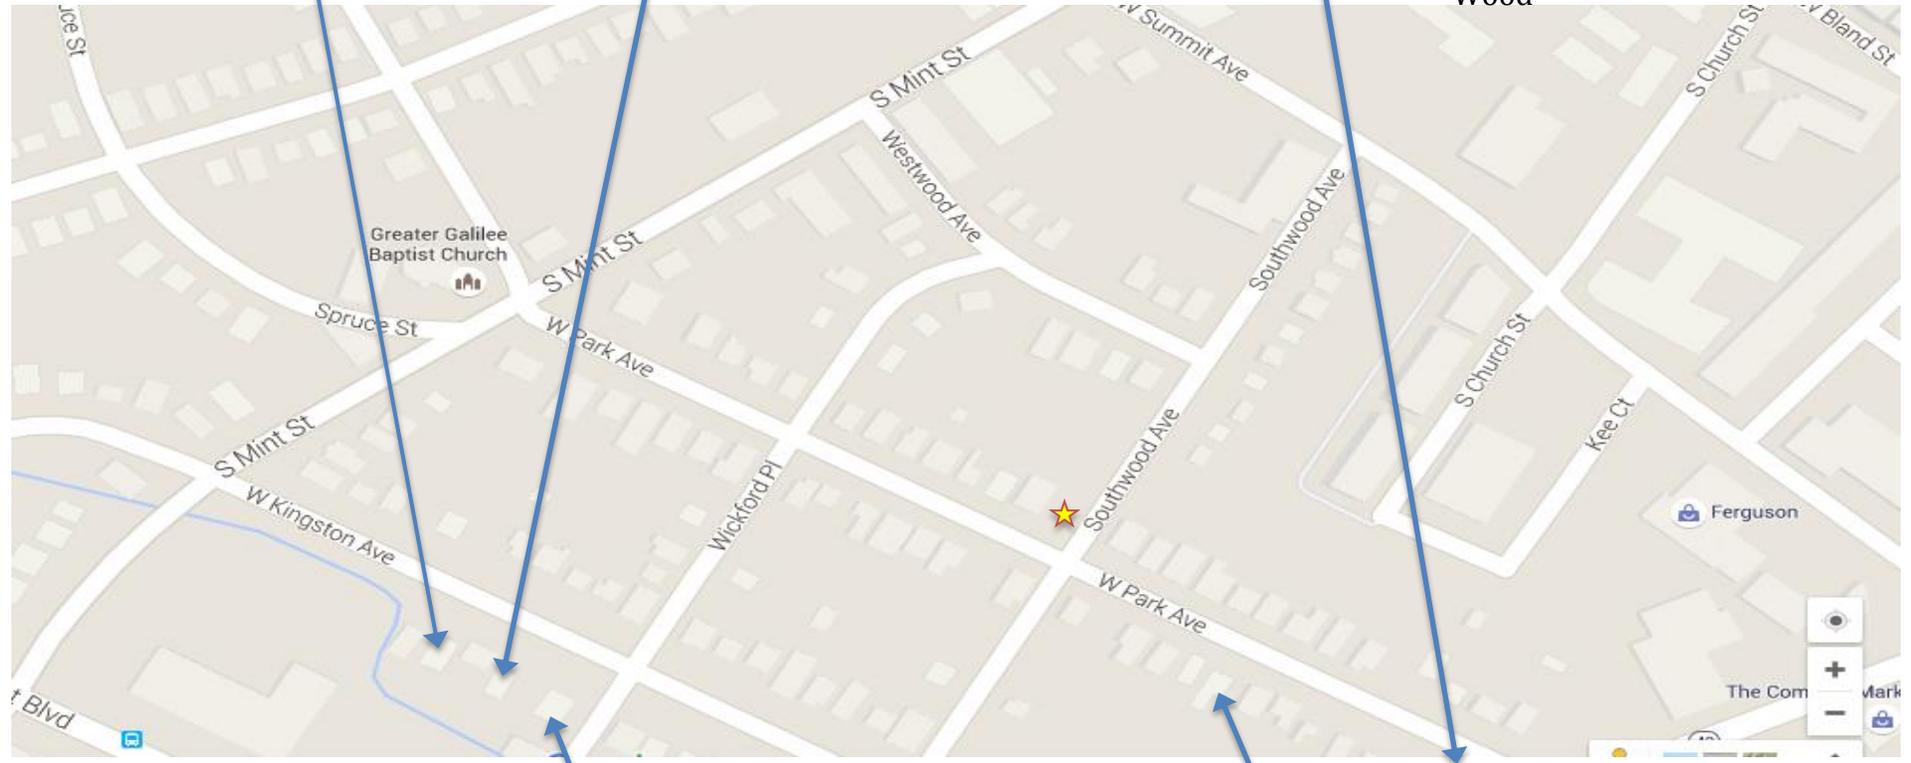

401 W Kingston Ave.  
CFB

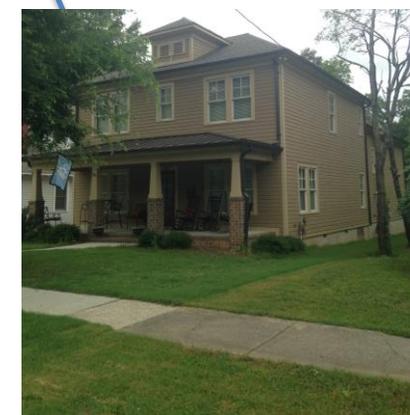

235 W Park Ave.  
Wood

# True Homes

## THE SOMERSET ON YOUR LOT

IT'S ALL ABOUT U

TRADITIONS COLLECTION

**TrueHomes**  
IT'S ALL ABOUT U  
2649 Brekon Ridge Centre Dr.  
Suite 104  
Monroe, N.C. 28110  
704-226-9486

ELECTRICAL LEGEND		GENERAL NOTES				KEY NOTES ELEVATIONS		TABLE OF CONTENTS																																																																										
	EXT. CARRIAGE LIGHT	<p>1. PLANS PERMITTED IN NORTH CAROLINA ARE DESIGNED TO MEET THE 2012 NORTH CAROLINA RESIDENTIAL BUILDING CODE, LATEST EDITION W/SEPT 2013 AMENDMENTS, AS ISSUED BY THE STATE OF NORTH CAROLINA, AND PLANS PERMITTED IN SOUTH CAROLINA DESIGNED TO MEET 2015 INTERNATIONAL RESIDENTIAL BUILDING CODE AS ISSUED BY THE STATE OF SOUTH CAROLINA, WITH MODIFICATIONS AS REQUIRED TO MEET LOCAL BUILDING CODES FOR EACH APPLICABLE JURISDICTION.</p> <p>2. DO NOT SCALE DIMENSIONS FROM PRINTS. USE DIMENSIONS GIVEN OR CONSULT PRODUCTION CAD DEPARTMENT FOR FURTHER CLARIFICATION.</p> <p>3. ALL DIMENSIONS ARE FROM WALL FRAMING, NO FINISHED DIMENSIONS ARE GIVEN.</p> <p>4. PROVIDE 2 STUDS BETWEEN ALL WINDOWS.</p> <p>5. ACCESS DOORS BETWEEN HOUSE AND GARAGE AREAS TO BE 20-MINUTE FIRE RATED.</p>		<p>6. ALL EXTERIOR WALLS &amp; INTERIOR WALLS TO BE 2X4 STUDS 16" O.C. UNLESS NOTED OTHERWISE.</p> <p>7. ALL STRUCTURAL FRAMING LUMBER EXPOSED DIRECTLY TO THE WEATHER OR BEARING DIRECTLY ON MASONRY OR CONCRETE SHALL BE TREATED. ALL WOOD IN CONTACT WITH THE GROUND MUST BE GROUND-CONTACT APPROVED. ALL WOOD EXPOSED DIRECTLY TO THE WEATHER SHALL BE PROTECTED TO PREVENT THE OCCURRENCE OF ROT.</p> <p>8. ALL ANGLED WALLS ARE AT 45 DEGREES UNLESS NOTED OTHERWISE.</p> <p>9. WINDOWS ARE LABELED AS NOMINAL SIZES. SEE SELECTIONS AND ROUGH OPENING SCHEDULES FOR FRAMING SIZES. SEE ELEVATION PLAN FOR WINDOW HEADER HEIGHTS.</p> <p>10. DIMENSIONS ARE FROM FACE OF STUDS.</p> <p>11. PROVIDE BLOCKING ABOVE WINDOWS AND DOORS 16" O.C.</p> <p>12. PROVIDE EXTRA STUDS AS INDICATED AT BEAM BEARING LOCATIONS.</p>		<p>MEETING THE REQUIREMENTS OF ALL GOVERNING CODES AND PER MANUFACTURER SPECS.</p> <p>18. STAIR TREAD DESIGN TO BE VERIFIED WITH SELECTIONS AND POS.</p> <p>19. PROVIDE 1 1/2" FLAT WALL FRAMING FOR ALL HVAC CHASES UNLESS NOTED OTHERWISE. SEE FRAMING SHEETS/CS2 FOR ADDITIONAL NOTES PER LOCAL CODES.</p> <p>20. FOR TRADITIONS, ELEMENTS, INTEGRITY, AND TRIBUTE SERIES, DOORS SHOULD BE LOCATED 4" OFF ADJACENT WALLS OR CENTERED IN THE WALL UNLESS NOTED OTHERWISE. DESIGNER SERIES SHOULD BE LOCATED 6" OFF ADJACENT WALLS OR CENTERED IN THE WALL UNLESS NOTED OTHERWISE.</p> <p>21. ALL HOMES TREATED WITH BORA-CARE TERMITE TREATMENT.</p>		<p>CS COVER SHEET</p> <p>A2.1 FIRST FLOOR PLAN</p> <p>A2.2 SECOND FLOOR PLAN</p> <p>A3.1 FRONT &amp; REAR ELEVATIONS</p> <p>A3.2 LEFT &amp; RIGHT ELEVATIONS</p> <p>A4.1 STAIR SECTIONS</p> <p>E1.1 FIRST FLOOR ELECTRICAL PLAN</p> <p>E1.2 SECOND FLOOR ELECTRICAL PLAN</p> <p>S1 FOUNDATION PLAN</p> <p>S2.1 FIRST FLOOR FRAMING</p> <p>S2.2 FIRST FLOOR BRACED WALLS</p> <p>S3.1 ROOF FRAMING PLAN</p> <p>S3.2 SECOND FLOOR BRACED WALLS</p> <p>GN GENERAL STRUCTURAL NOTES</p> <p>AN AREA NOTES</p> <p>D1 TYP. FOUNDATION DETAILS</p> <p>D1.1 TYP. HOLDOWN DETAILS</p> <p>D2 TYP FRAMING DETAILS</p> <p>D2.2 TYP FRAMING DETAILS</p> <p>D2.3 TYP FRAMING DETAILS</p> <p>D2.4 TYP FRAMING DETAILS</p> <p>D3 TYP FLASHING DETAIL</p> <p>D4 TYP. PORTAL FRAME DETAIL - PFFH</p> <p>D4.1 TYP. UL RATED WALL @ PROPERTY LINE</p> <p>D5 TYP FIREPLACE DETAILS</p> <p>D5.1 TYP STAIR DETAILS</p> <p>D6 TYP SCREEN PORCH DETAILS</p> <p>D7 TYP. DECK DETAILS</p> <p>D8 TYP WALL FRAMING DETAILS</p> <p>D9 TYP CORNICE DETAILS</p> <p>D10 TRIM DETAILS</p>																																																																										
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<p><b>INTERIOR PASS THRU SCHEDULE</b></p> <table border="1"> <thead> <tr> <th colspan="3">FRAMED OPENING DIMENSIONS</th> </tr> <tr> <th>WALL HEIGHT</th> <th>R.O. WIDTH</th> <th>R.O. HEIGHT</th> </tr> </thead> <tbody> <tr> <td>8'-1 1/8"</td> <td>PLAN I.D. +2"</td> <td>82-1/2"</td> </tr> <tr> <td>9'-1 1/8"</td> <td>PLAN I.D. +2"</td> <td>94-1/2"</td> </tr> <tr> <td>10'-1 1/8"</td> <td>PLAN I.D. +2"</td> <td>98-1/2"</td> </tr> </tbody> </table> <p>ROUGH OPENING HEIGHTS ARE FOR DO, CO, &amp; AO OPENINGS. SHIM HEIGHTS AS NEEDED TO MATCH INTERIOR HINGED DOOR CASING</p> <p><b>INTERIOR DOORWAY OPENINGS:</b> DO = DRYWALL OPENING CO = CASER OPENING AO = ARCHER OPENING</p>		FRAMED OPENING DIMENSIONS			WALL HEIGHT	R.O. WIDTH	R.O. HEIGHT	8'-1 1/8"	PLAN I.D. +2"	82-1/2"	9'-1 1/8"	PLAN I.D. +2"	94-1/2"	10'-1 1/8"	PLAN I.D. +2"	98-1/2"	<p><b>POST SCHEDULE</b></p> <table border="1"> <thead> <tr> <th>2x4 STUDS</th> <th>2x6 STUDS</th> </tr> </thead> <tbody> <tr> <td></td> <td></td> </tr> <tr> <td>NUMBER INSIDE CALLOUT INDICATES TOTAL NUMBER OF STUDS.</td> <td></td> </tr> <tr> <td></td> <td></td> </tr> <tr> <td>LETTER 'P' INSIDE CALLOUT INDICATES A SOLID 4x4 or 6x6 POST</td> <td></td> </tr> </tbody> </table>		2x4 STUDS	2x6 STUDS			NUMBER INSIDE CALLOUT INDICATES TOTAL NUMBER OF STUDS.				LETTER 'P' INSIDE CALLOUT INDICATES A SOLID 4x4 or 6x6 POST		<h1>SLIDE 41</h1>																																																					
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<p><b>REVISION LOG</b></p> <table border="1"> <tbody> <tr> <td>1. DATE:</td> <td>DRAWN BY:</td> </tr> <tr> <td>2. DATE:</td> <td>DRAWN BY:</td> </tr> <tr> <td>3. DATE:</td> <td>DRAWN BY:</td> </tr> </tbody> </table>		1. DATE:	DRAWN BY:	2. DATE:	DRAWN BY:	3. DATE:	DRAWN BY:																																																																											
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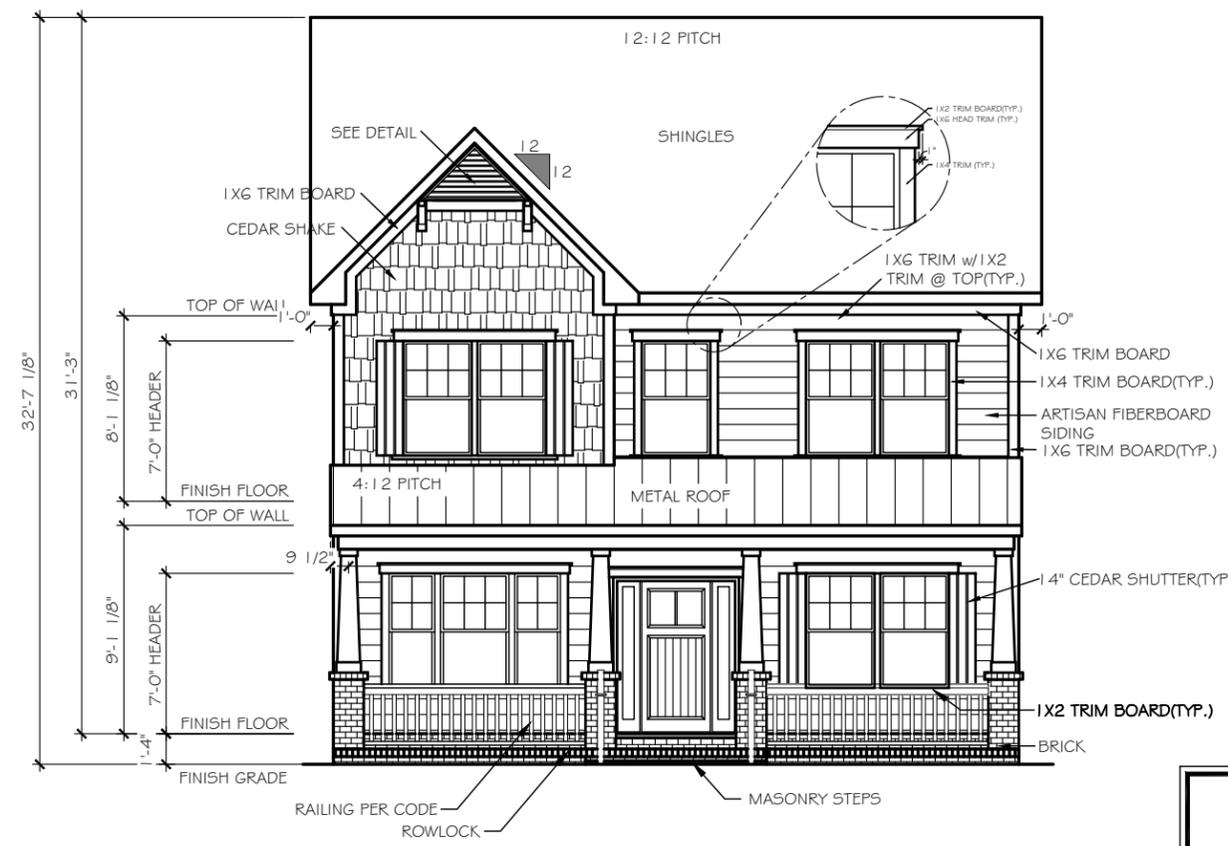
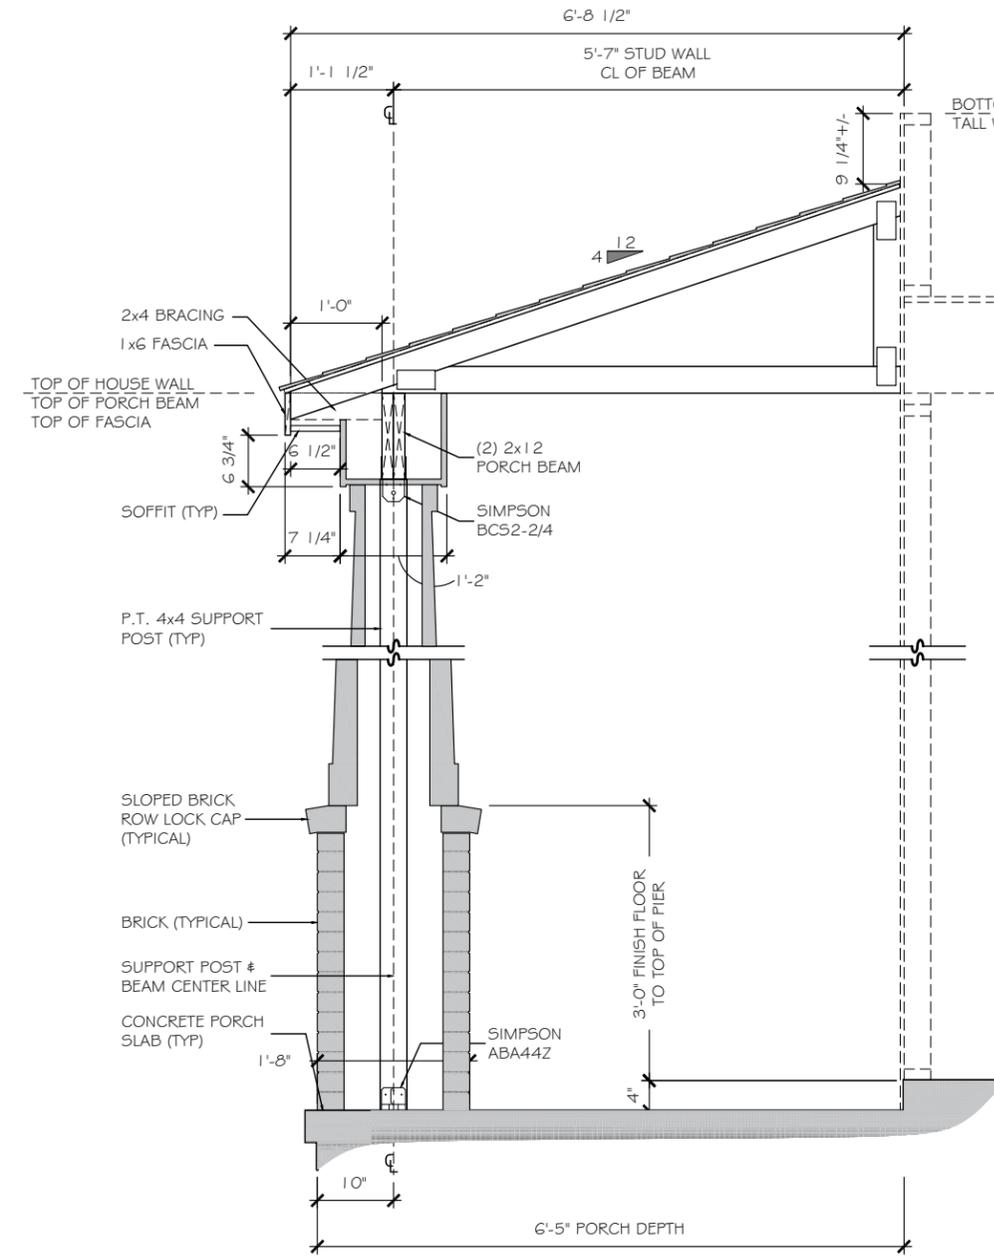
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CHECKED BY: INITIALS

SHEET: CS


# SLIDE 42



**FRONT ELEVATION**

KEY NOTES ELEVATIONS	
(101)	CORNER TRIM
(103)	FLUSH RAKE
(105)	HORIZONTAL SIDING
(107)	BOARD-N-BATTEN SIDING
(108)	SCALLOPED SIDING
(109)	SHAKE SIDING
(111)	COMPOSITE SHINGLES
(112)	METAL ROOFING
(113)	SHINGLED RETURN
(114)	SUBFASCIA
(115)	FLASHING
(117)	VINYL SHUTTER
(119)	TRIM BOARD AT OVERHEAD DOOR JAMB
(120)	BRICKMOLD TRIM
(121)	1X4 TRIM BOARD
(123)	1X6 TRIM BOARD
(125)	1X8 TRIM BOARD
(126)	SYNTHETIC CROSS HEAD
(127)	1X4 FRIEZE TRIM BOARD
(129)	1X6 SPRUCE FASCIA W/ COIL WRAP & VINYL SOFFIT
(131)	1-1/2" THICK STONE CAP
(133)	5" FACE BRICK VENEER
(135)	ROWLOCK SILL
(137)	BRICK JACK ARCH
(139)	SOLDIER COURSE
(141)	PRECAST KEYSTONE
(143)	THIN-SET STONE VENEER

1x4 TRIM WHERE SHOWN AT WINDOWS AND DOORS UNLESS OTHERWISE NOTED

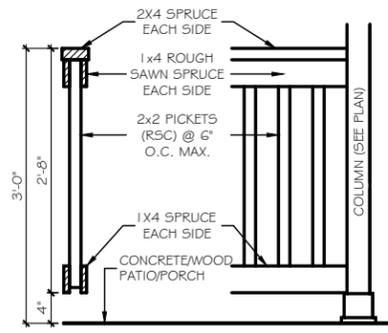


**7.1 EXTERIOR RAILING**  
SCALE: 3/8" = 1'-0"




**REAR ELEVATION**

SCALE: 1/8" = 1'-0"

**20" BRICK PIER/16" TAPERED COLUMN (6'-5" PORCH DEPTH)**  
SCALE: 1/2" = 1'-0"

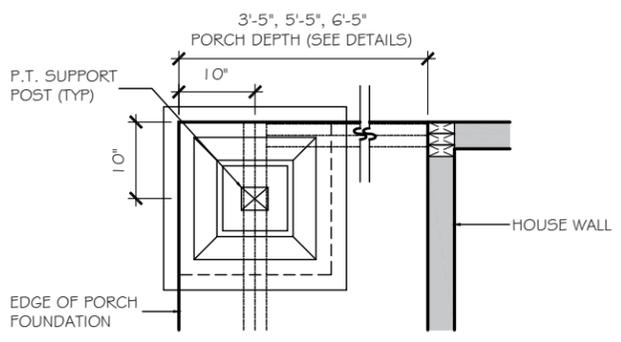

**16" TAPERED COLUMN ON 20" SQ. PEDESTAL (STONE/BRICK)**  
SCALE: 1/2" = 1'-0"

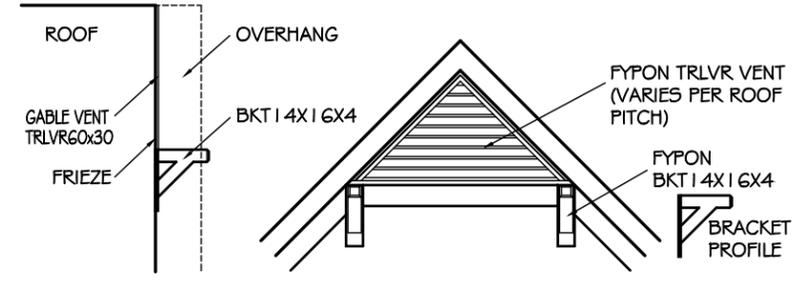

**DECORATIVE GABLE BRACKET DETAIL I**

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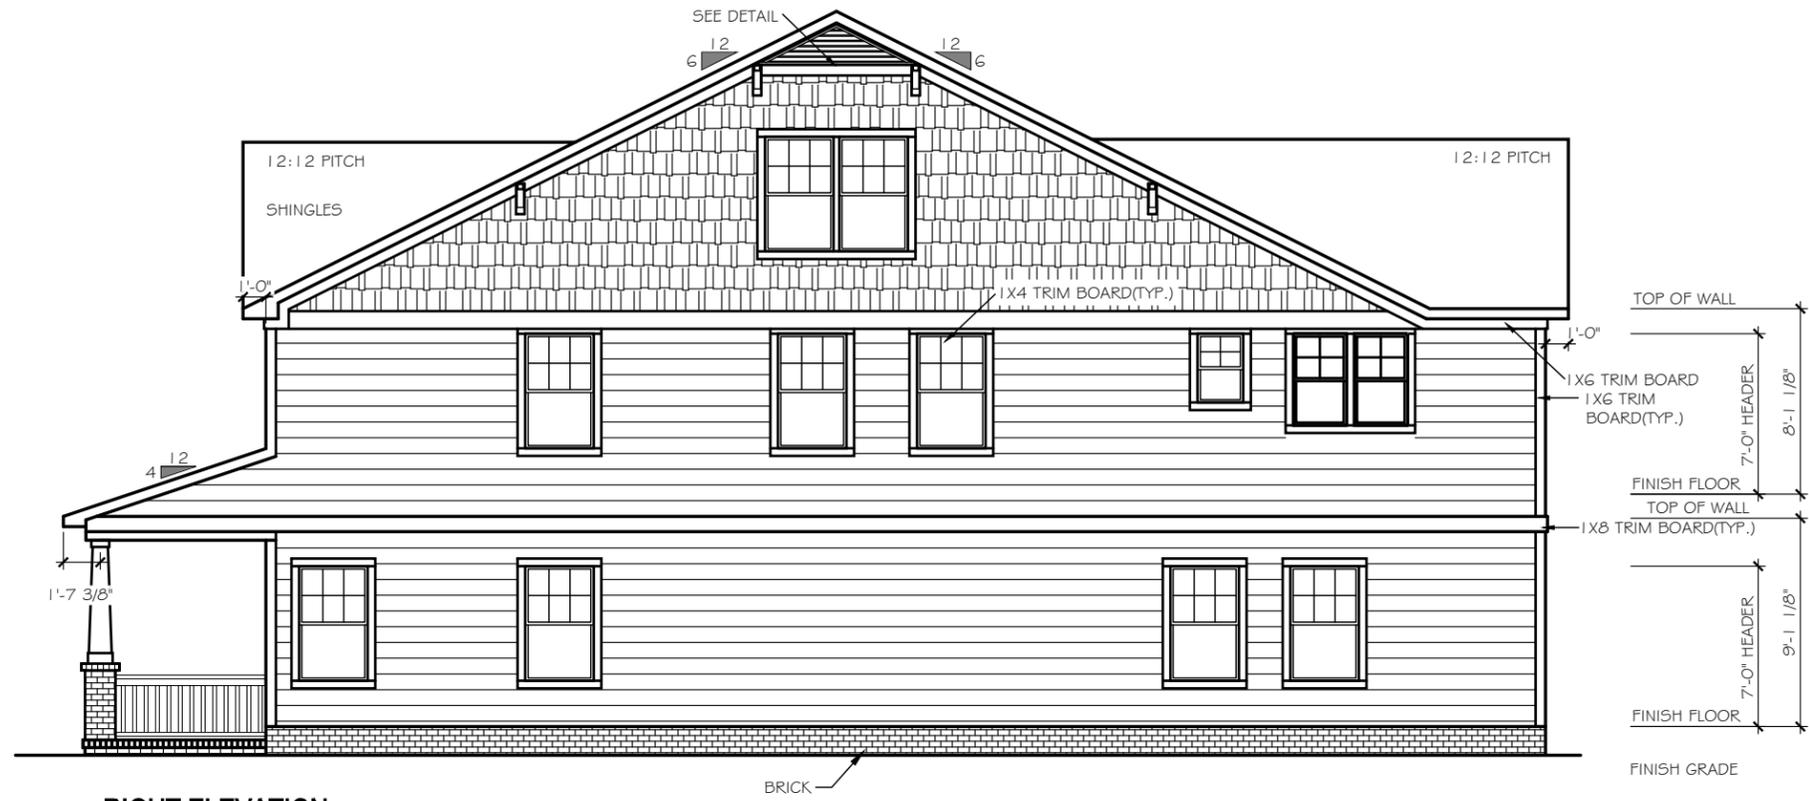
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SHEET:  
**A3.1**

1x4 TRIM WHERE SHOWN AT  
WINDOWS AND DOORS UNLESS  
OTHERWISE NOTED



**RIGHT ELEVATION**  
SCALE: 1/8" = 1'-0"

KEY NOTES ELEVATIONS	
(01)	CORNER TRIM
(03)	FLUSH RAKE
(05)	HORIZONTAL SIDING
(07)	BOARD-N-BATTEN SIDING
(08)	SCALLOPED SIDING
(09)	SHAKE SIDING
(11)	COMPOSITE SHINGLES
(12)	METAL ROOFING
(13)	SHINGLED RETURN
(14)	SUBFASCIA
(15)	FLASHING
(17)	VINYL SHUTTER
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(26)	SYNTHETIC CROSS HEAD
(27)	1X4 FRIEZE TRIM BOARD
(29)	1X6" SPRUCE FASCIA W/ COIL WRAP & VINYL SOFFIT
(31)	1-1/2" THICK STONE CAP
(33)	5" FACE BRICK VENEER
(35)	ROWLOCK SILL
(37)	BRICK JACK ARCH
(39)	SOLDIER COURSE
(41)	PRECAST KEYSTONE
(43)	THIN-SET STONE VENEER



**LEFT ELEVATION**  
SCALE: 1/8" = 1'-0"

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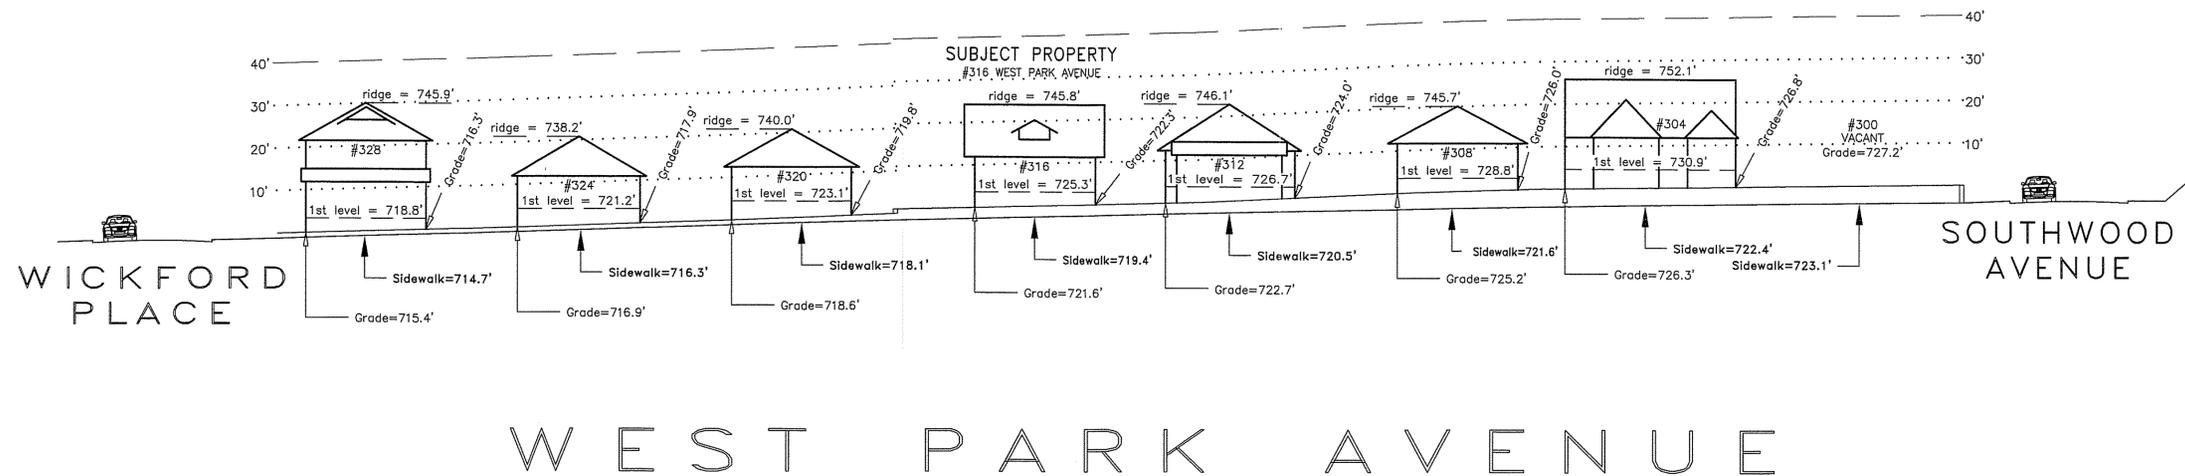
SHEET:  
**A3.2**

I hereby certify that this schematic drawing was prepared based on field-surveyed elevation measurements of the points shown hereon. This map is not intended to meet G.S. 47-30 recording requirements.

This 5<sup>th</sup> day of March, 2015.




*A.G.Z.*  
Andrew G. Zoutewelle  
Professional Land Surveyor  
NC License No. L-3098



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**SURVEYORS**  
1418 East Fifth St. Charlotte, NC 28204  
Phone: 704-372-9444 Fax: 704-372-9555  
Firm Licensure Number C-1054

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Building Heights Sketch of  
**300 BLOCK of WEST PARK AVENUE**  
**FACING NORTHEAST**  
CHARLOTTE, MECKLENBURG COUNTY, N.C.  
for Charlotte-Mecklenburg Planning Department  
March 04, 2015

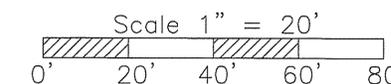


General Notes:  
1. The purpose of this Building Heights Sketch is to show existing building facade heights relative to the elevation points at the public sidewalk, front yard grade ("Grade"), 1st level, and ridgeline of the houses depicted hereon. No rearyard or sideyard measurements were made. The heights shown hereon were derived from indirect measurements and are not intended for structural design.  
2. The vertical datum for these elevation measurements is the North American Vertical Datum of 1988 (i.e., sea level). All other information and graphics are conceptual in nature and are not intended to represent accurate architectural or landscape features.

I hereby certify that this schematic drawing was prepared based on field-surveyed elevation measurements of the points shown hereon. This map is not intended to meet G.S. 47-30 recording requirements.

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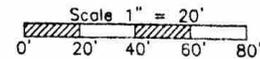
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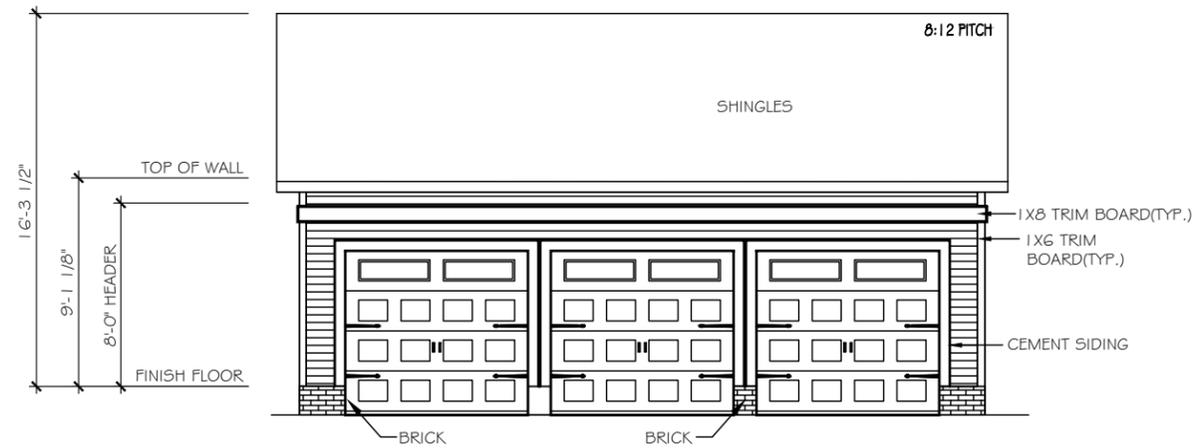


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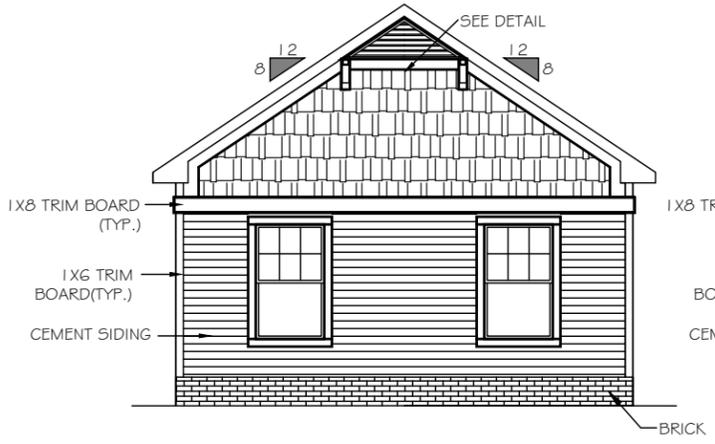
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**300 BLOCK of WEST PARK AVENUE**  
**FACING NORTHEAST**  
CHARLOTTE, MECKLENBURG COUNTY, N.C.  
for Charlotte-Mecklenburg Planning Department  
March 04, 2015

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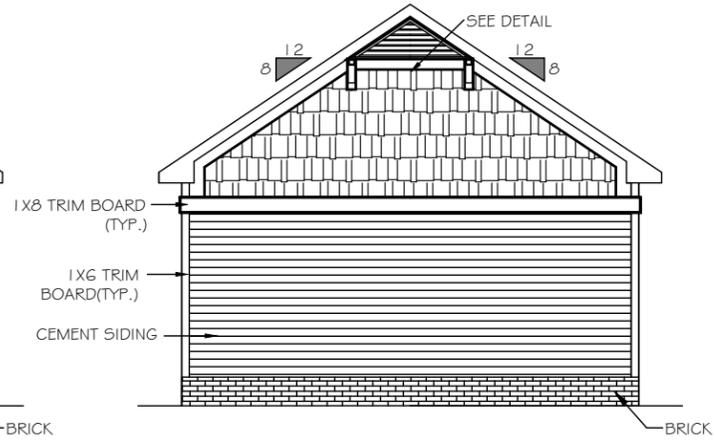


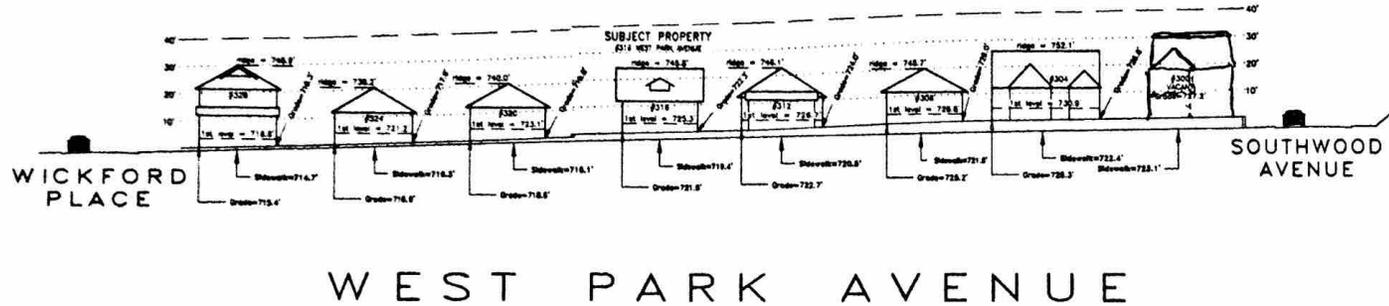


**FRONT ELEVATION**  
SCALE: 1/8" = 1'-0"



**LEFT ELEVATION**  
SCALE: 1/8" = 1'-0"



**RIGHT ELEVATION**  
SCALE: 1/8" = 1'-0"

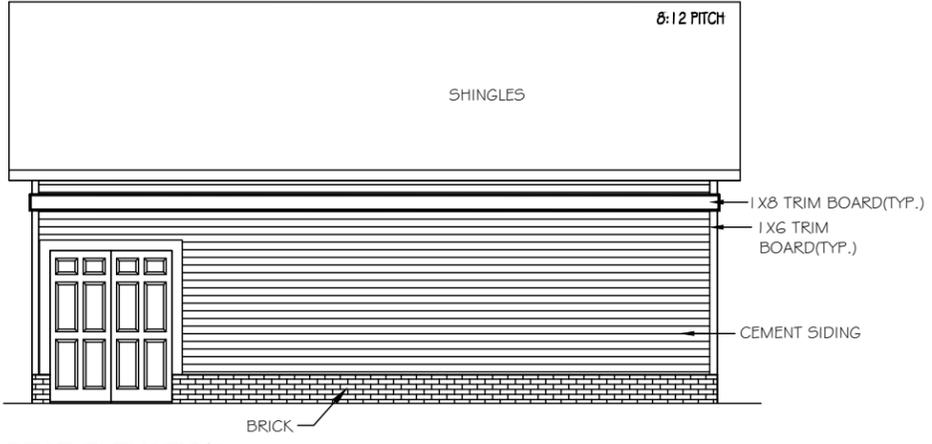

**REAR ELEVATION**  
SCALE: 1/8" = 1'-0"

KEY NOTES ELEVATIONS	
01	CORNER TRIM
03	FLUSH RAKE
05	HORIZONTAL SIDING
07	BOARD-N-BATTEN SIDING
08	SCALLOPED SIDING
09	SHAKE SIDING
11	COMPOSITE SHINGLES
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14	SUBFASCIA
15	FLASHING
17	VINYL SHUTTER
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37	BRICK JACK ARCH
39	SOLDIER COURSE
41	PRECAST KEYSTONE
43	THIN-SET STONE VENEER

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SHEET:  
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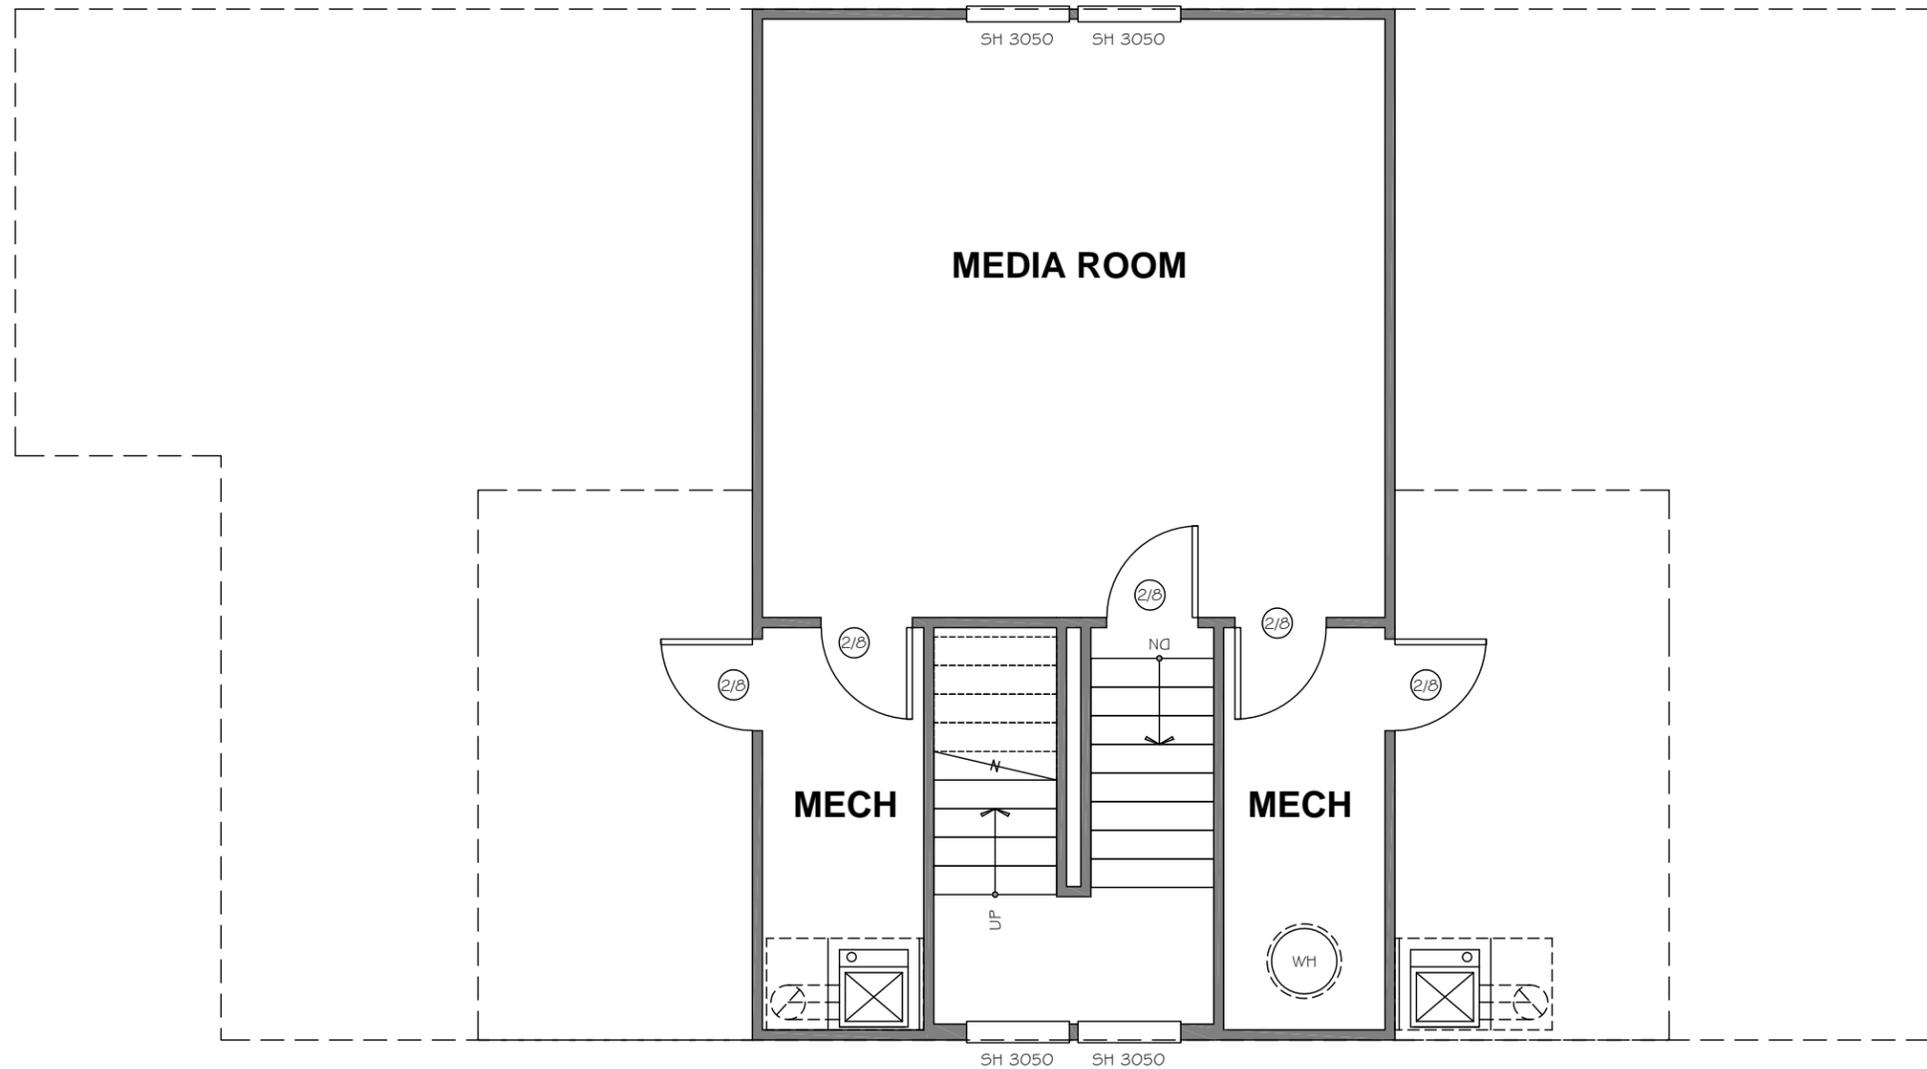
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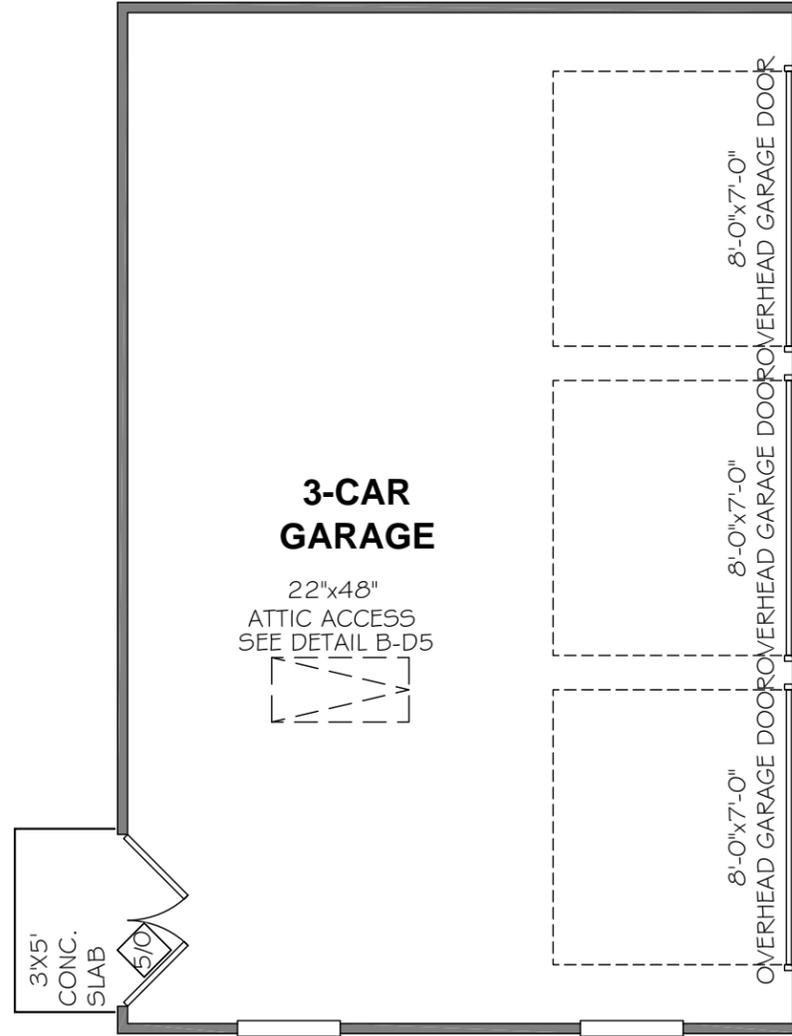
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SHEET:  
**A2.4**



Monroe Ga. 770-267-4622 800-899-1739

Albany Ga. 229-432-2322 866-432-2822

## Standard Features



**1. 6/4" pine sash for strength, durability, insulating qualities and historically accurate look.**

**2. Treated with WoodLife®111 water repellent and wood preservative for long life.**

**3. Exteriors are factory-primed and ready for painting.**

**4. Thicker mortise and tenon joint. (Resists cracking)**

**5. Deeper shoulder for thicker S.D.L. bar.**

**6. Natural wood interiors ready for painting or staining.**

**7. Continuous routed finger lift for easy operation.**

**8. Sash screwed together with 2-1/4" screws for strength, durability and cleaner look. (No staple holes in face of sash)**

**9. Boot Glazed, reglazable in minutes, cuts down stress cracks.**

**10. Sash and Boot with weep holes to get condensation out of sash for long life**

**11. 11/16" Cardinal High-Performance LoE-270 insulating glass with 1/2" air space.**

**12. Foam-filled bulb weather stripping with three adjustments for a weather tight fit.**

**13. Dual action sash lock with adjustable keeper. Security and enhanced performance.**

**14. Insulated jamb-liners with spring covers, bridged back and adjustable springs. Smooth raise/lower and weather tight fit.**

**15. Tilt-in removable top and bottom sash for easy cleaning.**

**16. One piece 4-9/16" jambs for better strength and performance. (Not pieced together)**

**17. Low-maintenance rot-proof, sill, blind stop and brickmould.**

**18. Brickmould grooved for easy screen installation.**

**19. Double-hung windows designed to be factory-combined with other Tucker Door products. (Transom, Elliptical, Segment and Round-Top windows)**





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Albany Ga. 229-432-2322 866-432-2822

# Let The Beauty Of The World In While Keeping Mother Nature Out! Cold, Heat, Rain and Harmful UV Radiation




## Optional Features

- All Natural Pine exterior and interior for staining inside and out.
- White or tan colored jamb-liners.  
White or bronze sash locks.
- S.D.L Options 7/8" 1-1/8" and 7/8" Putty Bars
- G.B.G Bars
- Factory-applied exterior casing. 5/4x4 flat casing, 5/4x6 flat casing, 1x4 backband.
- Factory-applied extension jambs.
- Cardinal Glass LoE-366, (LoE-240 Glare Control) all available with Argon gas.
- Custom sizes.

## Sash Replacment

- Improve Energy Efficiency While updating Your Curb Appeal.
- Easy Installation. Sash kit takes about 20 minutes to install

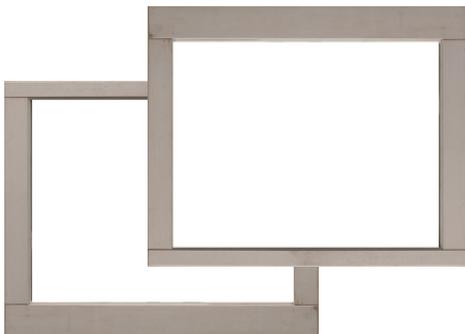

## Performance Data

	U Value	SHGC	VLТ	CR
LOW-E	0.33	0.27	0.51	54
LOW-E Argon	0.30	0.27	0.51	57

(6-24-10SJSН)